


# TOWN OF TRUMBULL

## WINDOW REPLACEMENT AND ENTRANCES AT:

# JANE RYAN ELEMENTARY SCHOOL

190 PARK LANE  
TRUMBULL, CONNECTICUT 06611

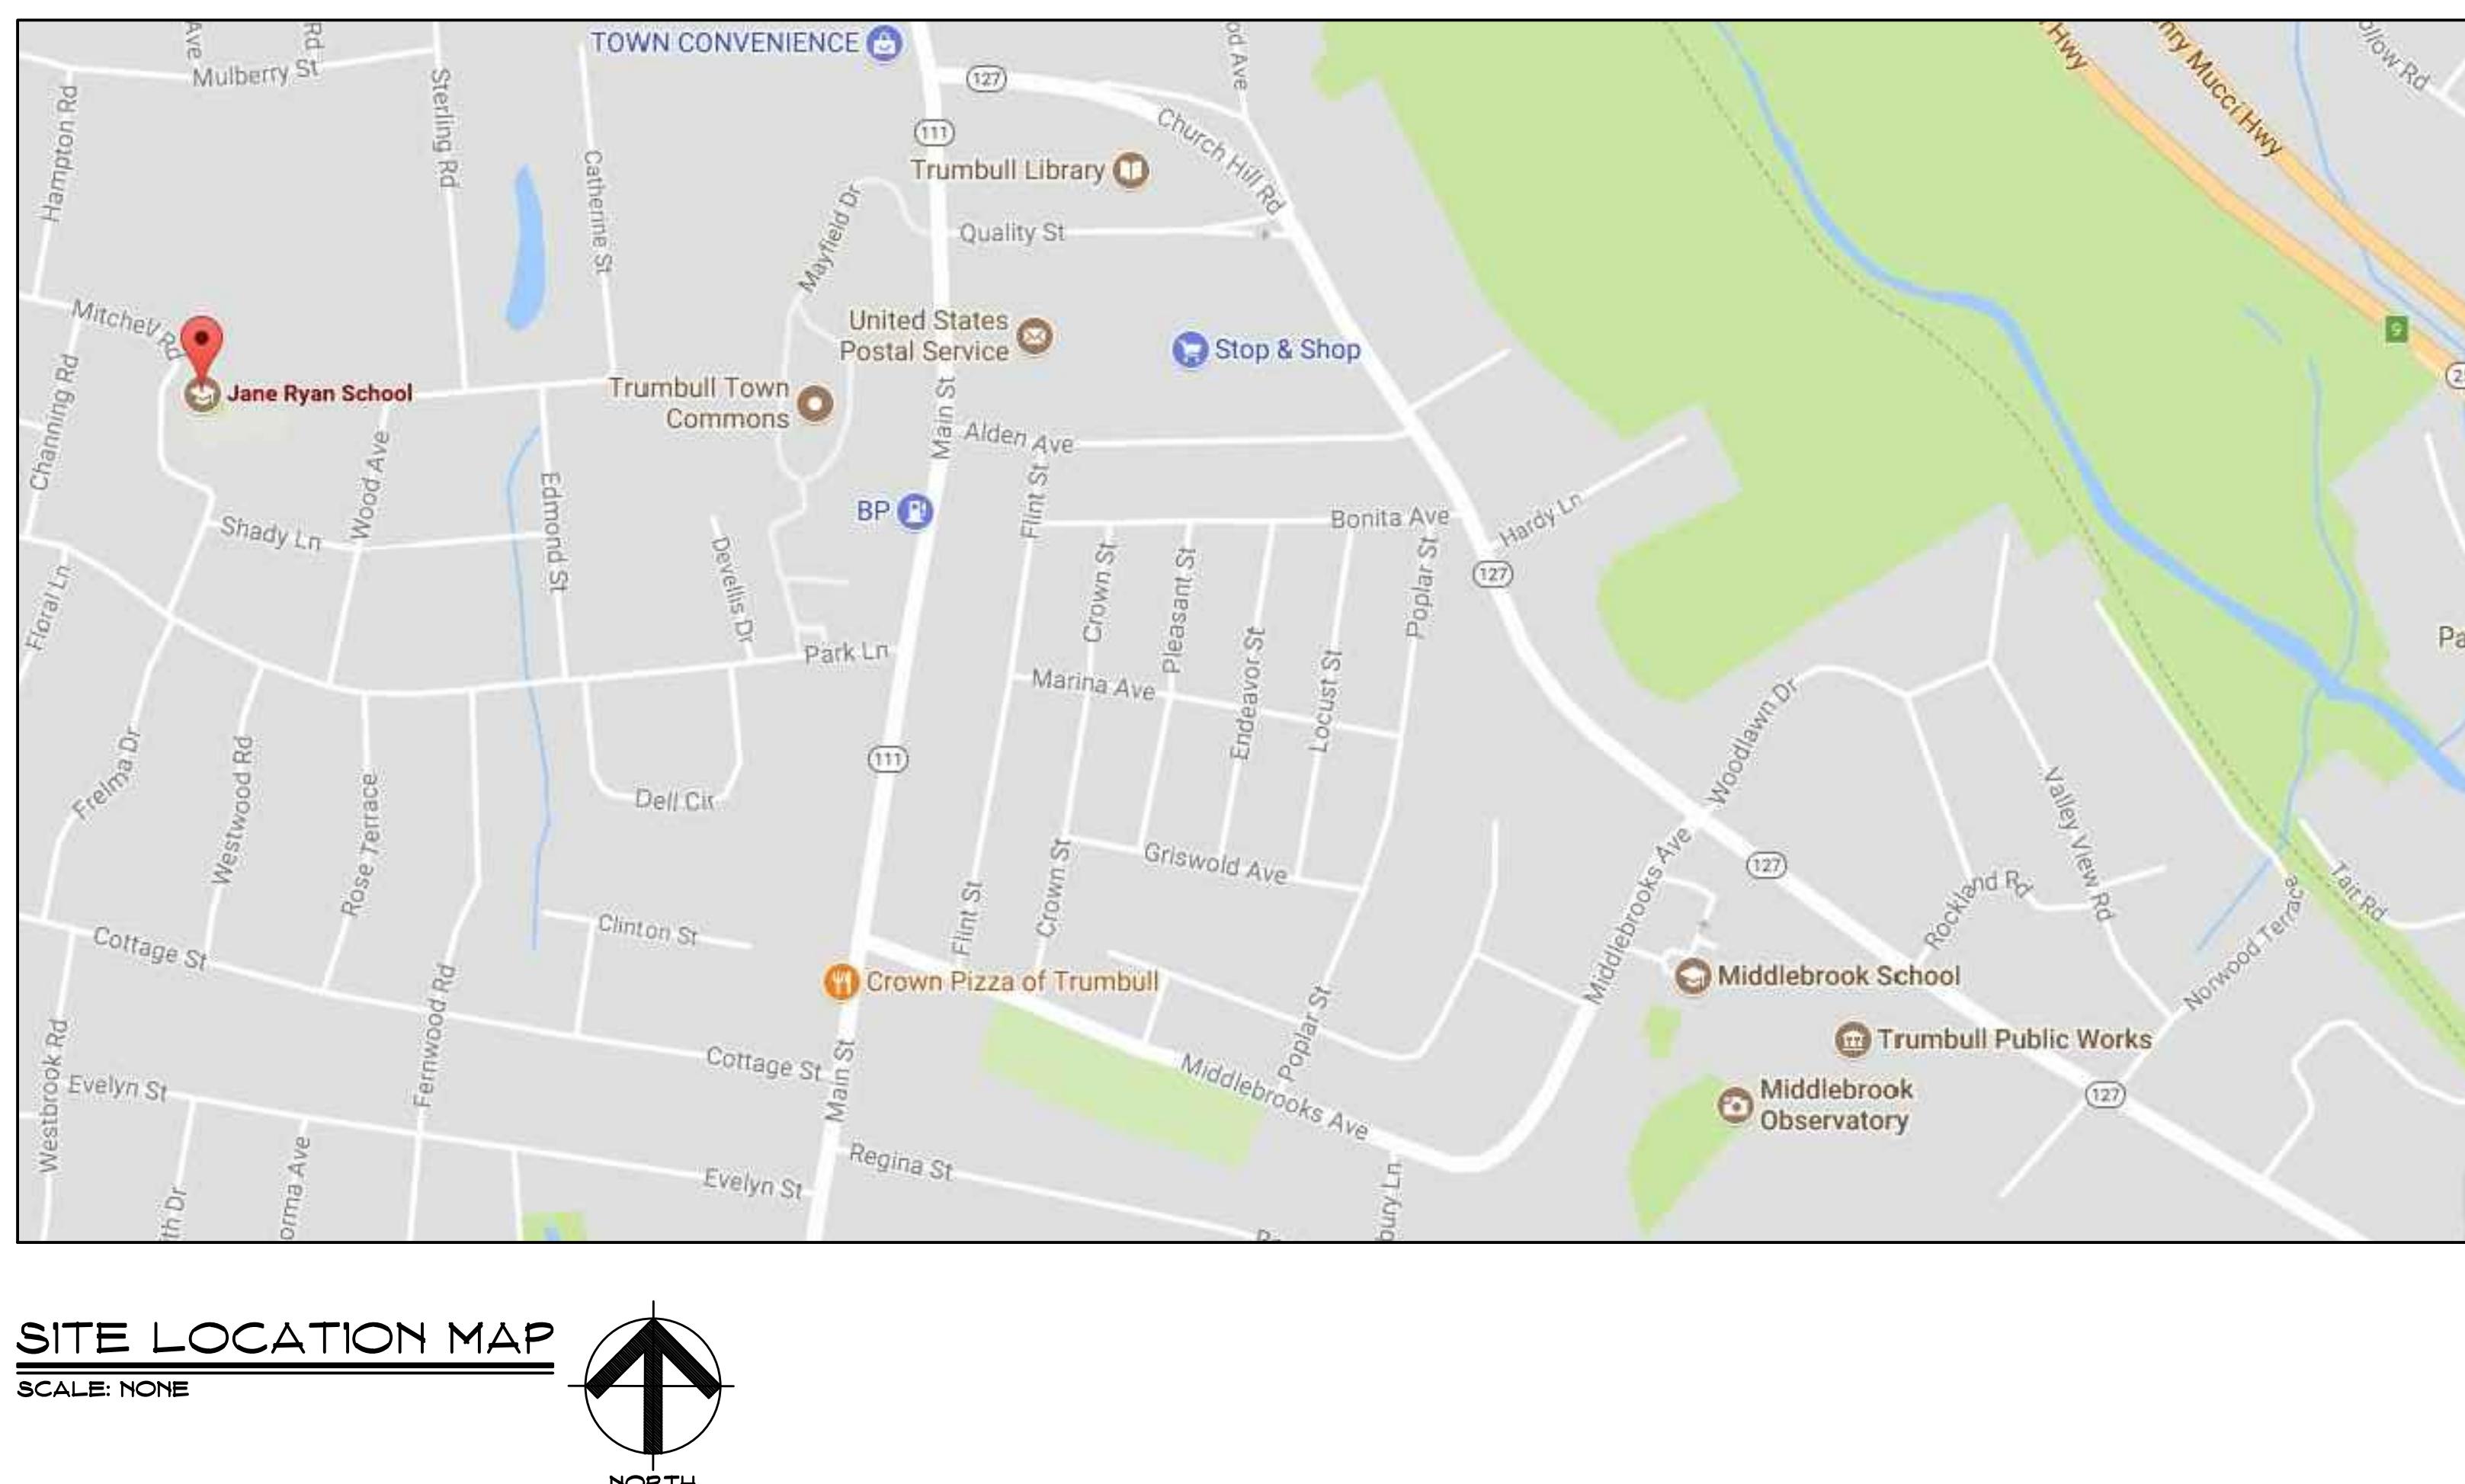

### DRAWING LIST:

#### General:

Cover Sheet  
G1 General Information Key & Code Information

#### Architectural:

A1	Existing Floor Plan
A2	Demolition Plans
A3	Floor Plans
A4	Exterior Elevations
A5	Window Elevations
A6	Window Elevations
A7	Window Details
A8	Window Details
A9	Schedules and Details
HM-01	Hazardous Materials Abatement Plans



SILVER / PETRUCCELLI + ASSOCIATES

Architects / Engineers / Interior Designers

3190 Whitney Avenue, Hamden, CT 06518-2340


Tel. 203 230 9007 Fax. 203 230 8247

[silverpetruccelli.com](http://silverpetruccelli.com)

State Project Number: 144-0104 EC/CV

May 24, 2018  
Issued for Bid: July 12, 2018


ARCHITECTURAL ABBREVIATIONS		DRAFTING CONVENTIONS		WALL OPENING INDICATIONS		CODE INFORMATION	
AB.	ANCHOR BOLT	R.	RISER	EXISTING DOOR		DATE OF ORIGINAL CONSTRUCTION	1954
A.C.P.	ASBESTOS CEMENT PIPE	R.A.D.	RADIUS	EX. DOOR TO BE REMOVED		DATES OF ADDITIONS	1968, 1995
ADJ.	ADJUSTABLE	R.C.P.	REINFORCED CONCRETE PIPE			1. USE GROUP CLASSIFICATION	(Primary _____) E-Educational (Incidental) _____ A3-Assembly
A.F.F.	ABOVE FINISH FLOOR	R.D.	ROOF DRAIN			2. CONSTRUCTION TYPE (Chapter 6)	Minimum Type Required _____ N/A Actual Type Provided (new) _____ N/A
AC.	ACOUSTICAL CEILING TILE	REINF.	REINFORCEMENT			3. BUILDING HEIGHT (Chapter 5)	Allowable Height (story/feet) _____ N/A Actual Height (story/feet) _____ N/A (Stories Above Grade) _____ N/A
ALLUM.	ALUMINUM	REQD.	REQUIRED			4. BUILDING AREA (Chapter 5)	a) Building Area (Lower Floor) Existing construction _____ 17,498 sq.ft. New construction _____ 0 sq.ft. Total floor _____ 17,498 sq.ft.
APPROX.	APPROXIMATE	R.H.	ROOF HATCH			b) Building Area (Main Floor) Existing construction _____ 39,397 sq.ft. New construction _____ 0 sq.ft. Total floor _____ 39,397 sq.ft.	
ARCH.	ARCHITECTURAL	R.L.	ROOF LEADER			c) Building Area (all floors) Existing construction _____ 56,895 sq.ft. New construction _____ 0 sq.ft. Total floor _____ 56,895 sq.ft.	
ASPH.	ASPHALT	R.M.	ROOM			5. AREA MODIFICATIONS TO TABLE 503	N/A
AVG.	AVERAGE	S.	STORM			6. CASE 1 - SINGLE OCCUPANCY OR NONSEPARATED USES (302.3.1) (Allowable Area 508.4)	N/A
BSMT.	BASEMENT	SAN.	SANITARY			7. CASE 2 - MIXED OCCUPANCY SEPARATED USES (302.3.2) (Allowable Area 508.4)	N/A
BD.	BOARD	S.C.	SEALED CONCRETE				
BRG.	BEARING	SCHED.	SCHEDULE				
BRK.	BRICK	SECT.	SECTION				
BIT.	BITUMINOUS	STEP	STEP				
BLK.	BLOCK	SIM.	SIMILAR				
BLDG.	BUILDING	S.O.G.	SLAB ON GRADE				
B.S.	BOTH SIDES	SPEC.	SPECIFICATIONS				
C.I.	CAST IRON	SQ. FT.	SQUARE FEET				
C.I.P.	CAST IN PLACE CONCRETE	STL.	STEEL				
CB.	CATCH BASIN	STRUCT.	STRUCTURAL				
C.B.R.	CATCH BASIN TO BE REMOVED	SUSP.	SUSPENDED SUSPENSION				
CL.	CASTING	SHEAR	SHEAR				
C.C.	CENTER LINE	SHEAR	SHEAR				
C.B.D.	CHALK BOARD	S.W.F.	SHEAR WALL FOOTING				
C.C.	CURB CUT	T.	TELEPHONE				
C.G.	CLEAR OUT	TECH.	TOP & BOTTOM TECHNOLOGY				
CONC.	CONCRETE	T.O.	TOP OF				
CONF.	CONFERENCE	T.O.F.	TOP OF FRAME				
CMU.	CONCRETE MASONRY UNIT	T.O.S.	TOP OF SHELL				
CONT.	CONTINUOUS	T.S.	TOP OF SLAB				
C.J.	CONTROL/CONSTRUCTION JOINT	T/W	TOP OF WALL				
CONTR.	CONTRACTOR	T.T.F.	TRIM TO FIT				
DET.	DETAIL	TYP.	Typical				
DIA.	DIAMETER	U.O.N.	UNLESS OTHERWISE NOTED				
DIM.	DIMENSION	V.B.	VINYL BASE				
DR.	DOOR	V.C.T.	VINYL COMPOSITE TILE				
DN.	DOWN	VERT.	VERTICAL				
DWG.	DRAWING	V.I.P.	VERTICAL IN FIELD				
E.	ELECTRICAL	W.	WATER				
EA.	EACH	W.C.J.	WALL CONTROL JOINT				
ECTR.	EXISTING CEILING TO REMAIN	WD.	WOOD				
ED.	EDUCATION	WF.	WIDE FLANGE				
ELEC.	ELECTRICAL	W.W.F.	WELDED WIRE FABRIC				
EF.	EACH FACE	W.W.M.	WELDED WIRE MESH				
E.J.	EXPANSION JOINT	•	AT				
EL.	ELEVATION	Φ	DIAMETER				
ELEV.	ELEVATION						
EMER.	EMERGENCY						
ENCL.	ENCLOSURE						
ENL.	ENLARGED						
ENT.	ENTRANCE						
EP.	EPoxy PAINT						
EQ.	EQUIPMENT						
ES.	EXPOSED STRUCTURE						
ES.T.R.	EXISTING TO REMAIN						
E.W.	EACH WAY						
EW./E.F.	EACH WAY/EACH FACE						
EXAM.	EXAMINATION						
EXIST.	EXISTING						
EXP.	EXPANSION						
EXT.	EXTERIOR						
FDN.	FOUNDATION						
FF.	FINISHED FLOOR						
FIN.	FOLDING PARTITION						
FIN.	FINISH, FINISHED						
FLAT.	FLAT						
FL.	FLOR						
FT.	FOOT						
F.S.	FAR SIDE						
FTG.	FOOTING						
G.	GAS						
GA.	GAGE, GAUGE						
GEN.	GENERAL						
G.C.	GENERAL CONTRACTOR						
GYP.	GYPSUM						
GYP. BD.	GYPSUM BOARD						
H.C.	HANDICAPPED						
HD.	HEADERS						
HDWR.	HARDWARE						
HGT.	HEIGHT						
HP.	HIGH POINT						
HM.	HOLLOW METAL						
HORIZ.	HORIZONTAL, HORIZONTALLY						
HS.	HOSE BIBB						
HR.	HOUR						
HYD.	HYDRANT						
INSUL.	INSULATION, INSULATED						
INT.	INTERIOR						
IV.	INVERT						
JAN.	JANITOR						
K.P.	KICK PLATE						
LAM.	LAMINATE						
LF.	LINEAL FOOT						
LG.	LONG						
LOC.	LOCATION						
LP.	LOW POINT						
LTG.	LIGHTING						
M.	MINUTE						
M.A.S.	MATERIAL						
MAX.	MAXIMUM						
MECH.	MECHANICAL						
M.H.	MANHOLE						
MIN.	MINIMUM						
MIS.	MISCELLANEOUS						
M.O.	MASONRY OPENING						
MTD.	MOUNTED						
NA.	NOT APPLICABLE						
N.C.	NOT IN CONTRACT						
NO.	NUMBER						
NOM.	NOMINAL						
N.P.S.	NOMINAL PIPE SIZE						
N.S.	NEAR SIDE						
N.T.S.	NOT TO SCALE						
O.C.	ON CENTER						
O.C.C.	OCUPANT						
O.D.	CUTTING DIAMETER						
OPNG.	OPENING						
P.C.B.	PAINTED CONCRETE BLOCK						
P.G.B.	PAINTED GYPSUM BOARD						
PL.	PLATE						
PLUMB.	PLUMBING						
PLYWD.	PLYWOOD						
PREP.	PREPARATION						
P.T.	PRESURE TREATED						
P.T.D.	PAINTER						
P.V.C.	POLYVINYLL CHLORIDE						
Project Title: Window Replacement and Entrances: Jane Ryan Elementary School 190 Park Lane Trumbull, Connecticut 06611		DRAFTING CONVENTIONS		WALL OPENING INDICATIONS		CODE INFORMATION	
SILVER / PETRUCELLI + ASSOCIATES Architects / Engineers / Interior Designers 3190 Whitney Avenue, Hamden, CT 06518-2340 Tel. 203 230 9007 Fax. 203 230 8247 silverpetrucci.com		Revision: _____		Description: _____		Date: _____	
Revision: _____		Description: _____		Date: _____		Revised By: _____	
Drawing Title: General Information & Code Information STATE PROJECT #144-0104 EC/CV		Drawing Number: _____		Drawing Number: _____		Date: MAY, 24TH 2016 Scale: AS NOTED Drawn By: CON Project Number: 18.031	
G1		Drawing Number: _____		Drawing Number: _____		Drawing Number: _____	

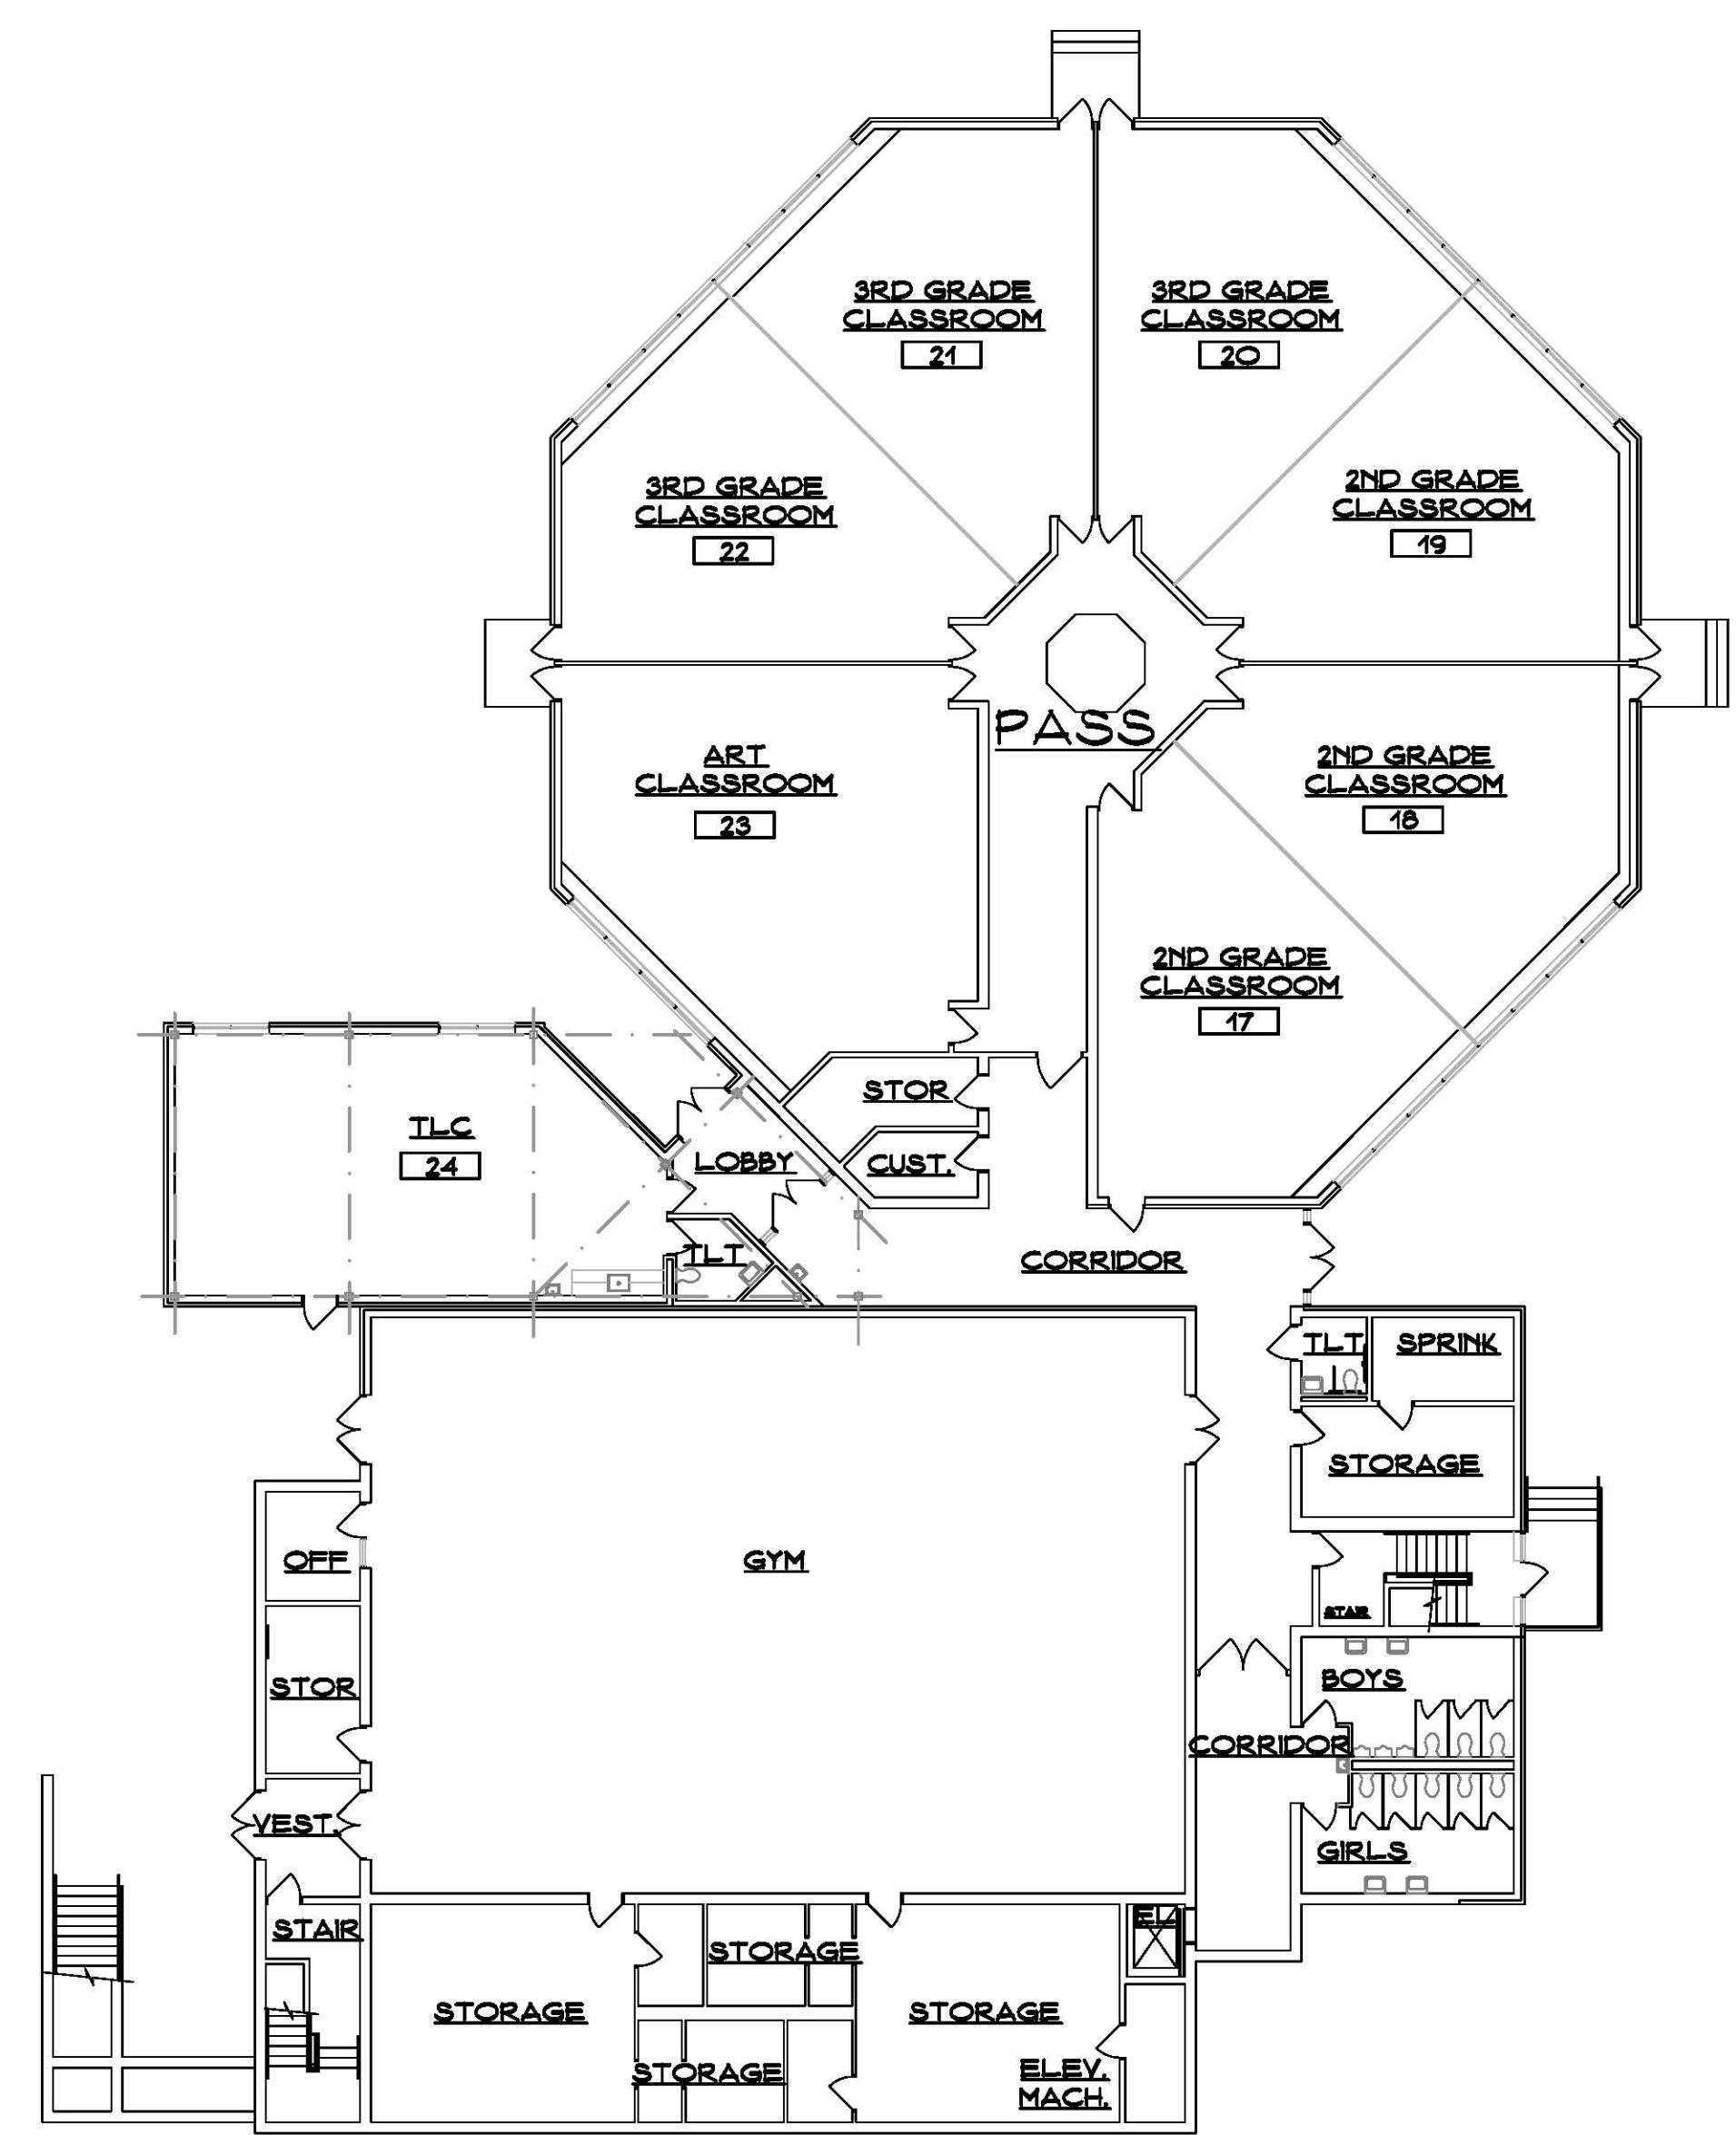

**OVERALL EXISTING LOWER FLOOR PL**


---

SCALE: 1/16" = 1'-0"

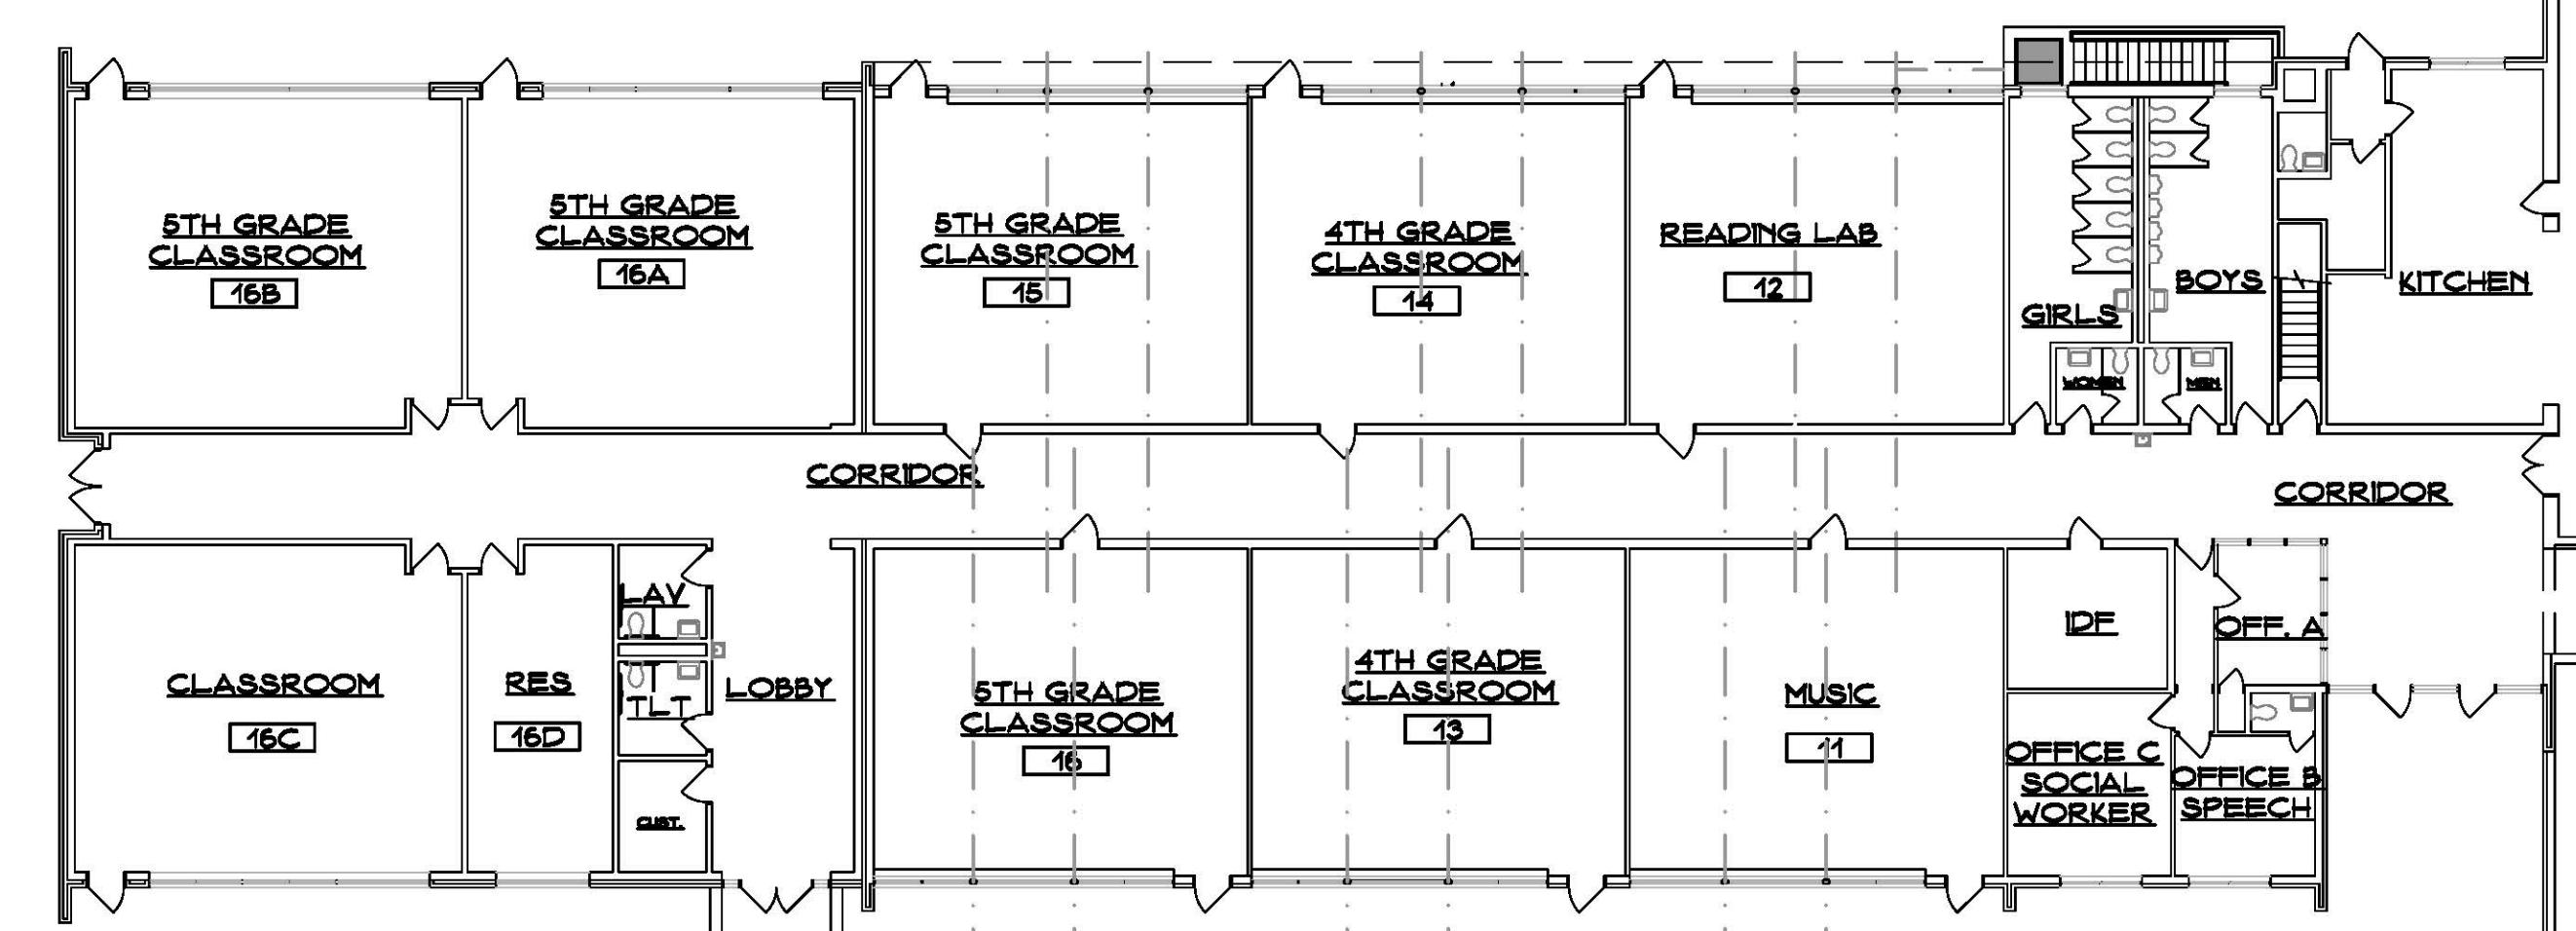

## OVERALL EXISTING MAIN FLOOR PLAN

**SCALE: 1/16" = 1'-0"**

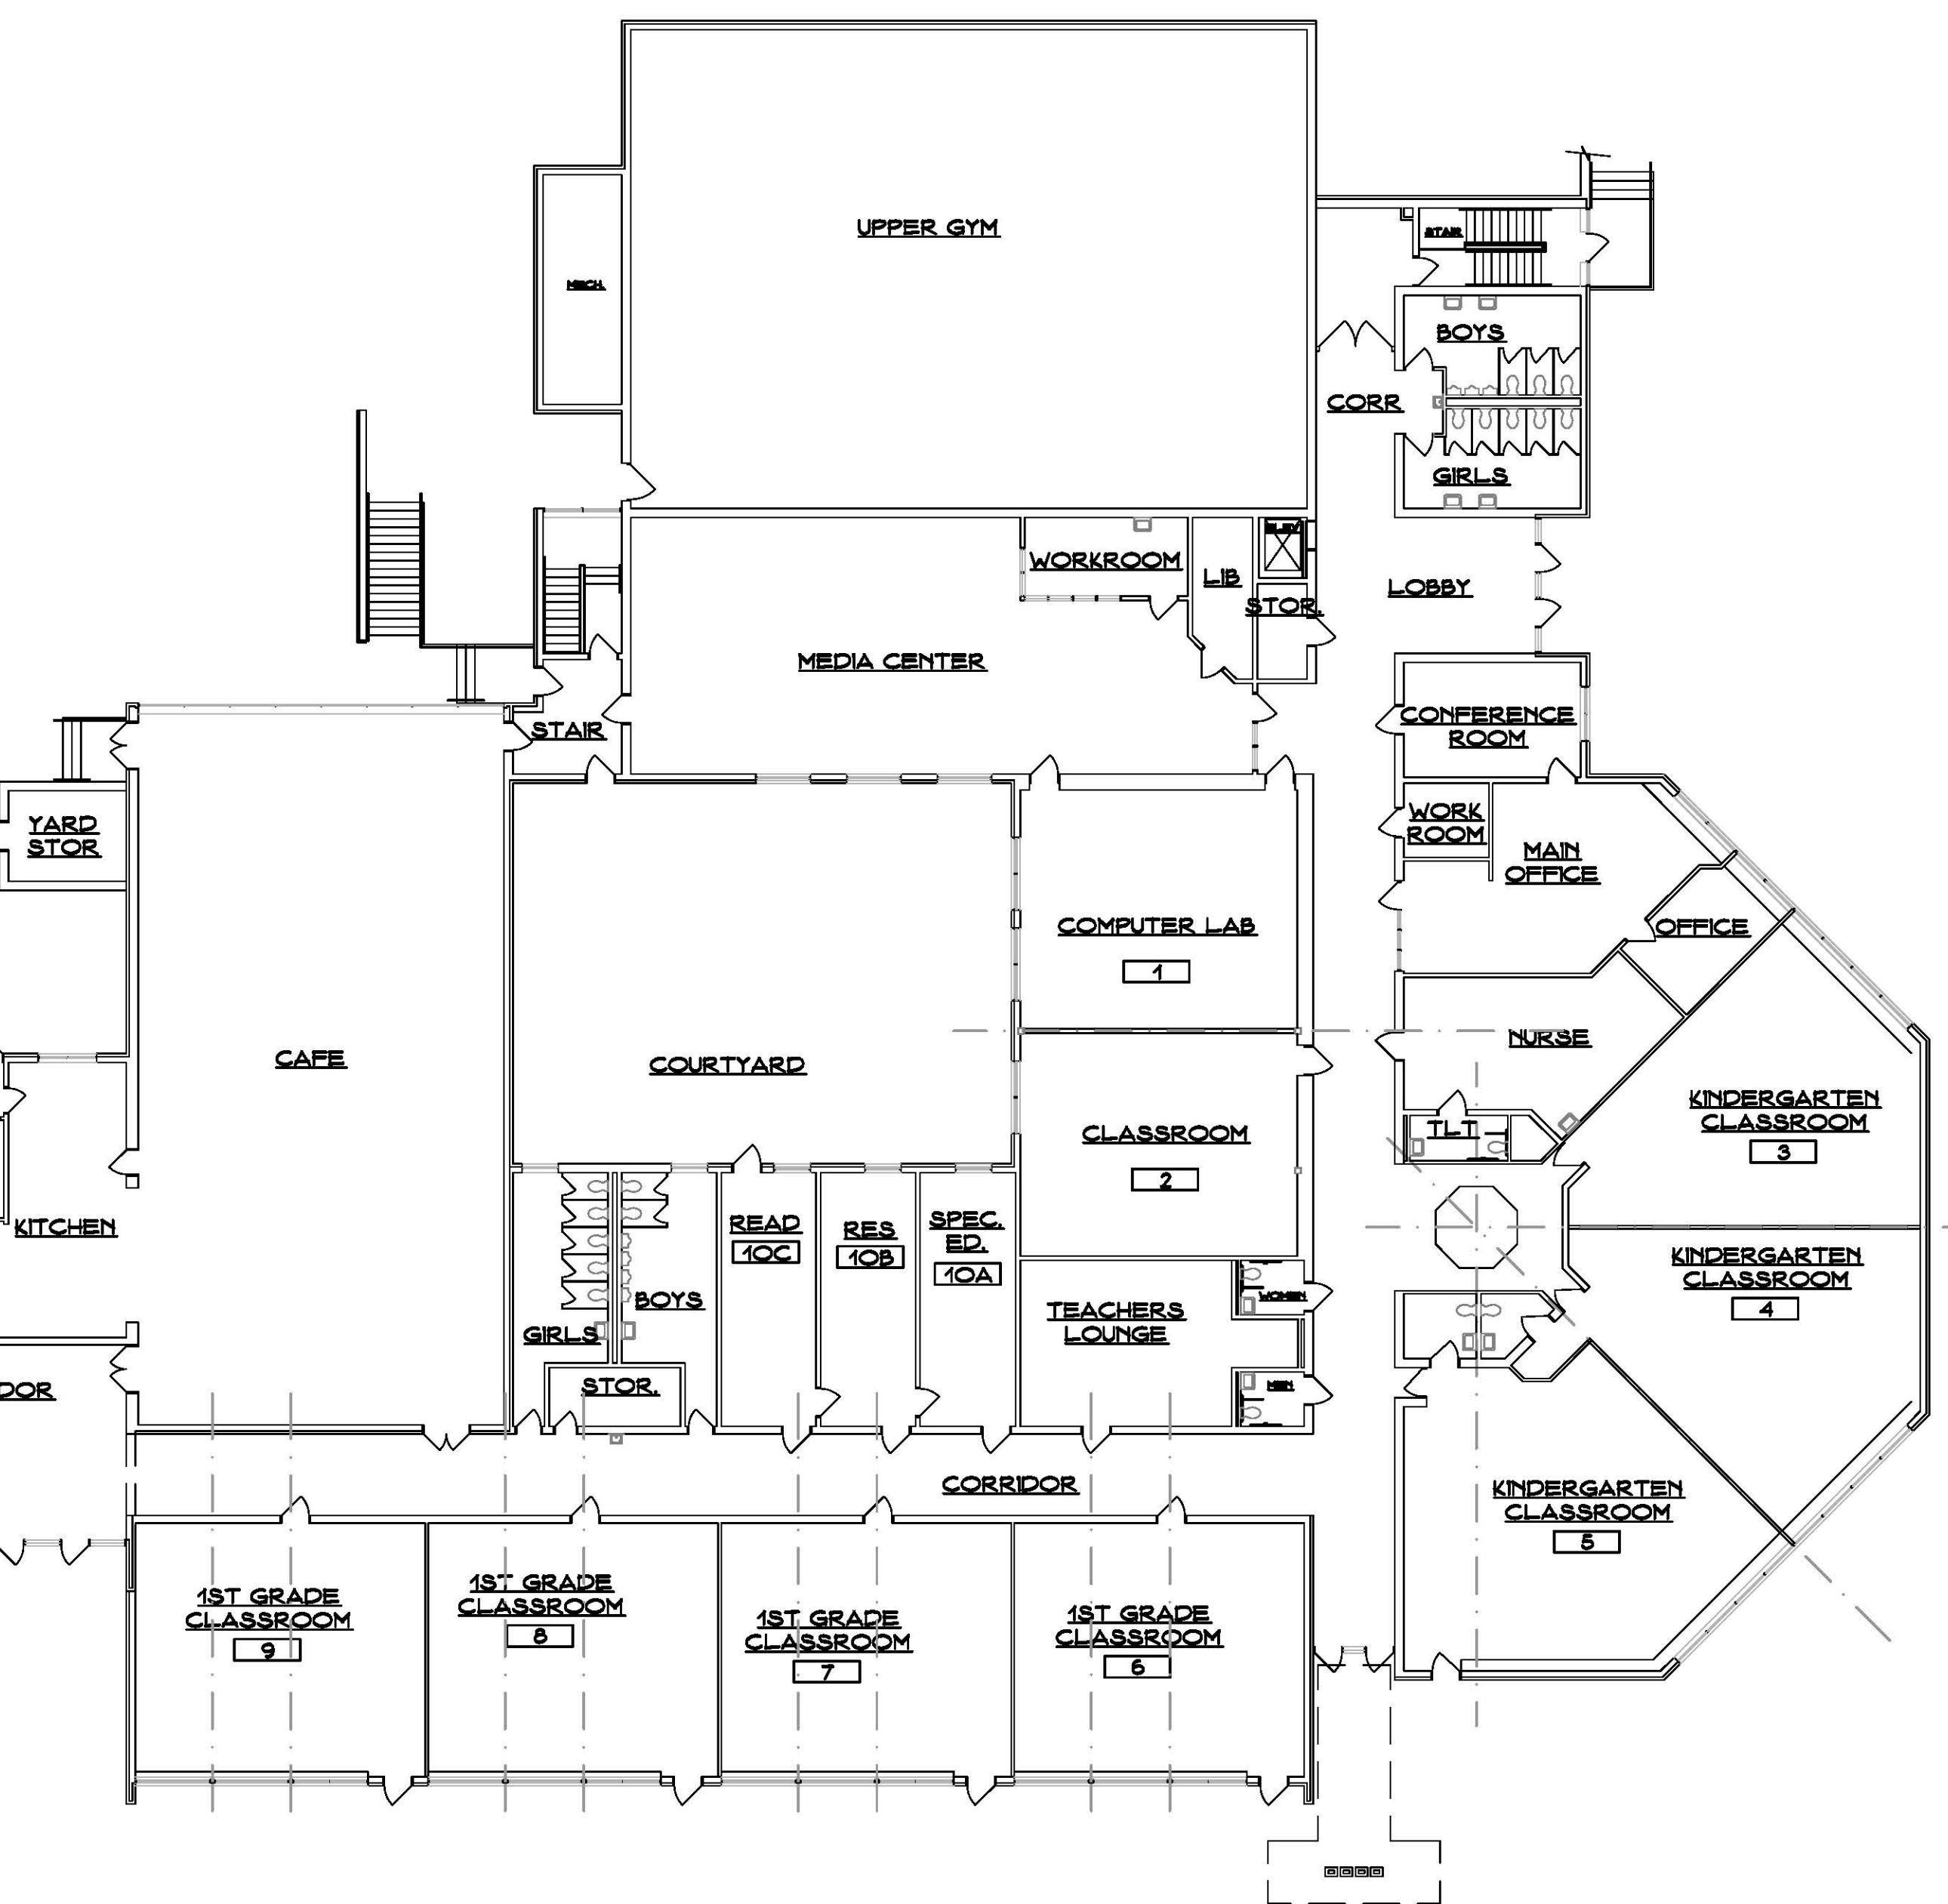

## Existing Floor Plan

STATE PROJECT #144-0104 EC/CV

## SYMBOL LEGEND

===== EXISTING TO REMAIN  
===== EXISTING TO BE REMOVED

 ACCESSIBLE STATION, SINK, OR AREA

 DOOR NUMBER - SEE DOOR SCHEDULE

 ROOM NUMBER - SEE FINISH SCHEDULE

 DEMOLITION NOTES - SEE DWGS.

 WINDOW TYPE - SEE ELEV. ON DWGS.

 ELEVATION OR SECTION NUMBER  
SHEET NUMBER

 PLAN, SECTION, DETAIL OR ELEV. NUMBER  
SHEET NUMBER

E.J. EXPANSION JOINT

H.D.F. HANDICAPPED DRINKING FOUNTAIN

TB/WB TACKBOARD/WHITEBOARD

## GENERAL NOTES

CONTRACTOR IS RESPONSIBLE TO FIELD VERIFY ALL EXISTING CONDITIONS & DIMENSIONS PRIOR TO CONSTRUCTION.

CONTRACTOR IS RESPONSIBLE TO REPAIR OR REPLACE ANY AREAS DAMAGED OUTSIDE THE SCOPE OF WORK RETURNING THEM TO THEIR ORIGINAL CONDITION AT NO EXPENSE TO OWNER.

PATCH ALL EXISTING MATERIALS AFFECTED BY NEW CONSTRUCTION IN THIS PROJECT, MATCH EXISTING.

ALL MATERIALS & EQUIP. ARE NEW UNLESS OTHERWISE NOTED AS 'EXISTING'.

REMOVE ALL DEMOLISHED MATERIALS FROM SITE. LEAVE SITE CLEAN OF ALL CONSTRUCTION DUST AND DEBRIS AT THE END OF EACH DAY.

CONTRACTOR WILL BE RESPONSIBLE FOR ALL CUSTODIAL TIME ASSOCIATED WITH CLEANING NOT PERFORMED BY CONTRACTOR.

CONTRACTOR TO PROVIDE FLUSH CONDITION AT ALL MASONRY OPENINGS, CUT BACK EX. STEEL AS REQUIRED.


CONTRACTOR IS RESPONSIBLE FOR REMOVING, RELOCATING, AND RECONNECTING ANY AND ALL ELEC. EQUIPMENT, DEVICES, CONDUIT AND WIRING AFFECTED BY THE SCOPE OF WORK PRIOR TO DEMOLITION AND UPON COMPLETION OF CONSTRUCTION. CONTRACTOR TO VERIFY ALL ASSOCIATED COMPONENTS AFFECTED BY THE SCOPE WORK.

CONTRACTOR RESPONSIBLE TO SURVEY AND DOCUMENT ALL LOCATIONS OF EXTERIOR WORK PRIOR TO BID. CONTRACTOR IS RESPONSIBLE TO CARRY ALL TRADES IN BID NEEDED TO REMOVE AND REINSTALL ALL OBJECTS ATTACHED TO EXISTING BRICK VENEER AFFECTED BY SCOPE OF WORK (I.E. ROOF LADDERS, EXHAUST, LOUVERS, SIGNAGE, ALARM SYSTEMS, ELEC. CONDUIT, AND ANY OTHER MISC. ITEMS).


CONTRACTOR TO COORDINATE AND REFERENCE EACH DISCIPLINE WITHIN THE DRAWING SET PRIOR & DURING CONSTRUCTION.


0. ANY DEMOLITION/CONSTRUCTION ACTIVITY WHICH WOULD IMPACT LEAD AND/OR ASBESTOS (TOXIC/NON-TOXIC) MUST BE CONDUCTED WITHIN COMPLIANCE AND TO CODE REQUIREMENTS (SEE PROJ. MAN.)

**KEY PLAN**      SCALE: NONE

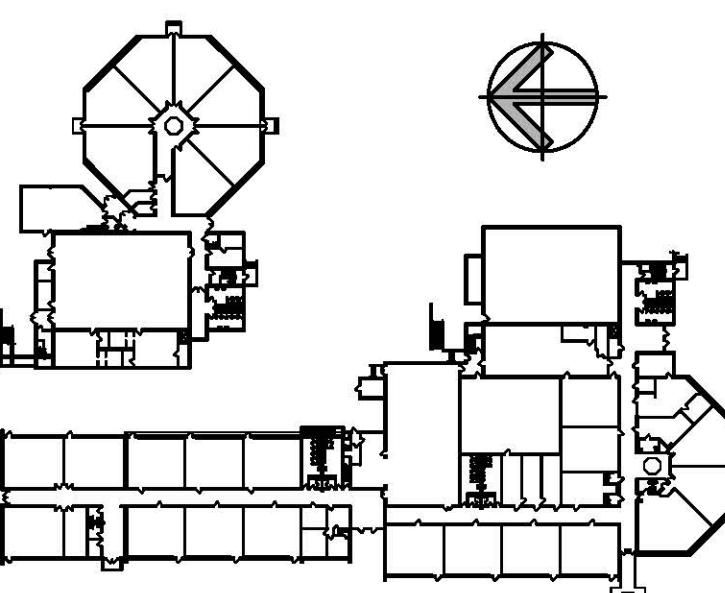

*Date:* **MAY, 24TH 2018**  
*Scale:* **AS NOTED**  
*Drawn By:* **CON**  
*Project Number:* **18.031**

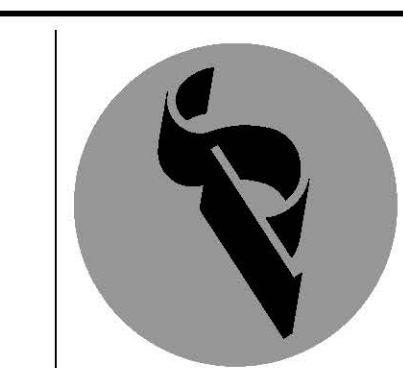

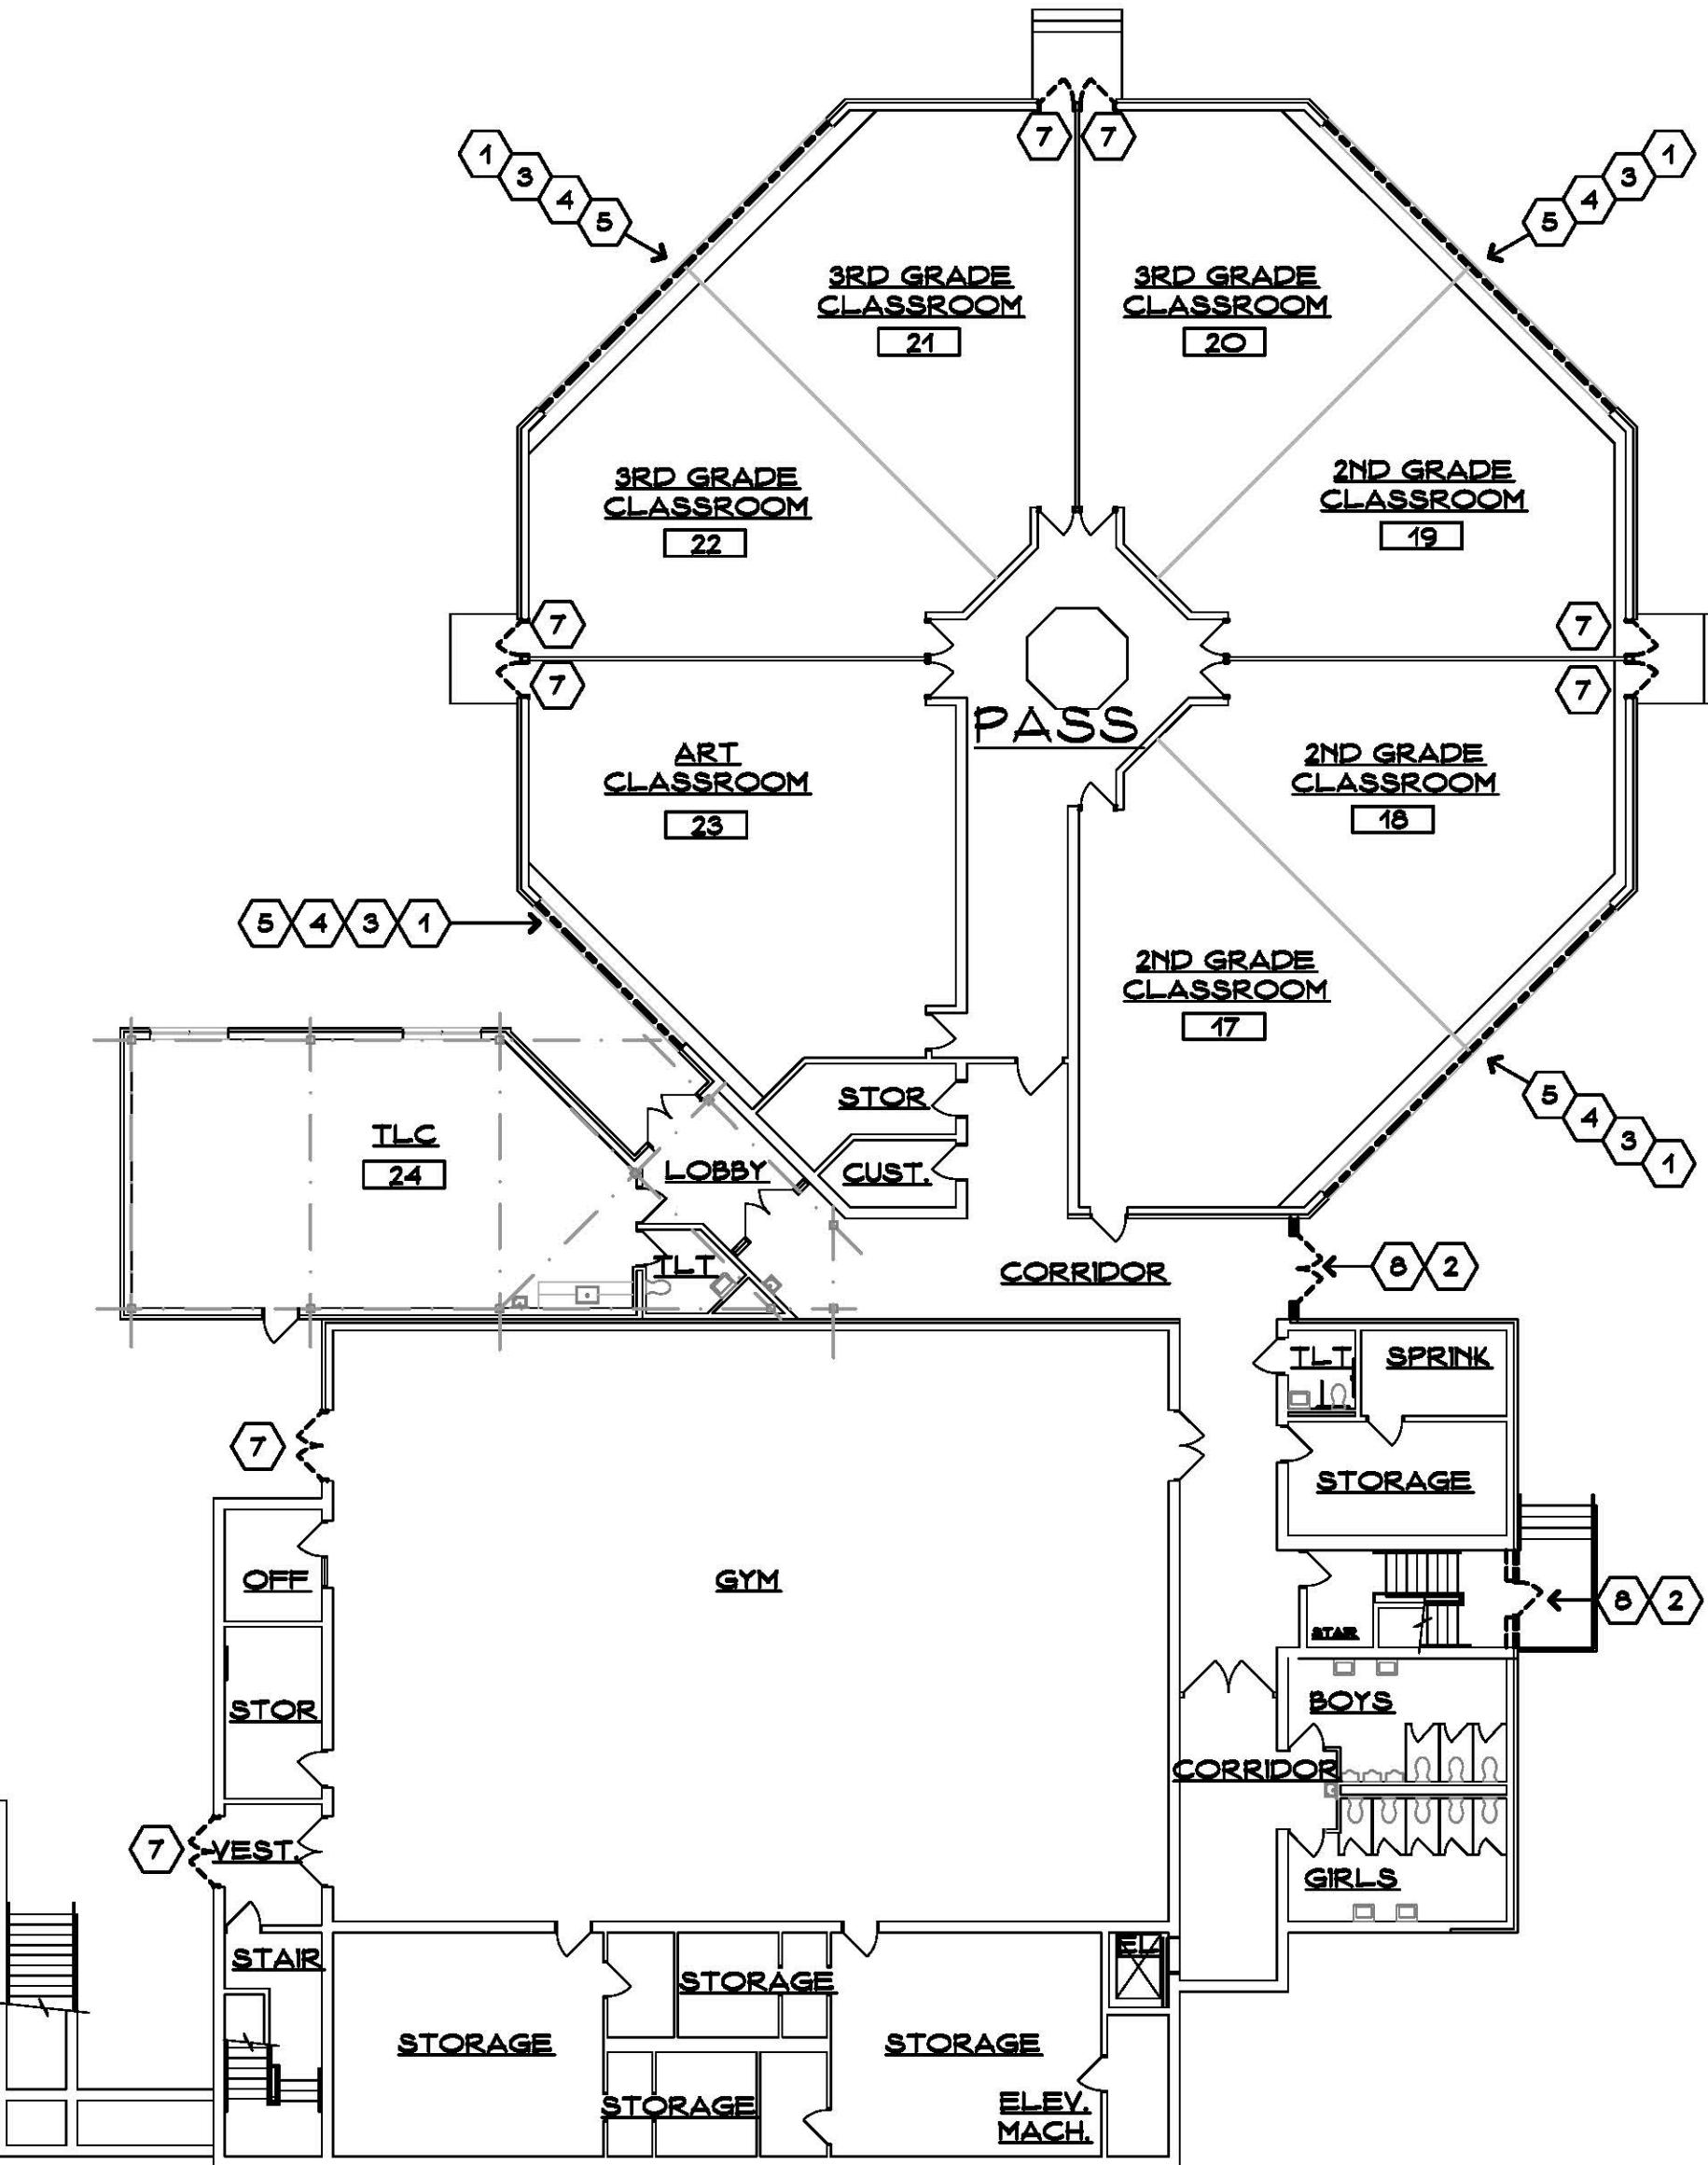

## PARTIAL DEMOLITION PLAN

**SCALE: 1/16" = 1'-0"**



## PARTIAL DEMOLITION PLAN


**SCALE: 1/16" = 1'-0"**



## LOWER LEVEL DEMOLITION PLAN


---

SCALE: 1/16" ■ 1'-0"

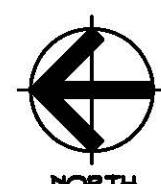

## MAIN LEVEL DEMOLITION PLAN

**SCALE: 1/16"**

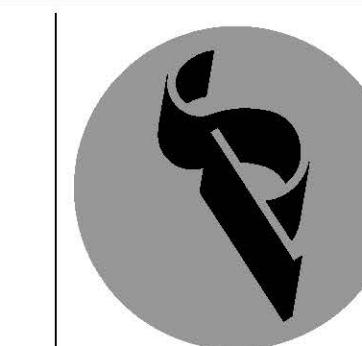

**SILVER / PETRUCCELLI + ASSOCIATES**  
*Architects / Engineers / Interior Designers*

3190 Whitney Avenue, Hamden, CT 06518-2340  
Tel. 203 230 9007 Fax. 203 230 8247  
*silverpetrucci.com*

*Project Title:* Window Replacement and Entrances:  
Jane Ryan Elementary School  
190 Park Lane  
Trumbull, Connecticut 06611

## SYMBOL LEGEND

===== EXISTING TO REMAIN  
===== EXISTING TO BE REMOVED

 ACCESSIBLE STATION, SINK, OR AREA

 DOOR NUMBER - SEE DOOR SCHEDULE

 ROOM NUMBER - SEE FINISH SCHEDULE

 DEMOLITION NOTES - SEE DWGS.

 WINDOW TYPE - SEE ELEV. ON DWGS.

 ELEVATION OR SECTION NUMBER  
SHEET NUMBER

 PLAN, SECTION, DETAIL OR ELEV. NUMBER  
SHEET NUMBER

E.J. EXPANSION JOINT

H.D.F. HANDICAPPED DRINKING FOUNTAIN

TB/WB TACKBOARD/WHITEBOARD

## DEMOLITION NOTES 1

REM. EX. STEEL WINDOW SYSTEM, GLAZING, AND ASSOCIATED HARDWARE, CAULKING, ETC.

REM. EX. ALUMINUM DOORS AND SIDELITE FRAME, GLAZING, AND ACCESSORIES.

REM. PORTIONS OF CASEWORK AND RADIANT COVER AS REQUIRED TO REPLACE WINDOWS.

REM. EX. BLINDS, BLIND POCKET AND ALL ACCESSORIES.

REM. EX. WOOD TRIM • WINDOW HEAD.

REM. EX. HOLLOW METAL WINDOW/DOOR FRAME, GLAZING, AND ACCESSORIES.

REM. EX. HOLLOW METAL DOOR. FRAME TO REMAIN.

REM. PORTIONS OF ACOUSTICAL CEILING TILE AND GRID AS REQUIRED TO REPLACE WINDOWS.

COORDINATE TEMPORARY REMOVAL OF RADIANT HEATER AS REQ'D. FOR WINDOW REPLACEMENT.

D. EXISTING SLATE SILL TO BE SALVAGED, CUT, AND REINSTALLED PER NEW WINDOW DIMENSIONS.

1. REM. EX. METAL PANEL AT HEAD OF WINDOW - SEE DETAILS.

2. CUT BACK EXISTING CEILING GRID AS REQ'D. TO INSTALL NEW ALUMINUM FRAME.

3. REM. EX. SOFFIT SEE HM DRAWINGS

## GENERAL NOTES

CONTRACTOR IS RESPONSIBLE TO FIELD VERIFY ALL EXISTING CONDITIONS & DIMENSIONS PRIOR TO CONSTRUCTION.

CONTRACTOR IS RESPONSIBLE TO REPAIR OR REPLACE ANY AREAS DAMAGED OUTSIDE THE SCOPE OF WORK RETURNING THEM TO THEIR ORIGINAL CONDITION AT NO EXPENSE TO OWNER.

PATCH ALL EXISTING MATERIALS AFFECTED BY NEW CONSTRUCTION IN THIS PROJECT, MATCH EXISTING.

ALL MATERIALS & EQUIP. ARE NEW UNLESS OTHERWISE NOTED AS 'EXISTING'.

REMOVE ALL DEMOLISHED MATERIALS FROM SITE. LEAVE SITE CLEAN OF ALL CONSTRUCTION DUST AND DEBRIS AT THE END OF EACH DAY.

CONTRACTOR WILL BE RESPONSIBLE FOR ALL CUSTODIAL TIME ASSOCIATED WITH CLEANING NOT PERFORMED BY CONTRACTOR.

CONTRACTOR TO PROVIDE FLUSH CONDITION AT ALL MASONRY OPENINGS, CUT BACK EX. STEEL AS REQUIRED.


CONTRACTOR IS RESPONSIBLE FOR REMOVING, RELOCATING, AND RECONNECTING ANY AND ALL ELEC. EQUIPMENT, DEVICES, CONDUIT AND WIRING AFFECTED BY THE SCOPE OF WORK PRIOR TO DEMOLITION AND UPON COMPLETION OF CONSTRUCTION. CONTRACTOR TO VERIFY ALL ASSOCIATED COMPONENTS AFFECTED BY THE SCOPE WORK.

CONTRACTOR RESPONSIBLE TO SURVEY AND DOCUMENT ALL LOCATIONS OF EXTERIOR WORK PRIOR TO BID. CONTRACTOR IS RESPONSIBLE TO CARRY ALL TRADES IN BID NEEDED TO REMOVE AND REINSTALL ALL OBJECTS ATTACHED TO EXISTING BRICK VENEER AFFECTED BY SCOPE OF WORK (I.E. ROOF LADDERS, EXHAUST, LOUVERS, SIGNAGE, ALARM SYSTEMS, ELEC. CONDUIT, AND ANY OTHER MISC. ITEMS).

CONTRACTOR TO COORDINATE AND REFERENCE EACH DISCIPLINE WITHIN THE DRAWING SET PRIOR & DURING CONSTRUCTION.

O. ANY DEMOLITION/CONSTRUCTION ACTIVITY WHICH WOULD IMPACT LEAD AND/OR ASBESTOS (TOXIC/NON-TOXIC) MUST BE CONDUCTED WITHIN COMPLIANCE AND TO CODE REQUIREMENTS (SEE PROJ. MAN.)

## KEY PLAN

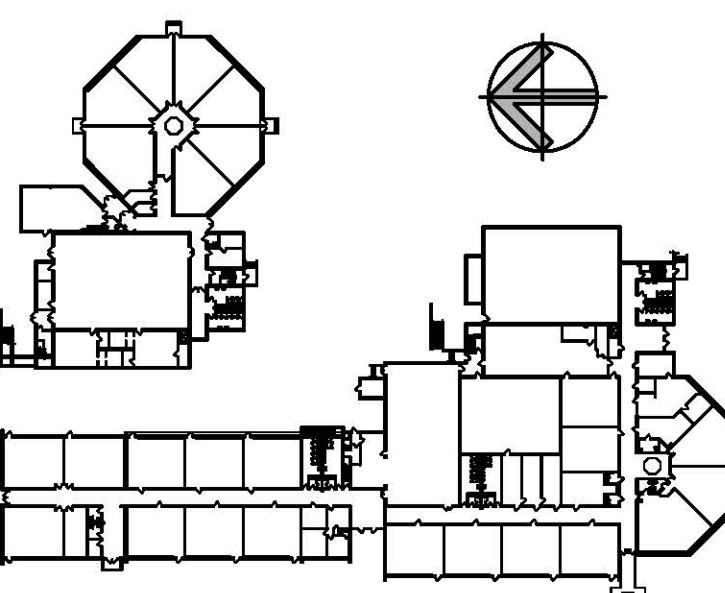

*Date:* **MAY, 24TH 2018**

*Scale:* **AS NOTED**

*Drawn By:* **CON**

*Project Number:* **18.031**

# Demolition Plans

# STATE PROJECT #144-0104 EC/CV

## SYMBOL LEGEND

—	EXISTING TO REMAIN
— — —	EXISTING TO BE REMOVED
	ACCESSIBLE STATION, SINK, OR AREA
	DOOR NUMBER - SEE DOOR SCHEDULE
	ROOM NUMBER - SEE FINISH SCHEDULE
	DEMOLITION NOTES - SEE DWGS.
	WINDOW TYPE - SEE ELEV. ON DWGS.
	ELEVATION OR SECTION NUMBER SHEET NUMBER
	PLAN, SECTION, DETAIL OR ELEV. NUMBER SHEET NUMBER
	E.J. EXPANSION JOINT
	H.D.F. HANDICAPPED DRINKING FOUNTAIN
	TB/WB TACKBOARD/WHITEBOARD



## CONSTRUCTION NOTES

1. THERMALLY BROKEN ALUMINUM WINDOW SYSTEM ASSEMBLY:  
- FRAME, SILL, GLAZING, OPERABLE, TRIM, BLOCKING & ASSOCIATED COMPONENTS (PER MANUFACTURER). SEE WINDOW TYPES, DETAILS & PROJECT MANUAL FOR ADDITIONAL INFORMATION.  
- SAND, PRIME & PAINT ALL EXPOSED STL LINTELS.  
- REINSTALL EXISTING RADIATOR GRILLE - SAND, PRIME & PAINT (PROVIDE BLOCKING/CLEAT AS REQ'D).  
- PROVIDE A DECAL AT NEW WINDOWS - SEE DETAIL 2/A6.
2. WINDOW BLINDS/SHADEROLLER SYSTEM:  
- INSTALL ON NEW WOOD TRIM. PROVIDE ALTERNATE FOR ROLLER SHADES. SEE PROJ. MAN.
3. PROVIDE METAL FLASHING ALONG ALL EDGES OF NEW WOOD TRIM.  
- MATCH PROFILE, LENGTH, DEPTH REQUIRED TO INSTALL NEW METAL FLASHING. PROVIDE NEW BLOCKING AS REQUIRED FOR INSTALLATION.
4. WRAP EXISTING SLATE SILLS WITH Drip EDGE UNDERNEATH SILL EXTENSION - SEE DETAILS.
5. PROVIDE HOLLOW METAL DOORS:  
- PROVIDE NEW HOLLOW METAL WITH EXISTING FRAMED OPENINGS. (SEE DOOR SCHEDULE FOR APPROX. SIZES TO BE VERIFIED IN FIELD.) SAND, SCRAPE, PAINT, AND PATCH EXISTING HOLLOW METAL FRAMES.
6. NEW ENTRANCE FRAMES:  
- PROVIDE ENTRANCE FRAMES TO MATCH ALUMINUM WINDOW FRAMING SYSTEM.
7. PROVIDE ALUMINUM DOORS PER ELEVATIONS, DOOR SCHEDULE, AND PROJ. MAN.
8. PROVIDE UPGRADE ENTRANCE FRAME AT MAIN ENTRANCE (SEE ELEVATIONS AND PROJ. MAN. FOR SPECIAL GLAZING REQUIREMENTS).
9. NO BLINDS THIS LOCATION.
10. SPECIAL OVERSIZED VERTICAL BLINDS REQUIRED THIS LOCATION.
11. PATCH ACOUSTICAL CEILING GRID AND TILES AS REQ'D. FOR NEW ALUMINUM WINDOW FRAME.
12. INSTALL SIGNAGE WITH DIRECTION TO DOOR 11 FOR ACCESSIBLE ENTRANCE - SEE DWG. A9.
13. PROVIDE TEN (10) SIGNS TO BE MOUNTED TO INSIDE OF DOOR GLASS AND WINDOWS FOR LARGE SPACES - SEE DET. ON DWG. A9.
14. INSTALL BLOCKING, FRAMING, AND NEW SOFFIT AT WINDOW HEAD SEE DETAIL ON A7

## GENERAL NOTES

1. CONTRACTOR IS RESPONSIBLE TO FIELD VERIFY ALL EXISTING CONDITIONS & DIMENSIONS PRIOR TO CONSTRUCTION.
2. CONTRACTOR IS RESPONSIBLE TO REPAIR OR REPLACE ANY AREAS DAMAGED OUTSIDE THE SCOPE OF WORK RETURNING THEM TO THEIR ORIGINAL CONDITION AT NO EXPENSE TO OWNER.
3. REMOVE ALL EXISTING MATERIALS AFFECTED BY NEW CONSTRUCTION IN THIS PROJECT. MATCH EXISTING.
4. ALL MATERIALS & EQUIP. ARE NEW UNLESS OTHERWISE NOTED AS "EXISTING".
5. REMOVE DEMOLISHED MATERIALS FROM SITE. LEAVE SITE CLEAR OF ALL CONSTRUCTION DUST AND DEBRIS AT THE END OF EACH DAY. CONTRACTOR WILL BE RESPONSIBLE FOR ALL CUSTODIAL TIME ASSOCIATED WITH CLEANING NOT PERFORMED BY CONTRACTOR.
6. CONTRACTOR TO PROVIDE DRY DUST CONDITION AT ALL MAGAZINE OPENINGS BACK BAG SEAMS AS REQUIRED.
7. CONTRACTOR IS RESPONSIBLE FOR REMOVING, RELOCATING, AND RECONNECTING ANY AND ALL ELECTRICAL, PLUMBER CONDUIT AND WIRING AFFECTED BY THE SCOPE OF WORK PROVIDED. CONTRACTOR IS RESPONSIBLE FOR COMPLETION OF CONSTRUCTION CONTRACTED TO VERIFY ALL ASSOCIATED COMPONENTS AFFECTED BY THE SCOPE OF WORK.
8. CONTRACTOR IS RESPONSIBLE TO SURVEY AND DOCUMENT ALL LOCATIONS OF EXTERIOR WORK PRIOR TO BID. CONTRACTOR IS RESPONSIBLE FOR PROVIDING ALL LOCATIONS IN BID NEEDED TO REMOVE AND REINSTALL ALL OBJECTS ATTACHED TO EXISTING BRICK VENEER AFFECTED BY SCOPE OF WORK (I.E. ROOF LADDERS, EXHAUST, LOUVERS, SIGNAGE, ALARM SYSTEMS, ELEC. CONDUIT, AND ANY OTHER MISC.).
9. CONTRACTOR TO COORDINATE AND REFERENCED EACH CONSTRUCTION ACTIVITY WHICH WOULD AFFECT EXISTING ASBESTOS (TOXIC/NON-TOXIC) MUST BE CONDUCTED WITHIN COMPLIANCE AND TO CODE REQUIREMENTS (SEE PROJ. MAN.)

## KEY PLAN SCALE: NONE

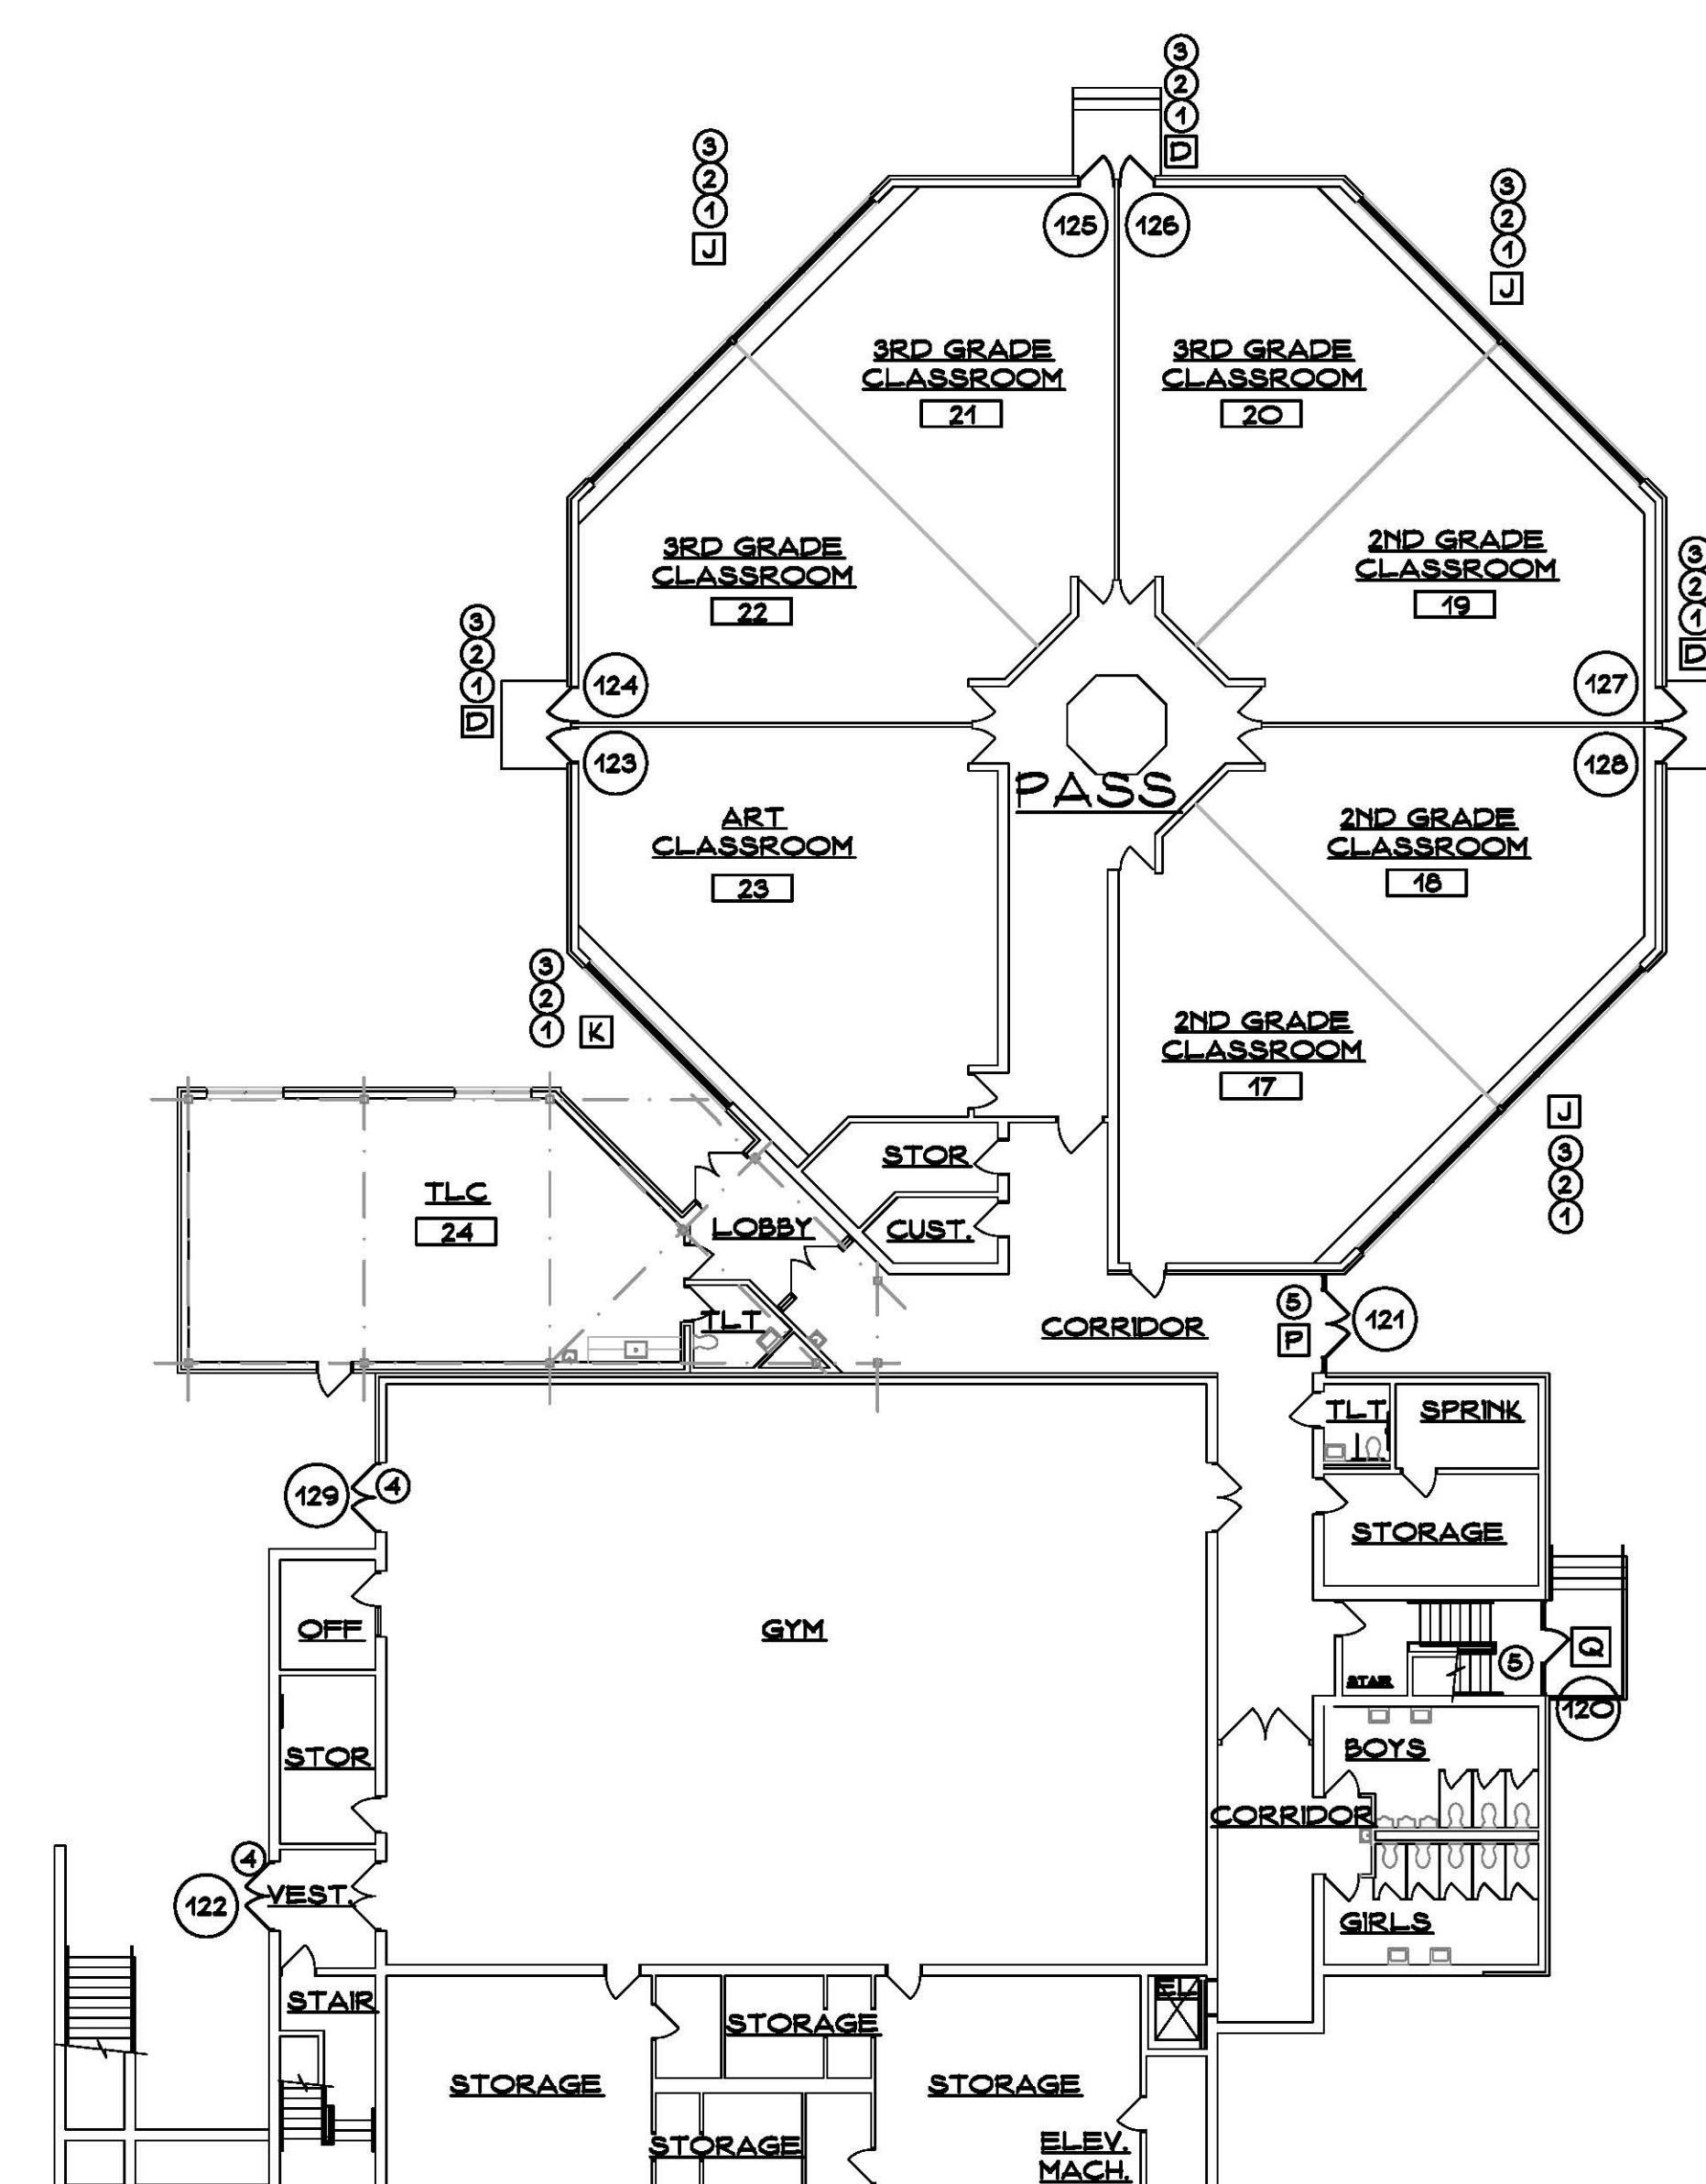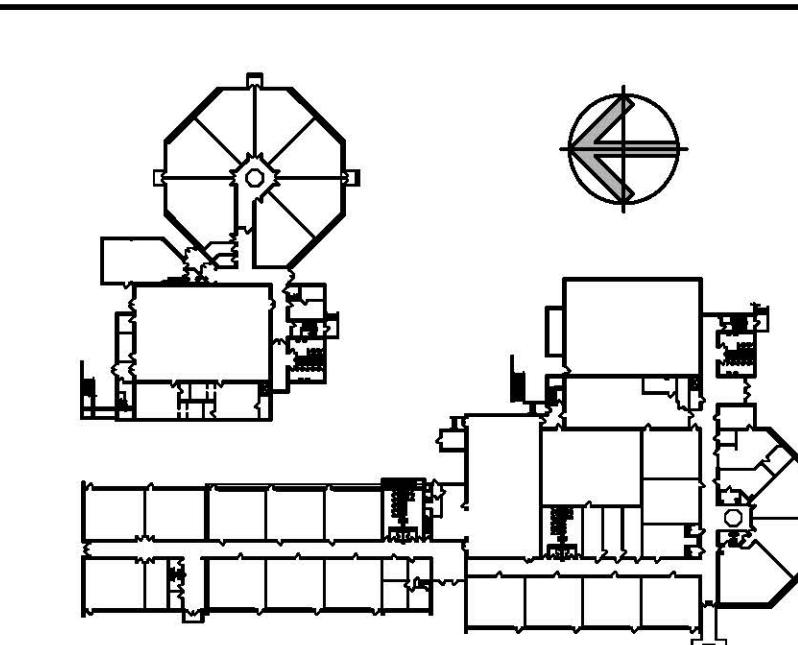


LOWER LEVEL FLOOR PLAN

SCALE: 1/16" = 1'-0"

2

A3

NORTH

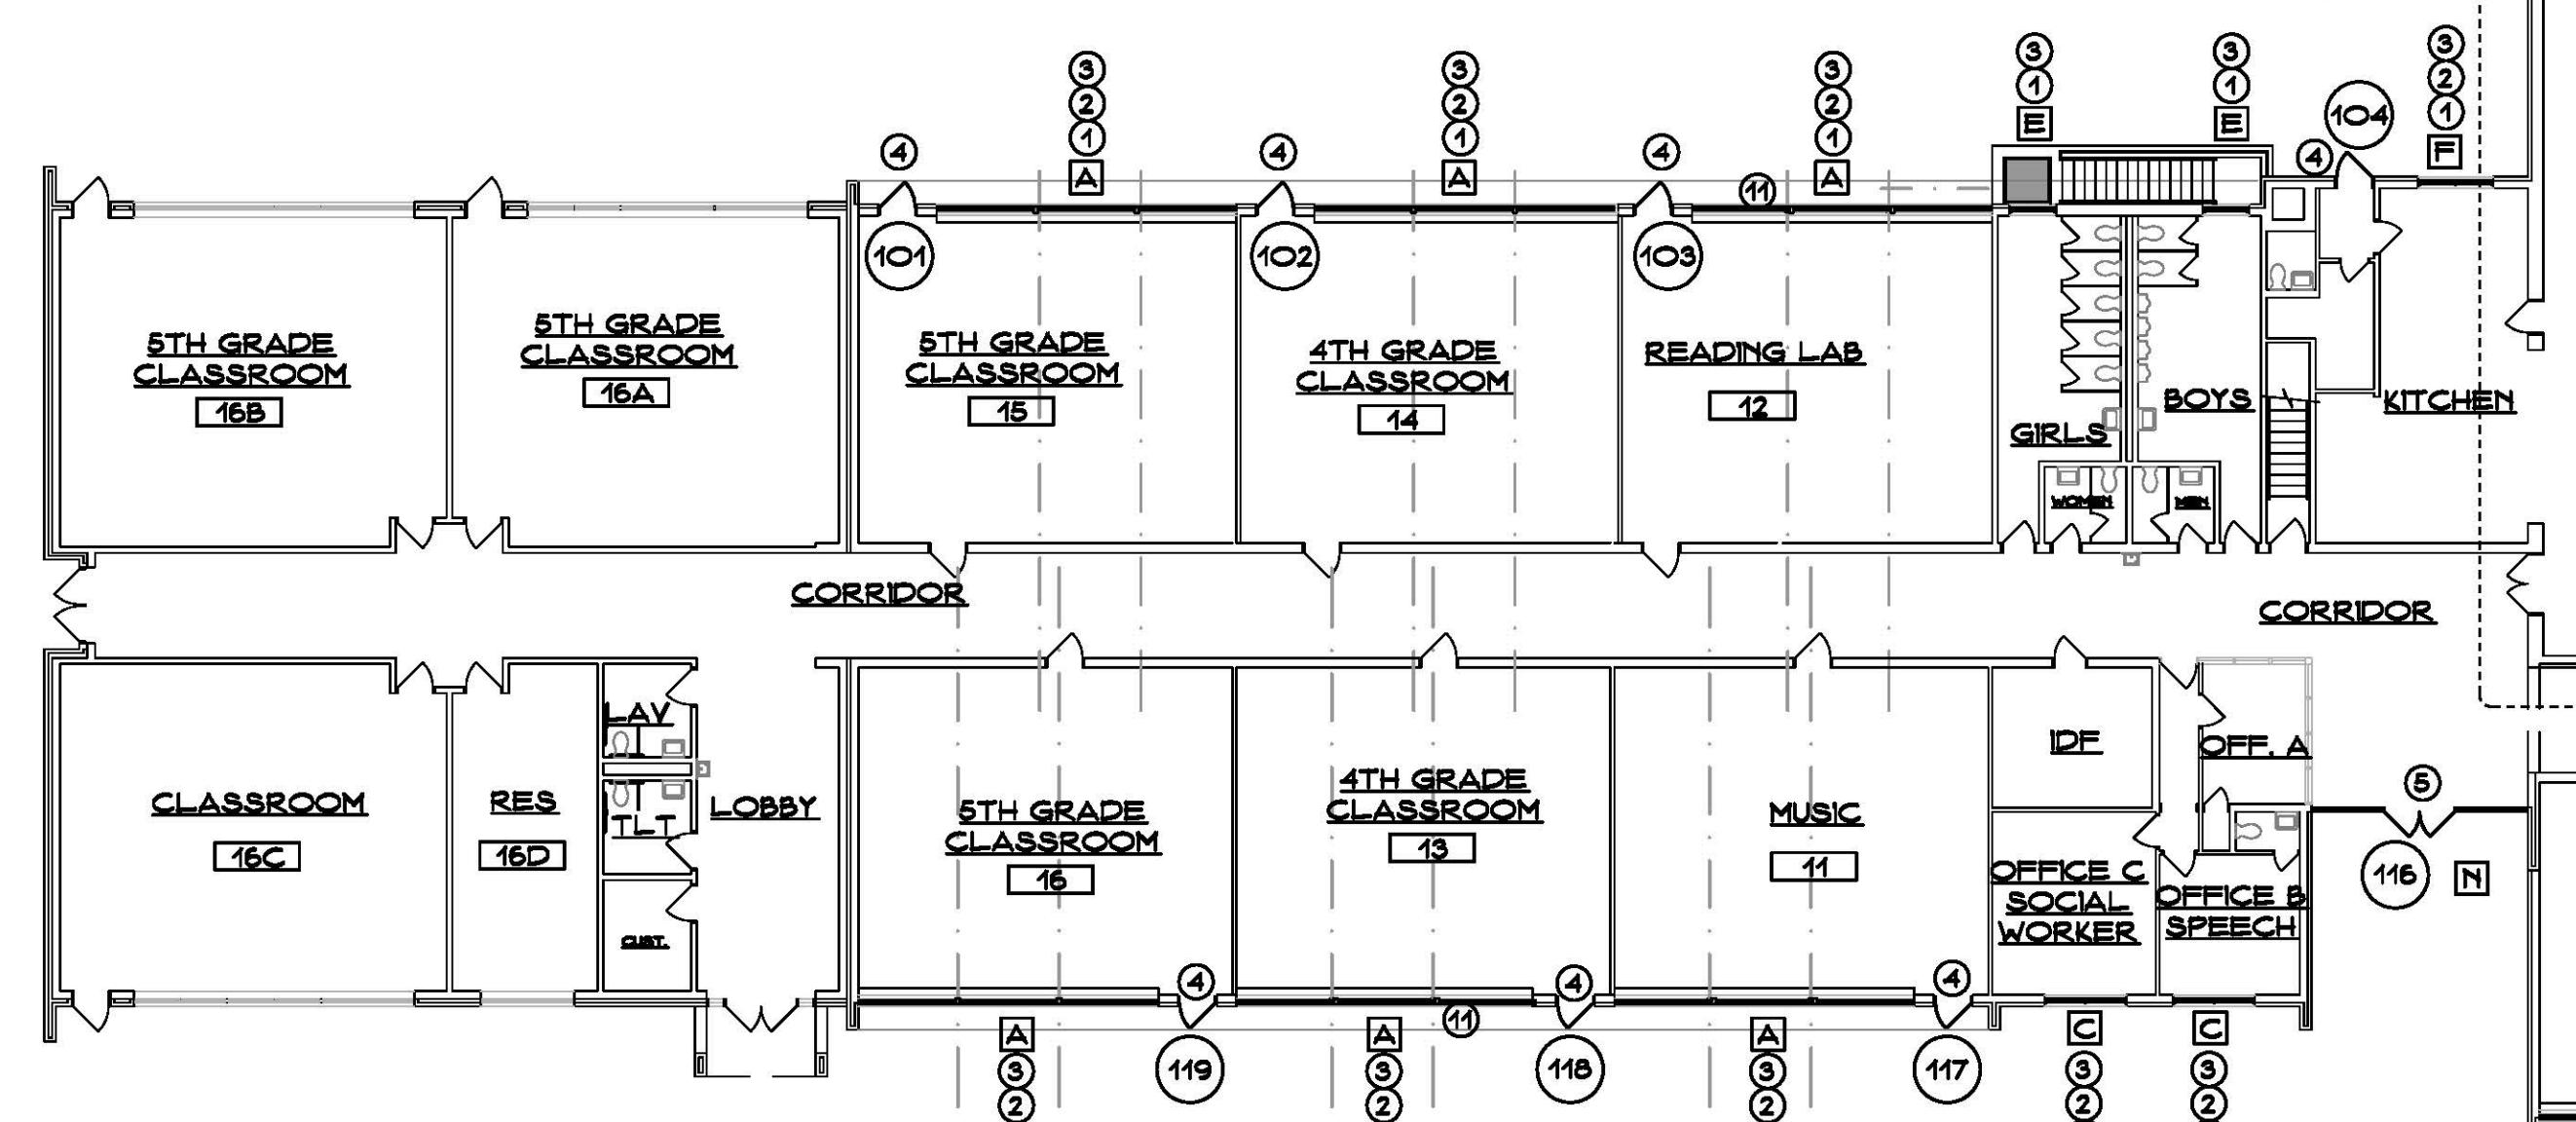


MAIN LEVEL FLOOR PLAN

SCALE: 1/16" = 1'-0"

1

A3

NORTH

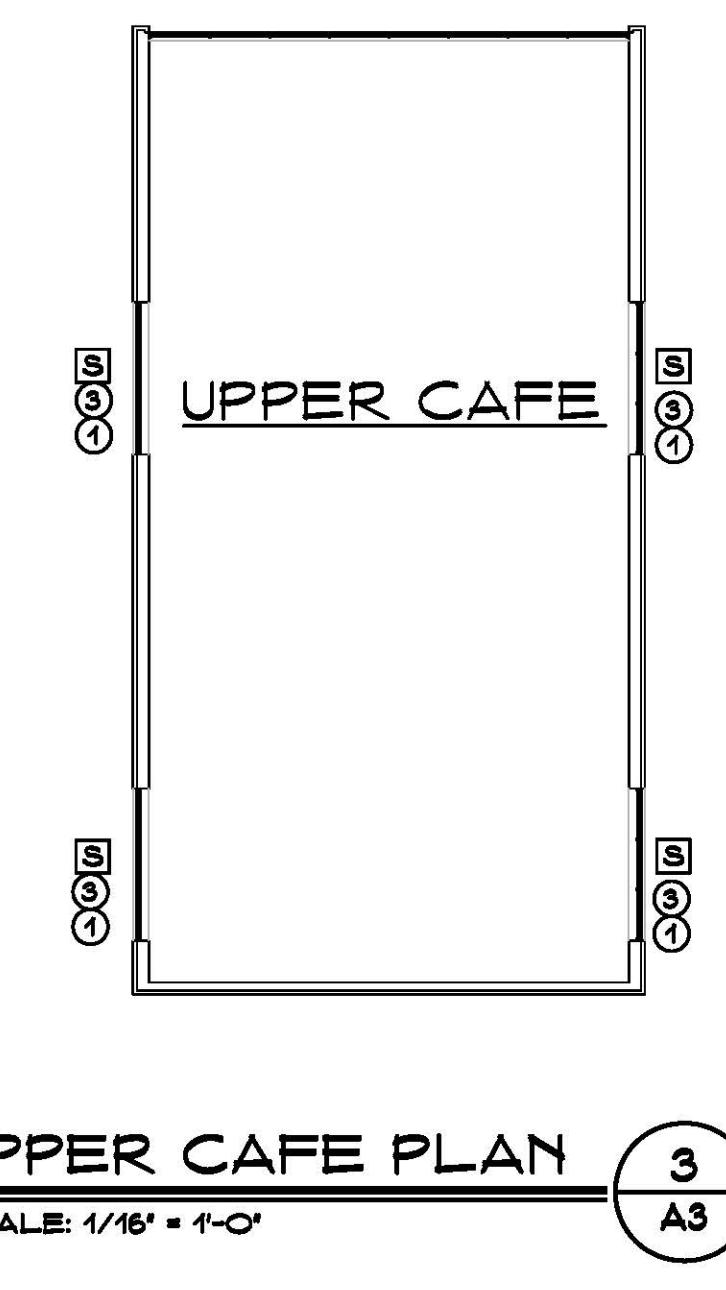


UPPER CAFE PLAN

SCALE: 1/16" = 1'-0"

3

A3

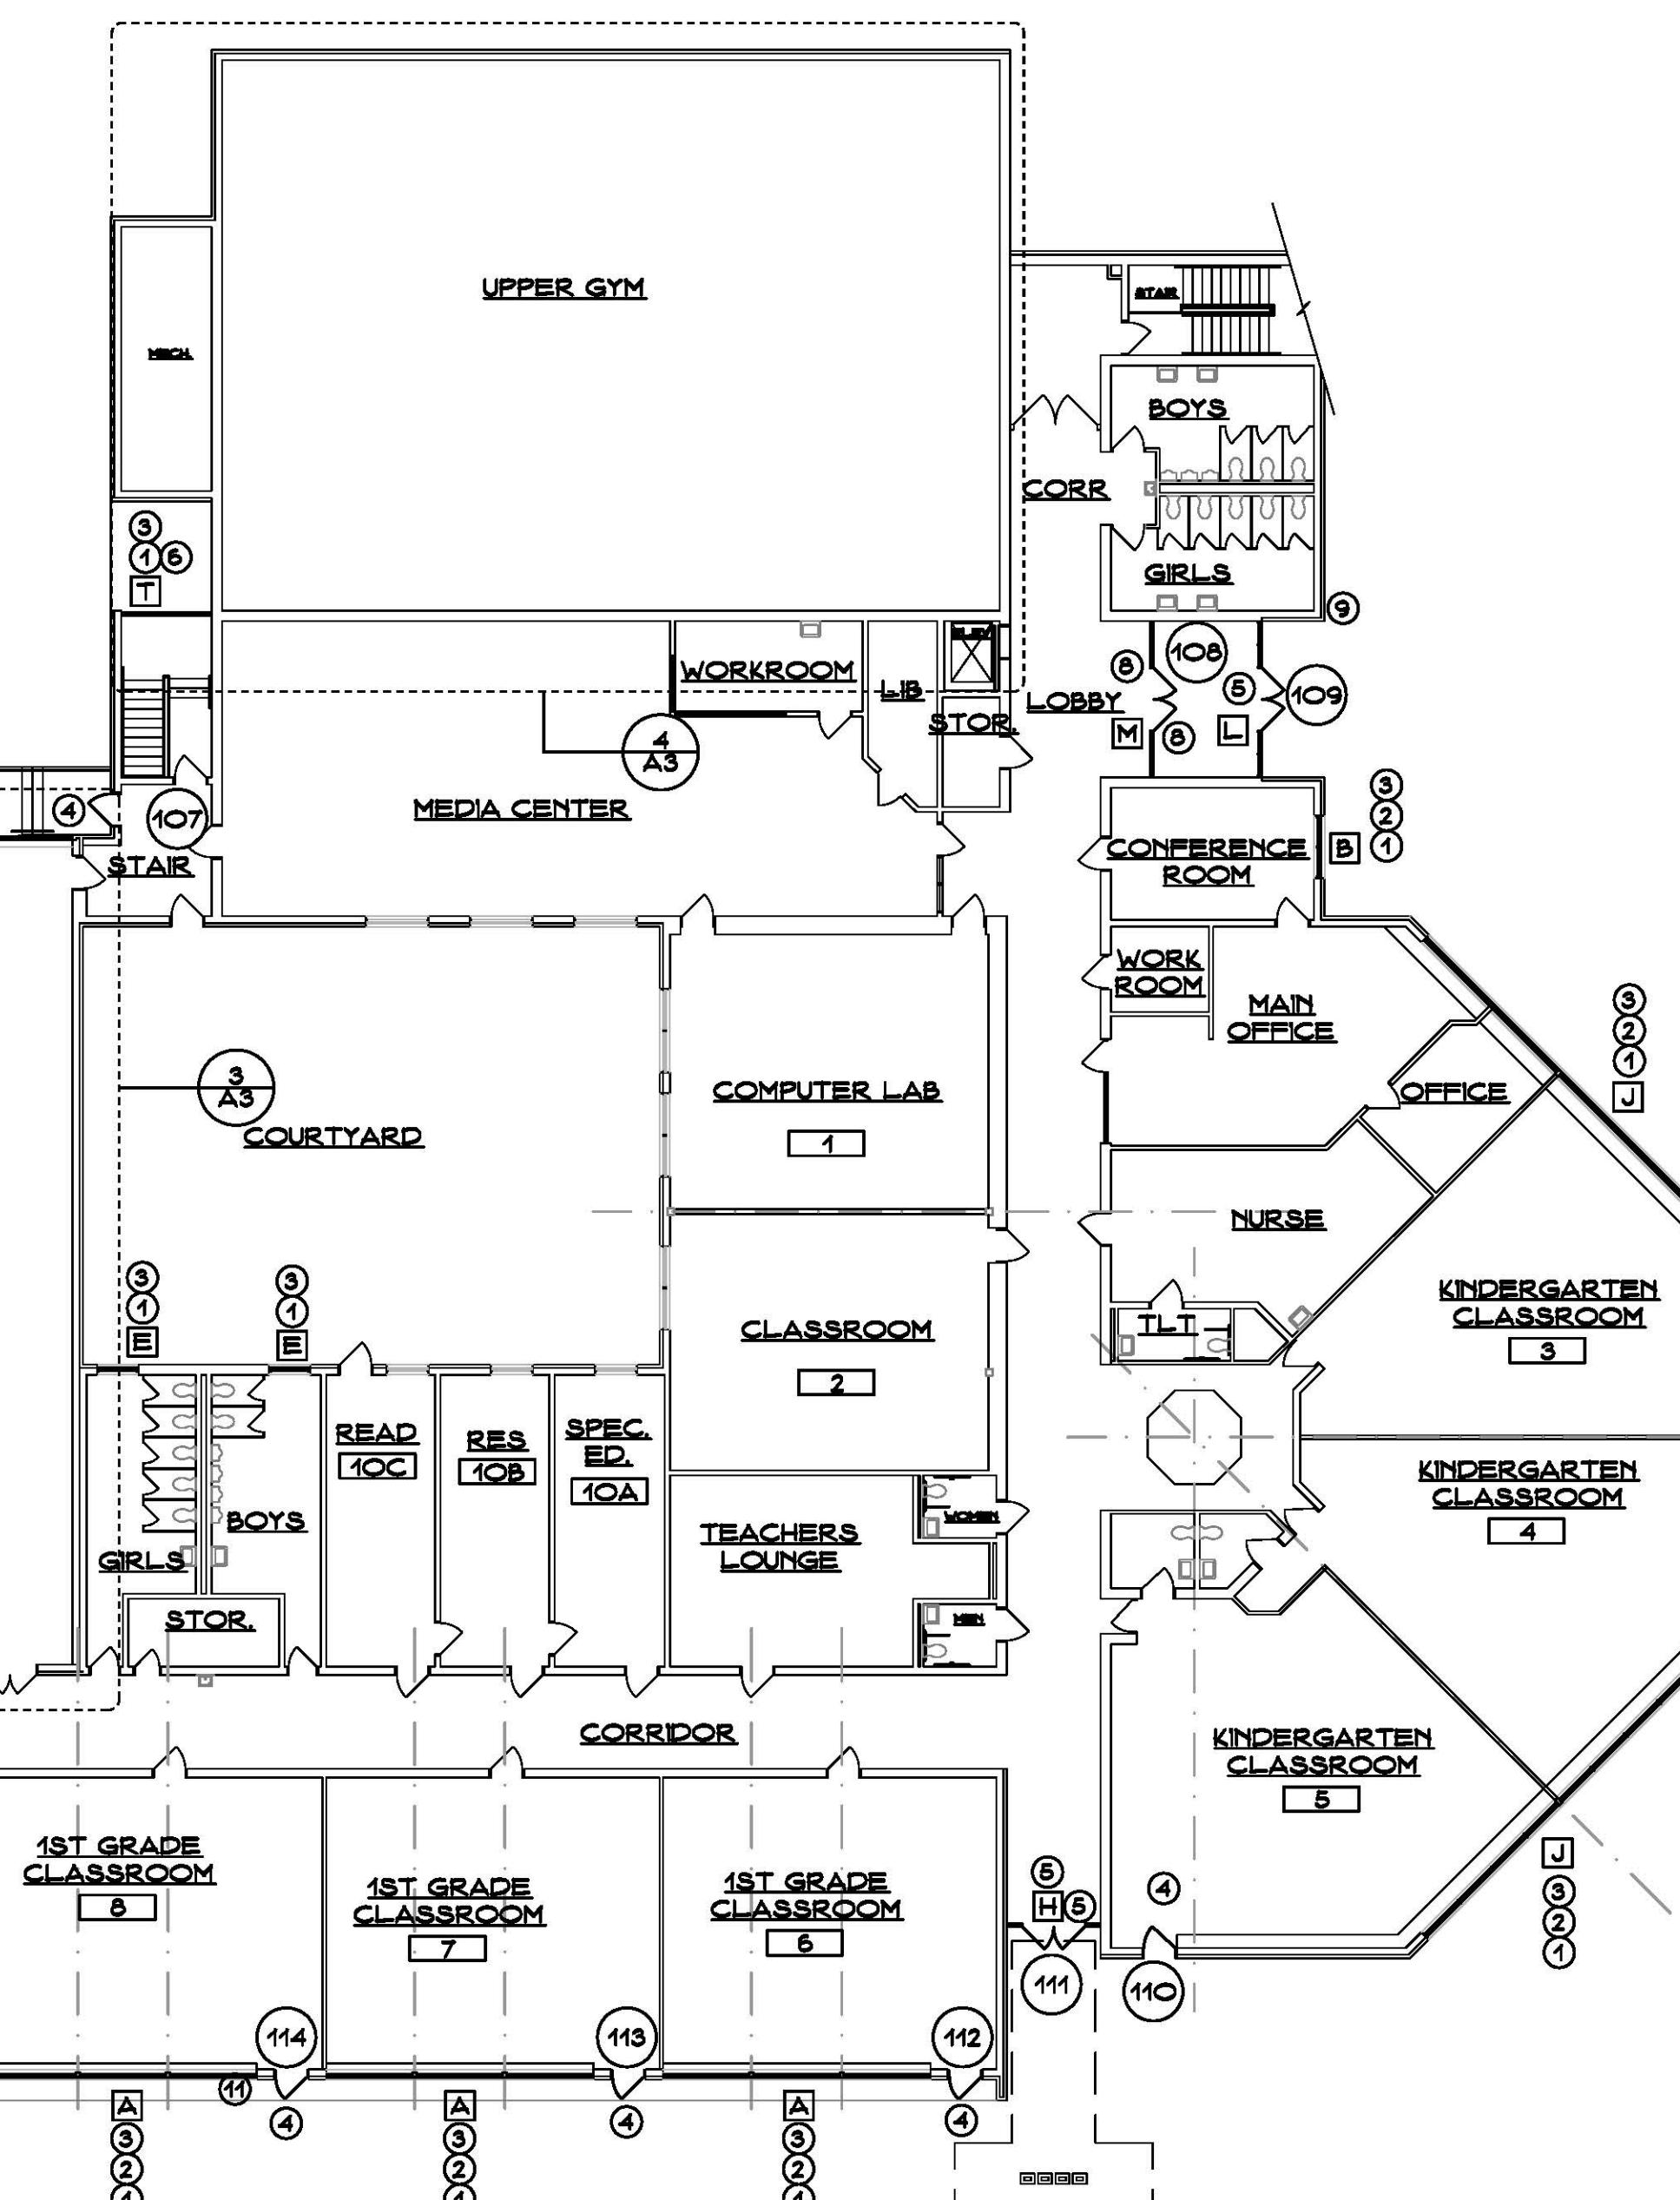


UPPER GYM FLOOR PLAN


SCALE: 1/16" = 1'-0"

4

A3

NORTH

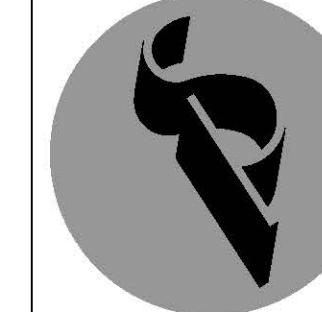


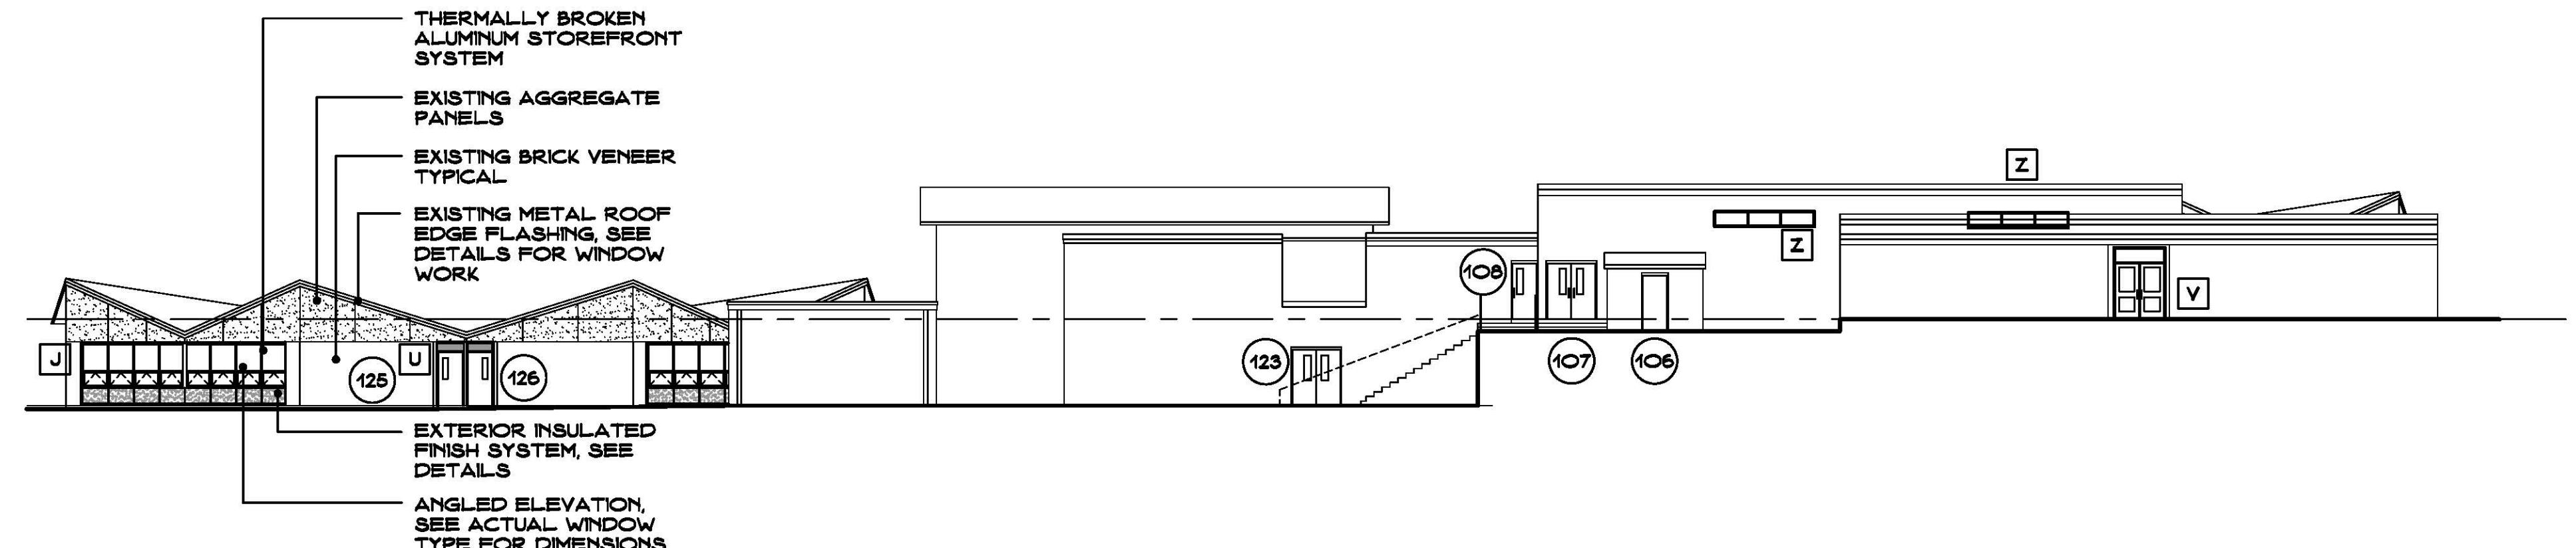

## OVERALL NORTH ELEVATION


---

SCALE: 1/16" • 1"

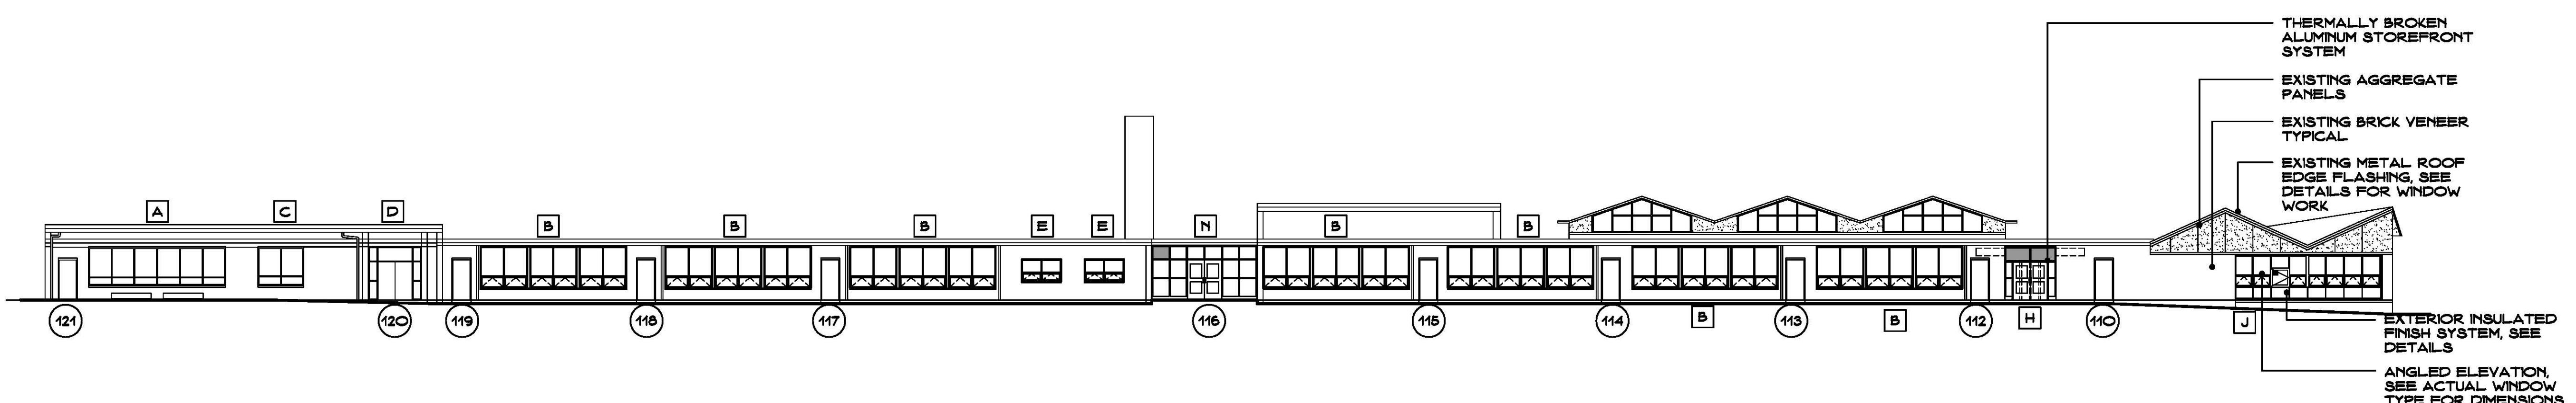

## OVERALL WEST ELEVATION


**SCALE: 1/16" = 1'**

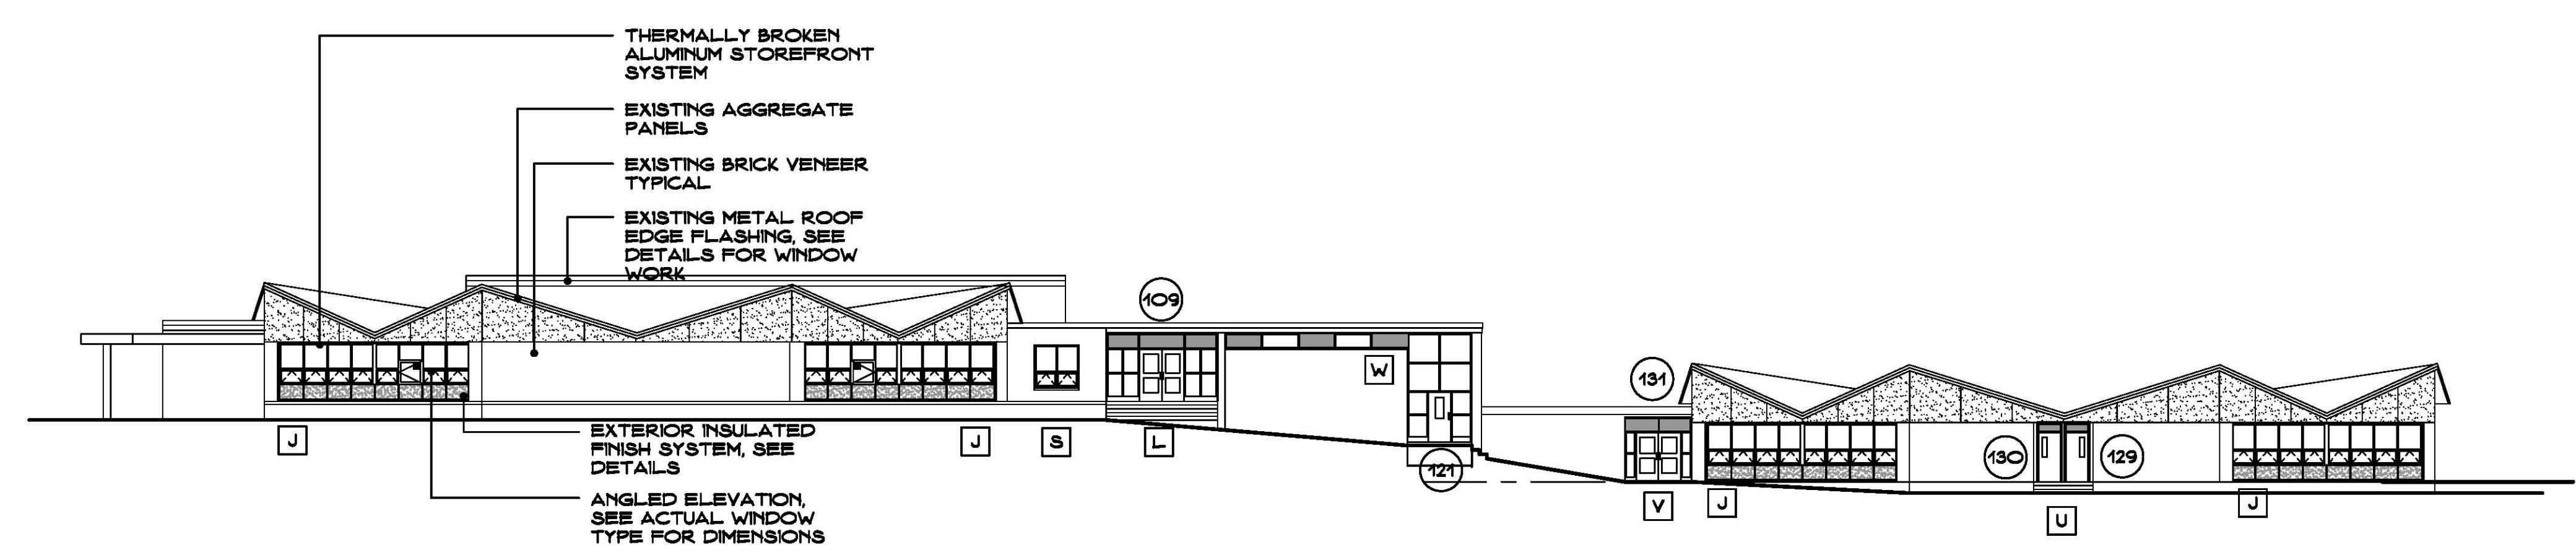

## OVERALL SOUTH ELEVATION


---

**SCALE: 1/16" = 1'-0"**

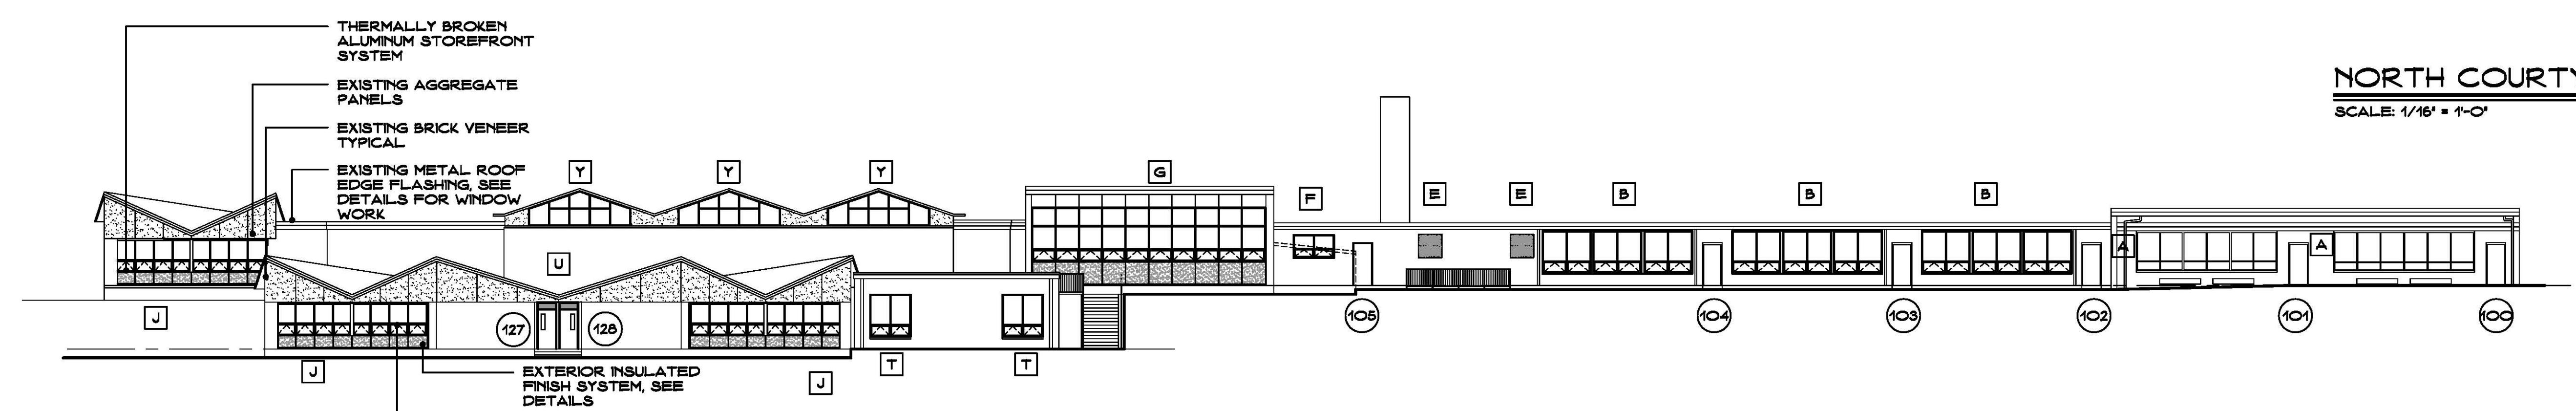

## OVERALL EAST ELEVATION



## **GENERAL**

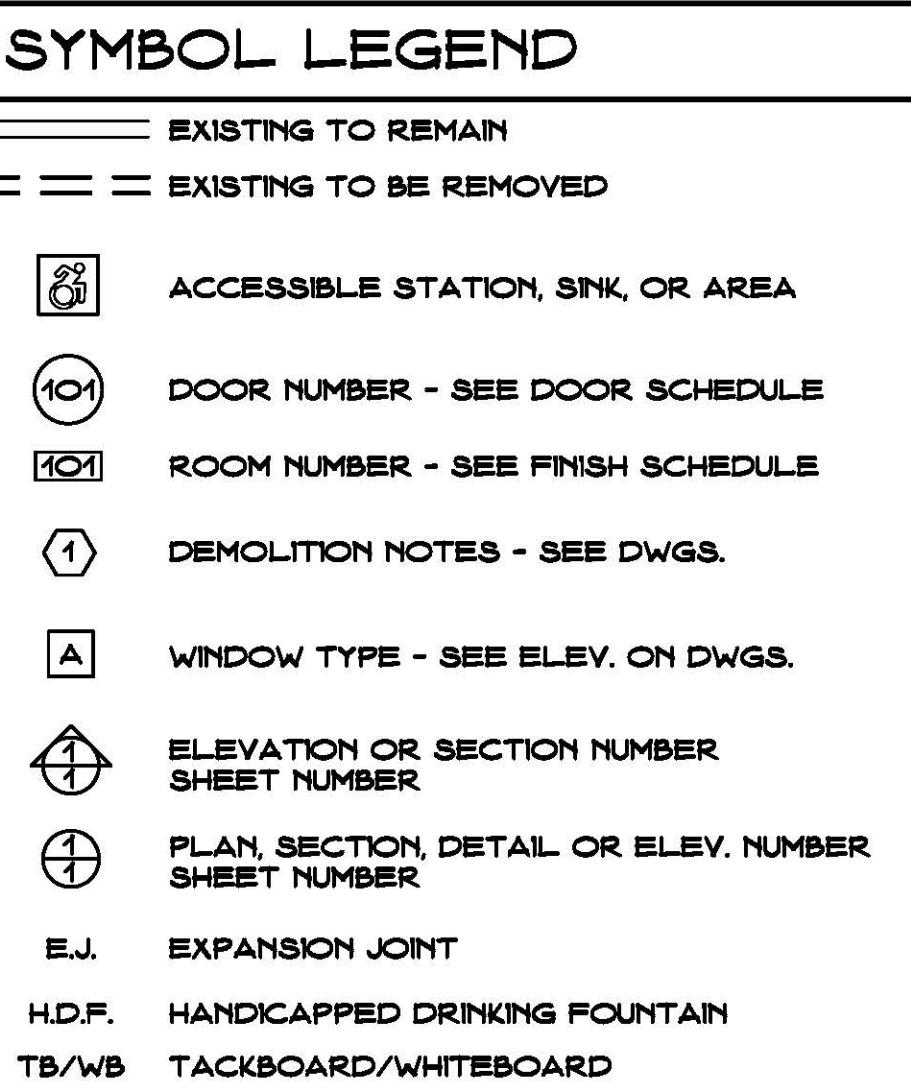




## GENERAL NOTES

1. CONTRACTOR IS RESPONSIBLE TO FIELD VERIFY ALL EXISTING CONDITIONS & DIMENSIONS PRIOR TO CONSTRUCTION.
2. CONTRACTOR IS RESPONSIBLE TO REPAIR OR REPLACE ANY AREAS DAMAGED OUTSIDE THE SCOPE OF WORK RETURNING THEM TO THEIR ORIGINAL CONDITION AT NO EXPENSE TO OWNER.
3. PATCH ALL EXISTING MATERIALS AFFECTED BY NEW CONSTRUCTION IN THIS PROJECT, MATCH EXISTING.
4. ALL MATERIALS & EQUIP. ARE NEW UNLESS OTHERWISE NOTED AS "EXISTING".
5. REMOVE ALL DEMOLISHED MATERIALS FROM SITE. LEAVE SITE CLEAN OF ALL CONSTRUCTION DUST AND DEBRIS AT THE END OF EACH DAY. CONTRACTOR WILL BE RESPONSIBLE FOR ALL CUSTODIAL TIME ASSOCIATED WITH CLEANING NOT PERFORMED BY CONTRACTOR.
6. CONTRACTOR TO PROVIDE FLUSH CONDITION AT ALL MASONRY OPENINGS, CUT BACK EX. STEEL AS REQUIRED.
7. CONTRACTOR IS RESPONSIBLE FOR REMOVING, RELOCATING, AND RECONNECTING ANY AND ALL ELEC. EQUIPMENT, DEVICES, CONDUIT AND WIRING AFFECTED BY THE SCOPE OF WORK PRIOR TO DEMOLITION AND UPON COMPLETION OF CONSTRUCTION. CONTRACTOR TO VERIFY ALL ASSOCIATED COMPONENTS AFFECTED BY THE SCOPE WORK.
8. CONTRACTOR RESPONSIBLE TO SURVEY AND DOCUMENT ALL LOCATIONS OF EXTERIOR WORK PRIOR TO BID. CONTRACTOR IS RESPONSIBLE TO CARRY ALL TRADES IN BID NEEDED TO REMOVE AND REINSTALL ALL OBJECTS ATTACHED TO EXISTING BRICK VENEER AFFECTED BY SCOPE OF WORK (I.E. ROOF LADDERS, EXHAUST, LOUVERS, SIGNAGE, ALARM SYSTEMS, ELEC. CONDUIT, AND ANY OTHER MISC. ITEMS).
9. CONTRACTOR TO COORDINATE AND REFERENCE EACH DISCIPLINE WITHIN THE DRAWING SET PRIOR & DURING CONSTRUCTION.
10. ANY DEMOLITION/CONSTRUCTION ACTIVITY WHICH WOULD IMPACT LEAD AND/OR ASBESTOS (TOXIC/NON-TOXIC) MUST BE CONDUCTED WITHIN COMPLIANCE AND TO CODE REQUIREMENTS (SEE PROJ. MAN.)

**KEY PLAN**      SCALE: NONE

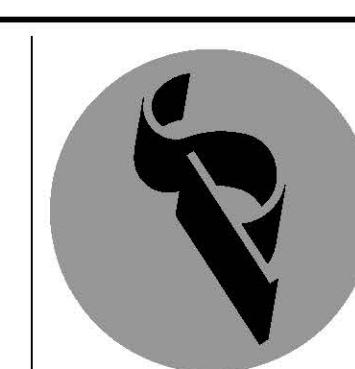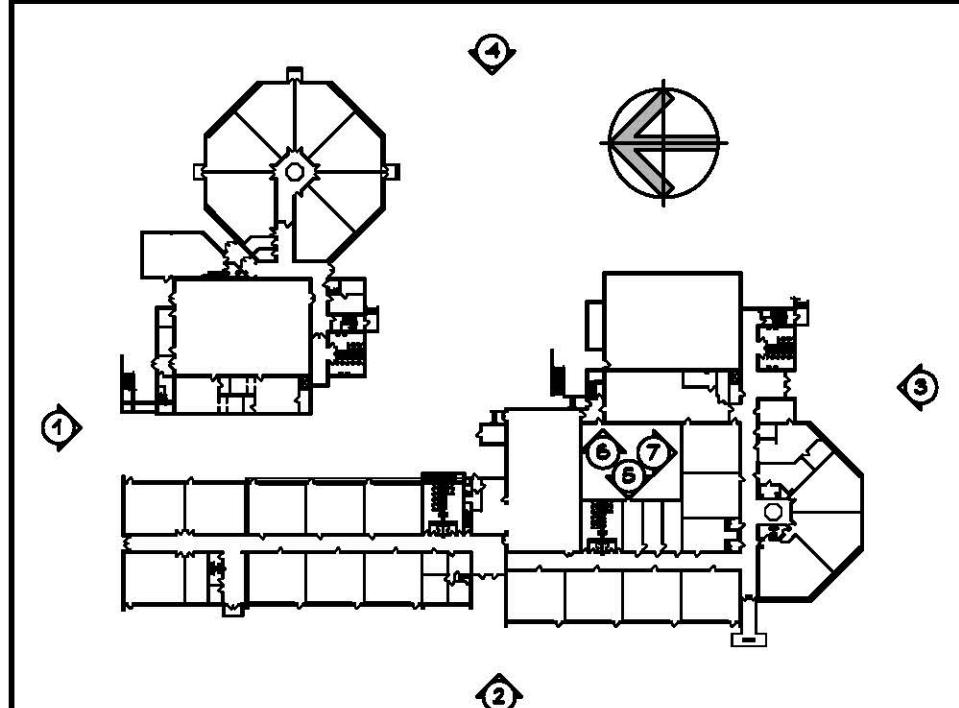


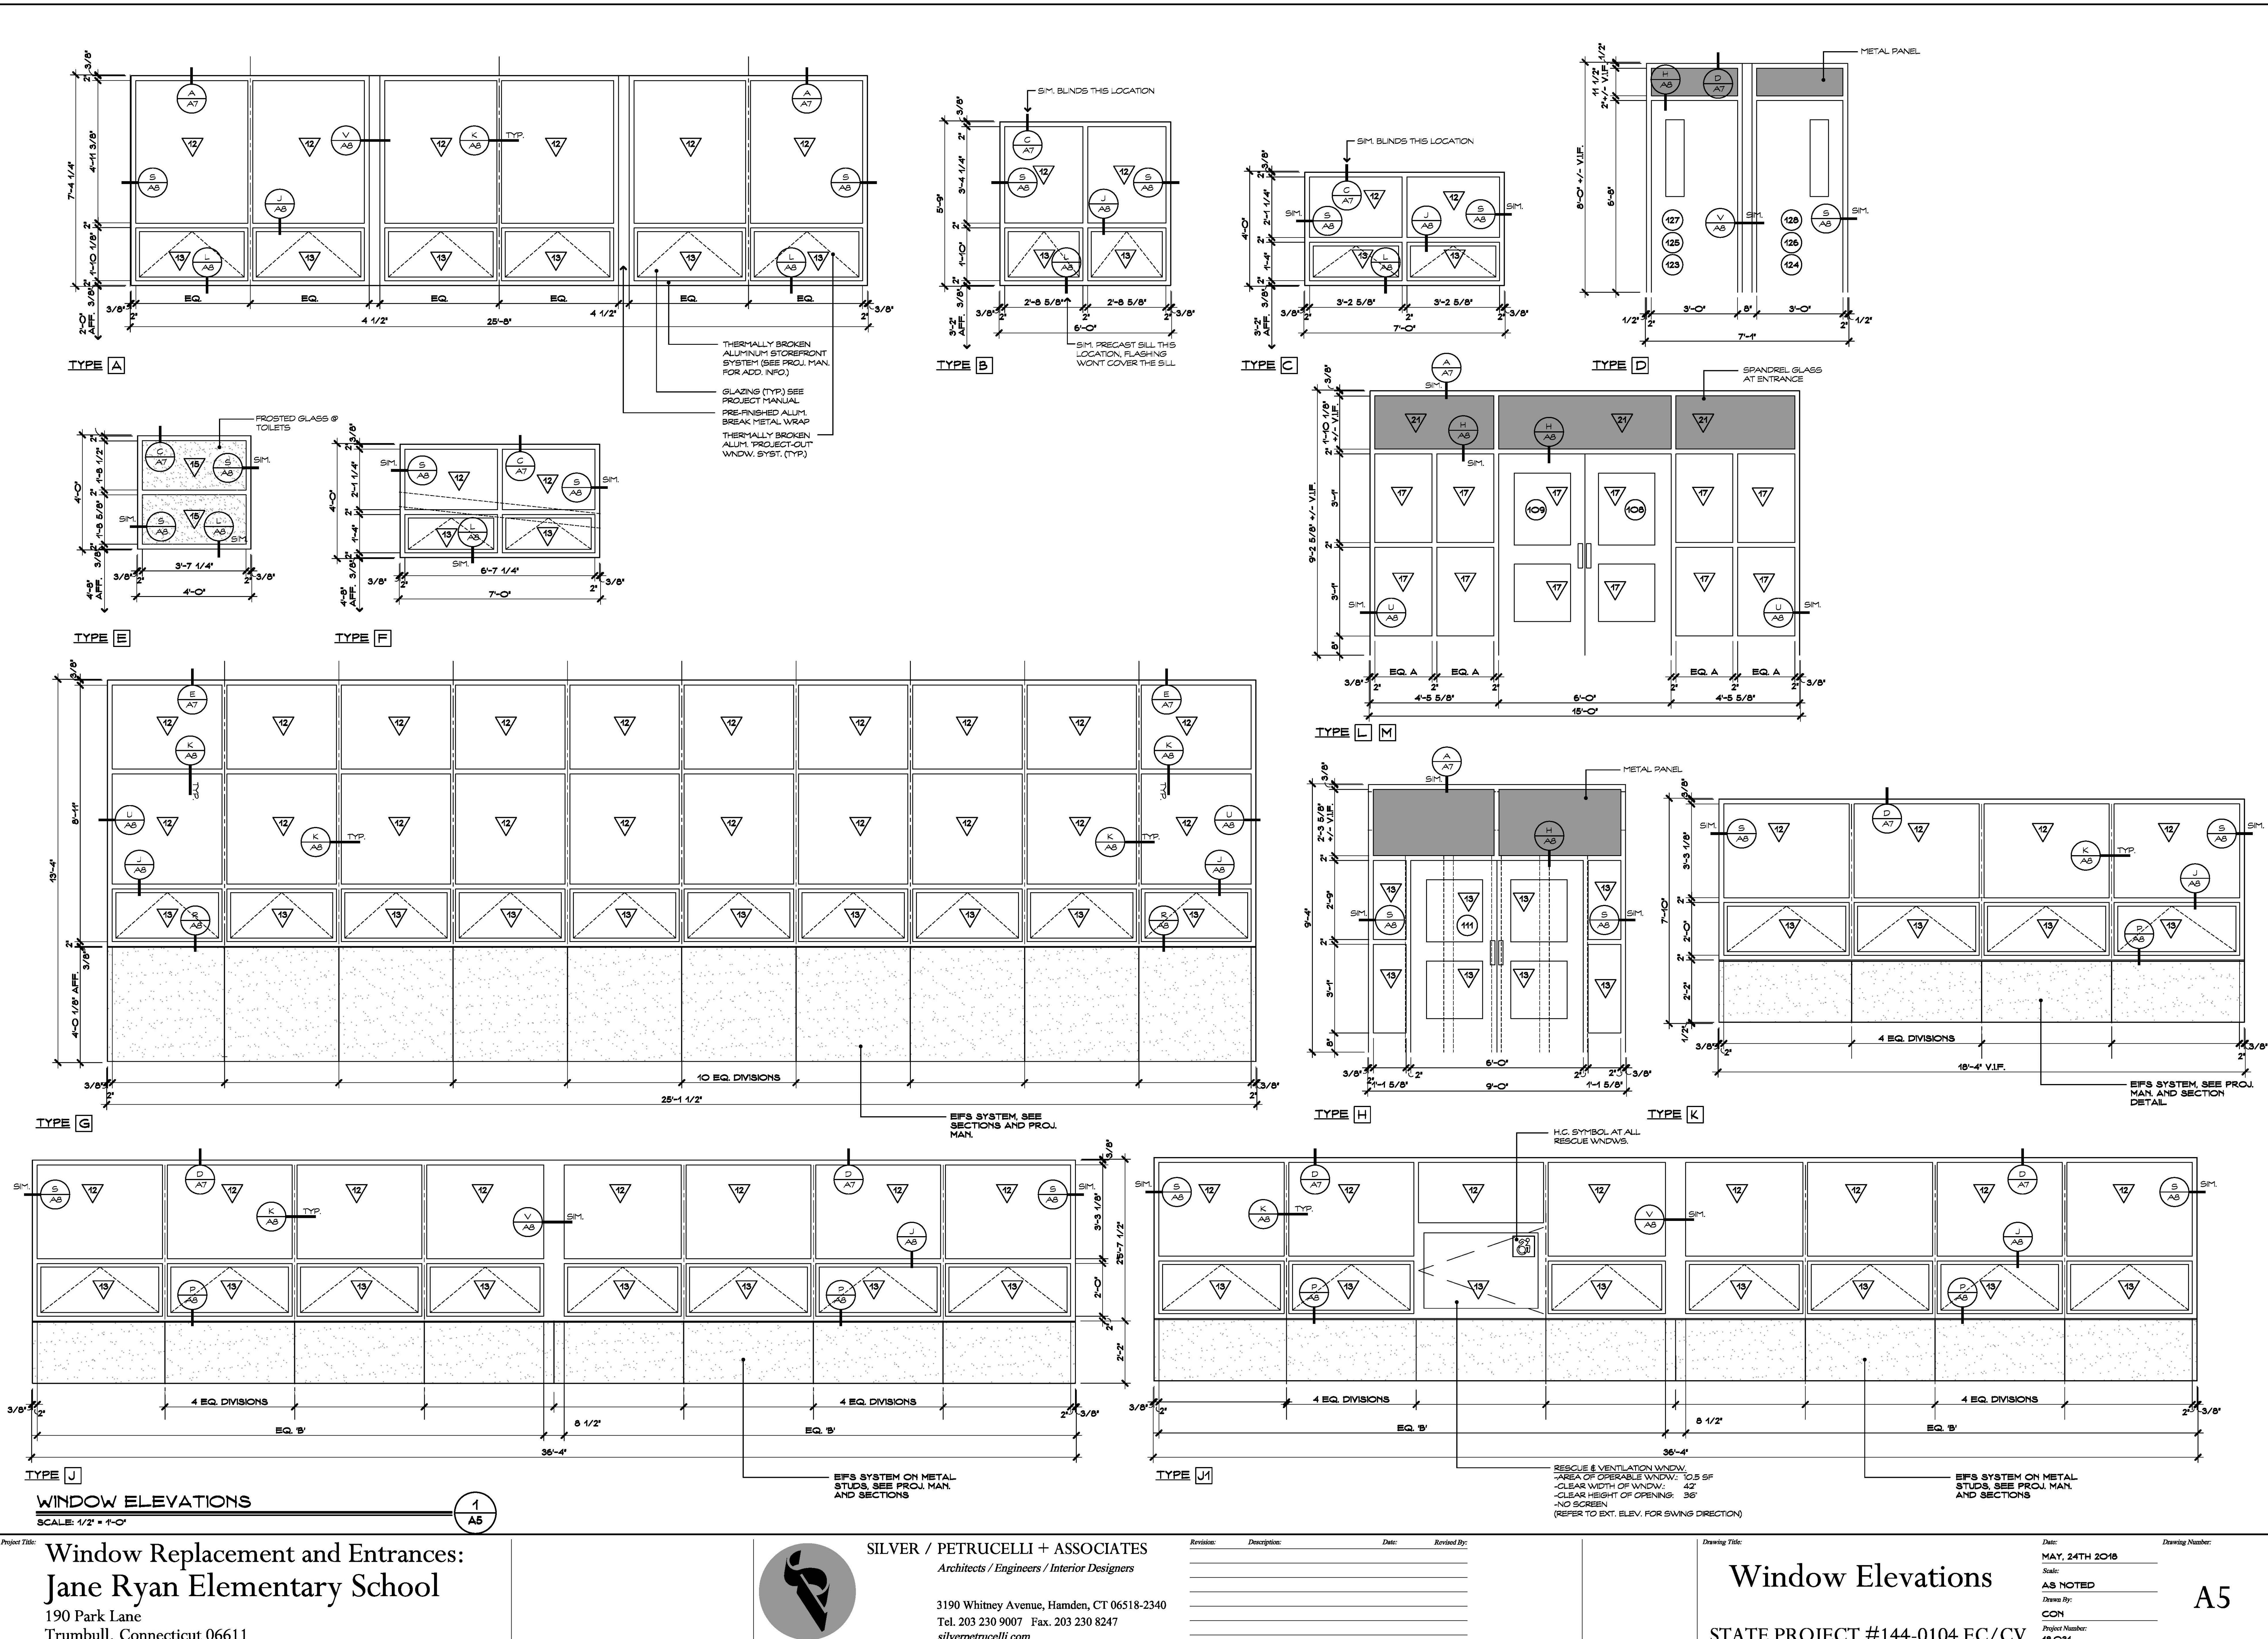

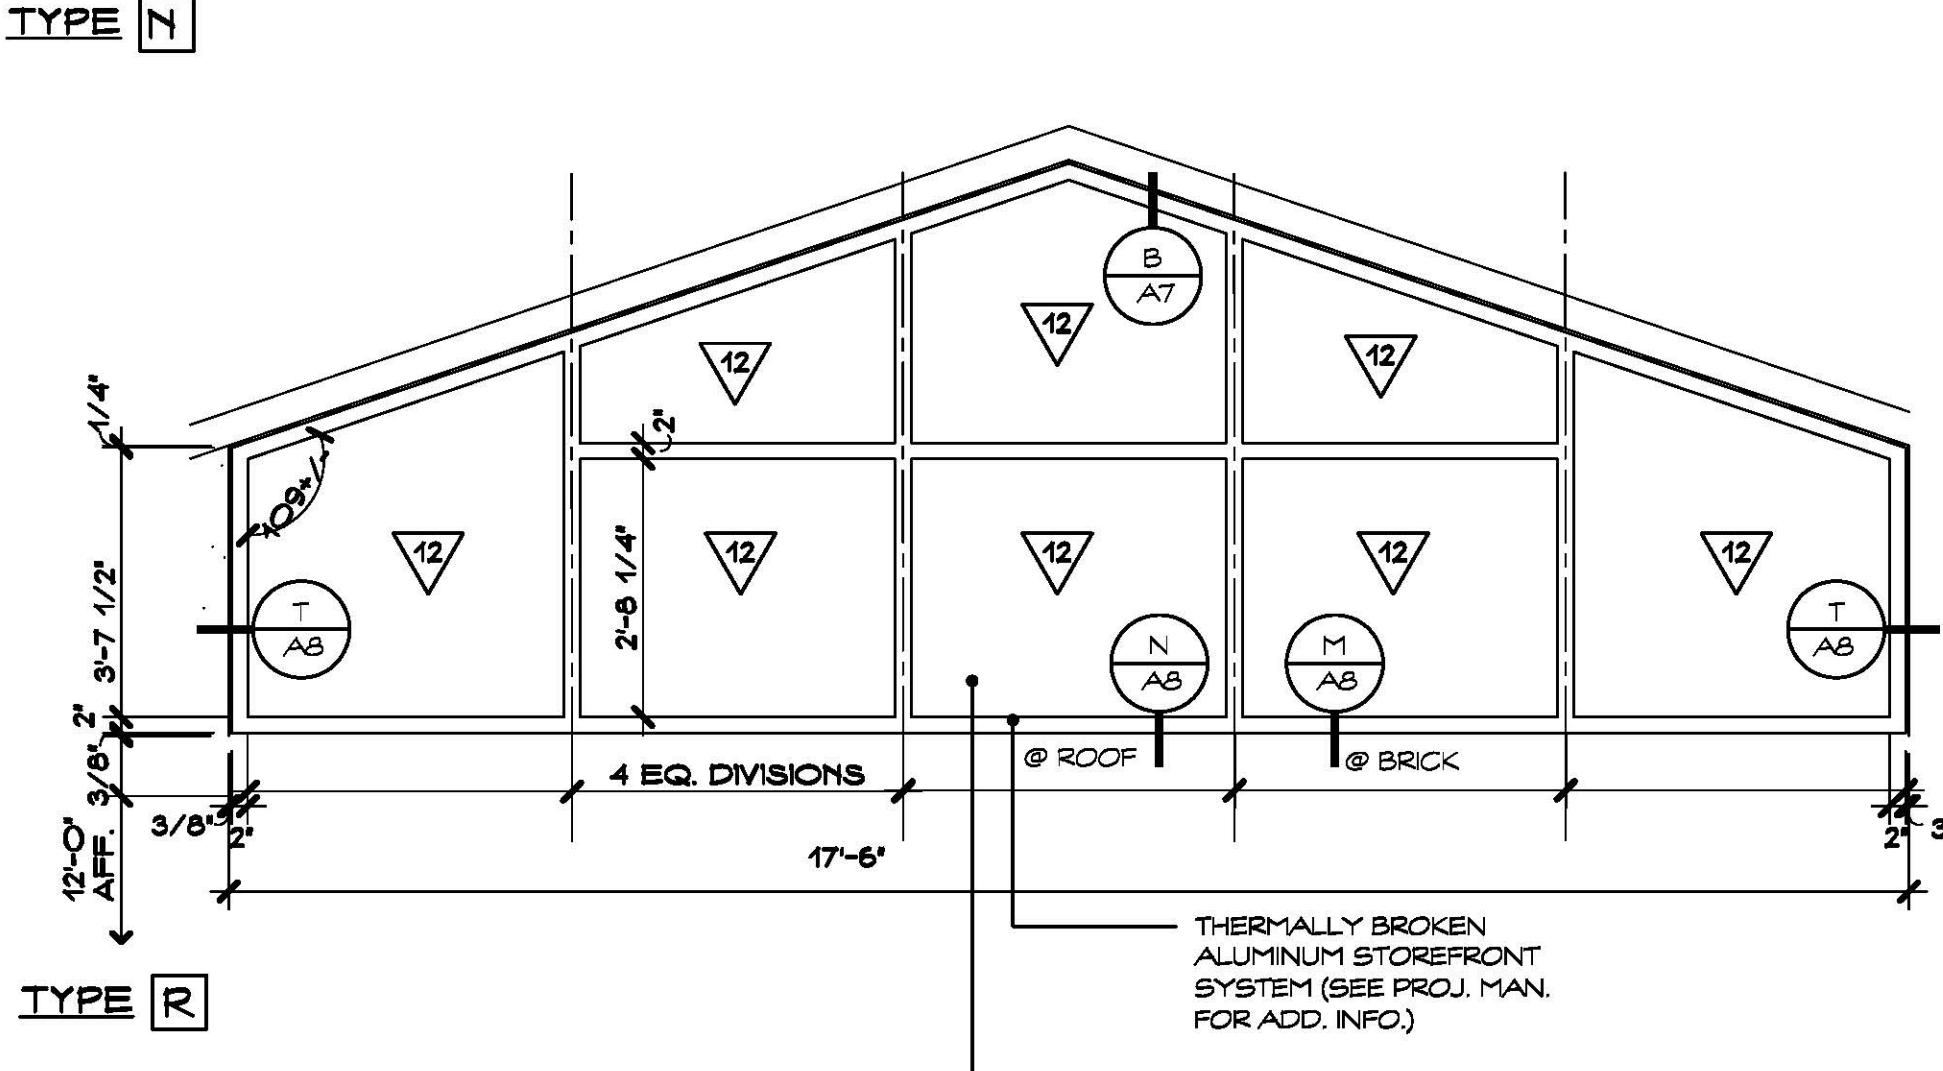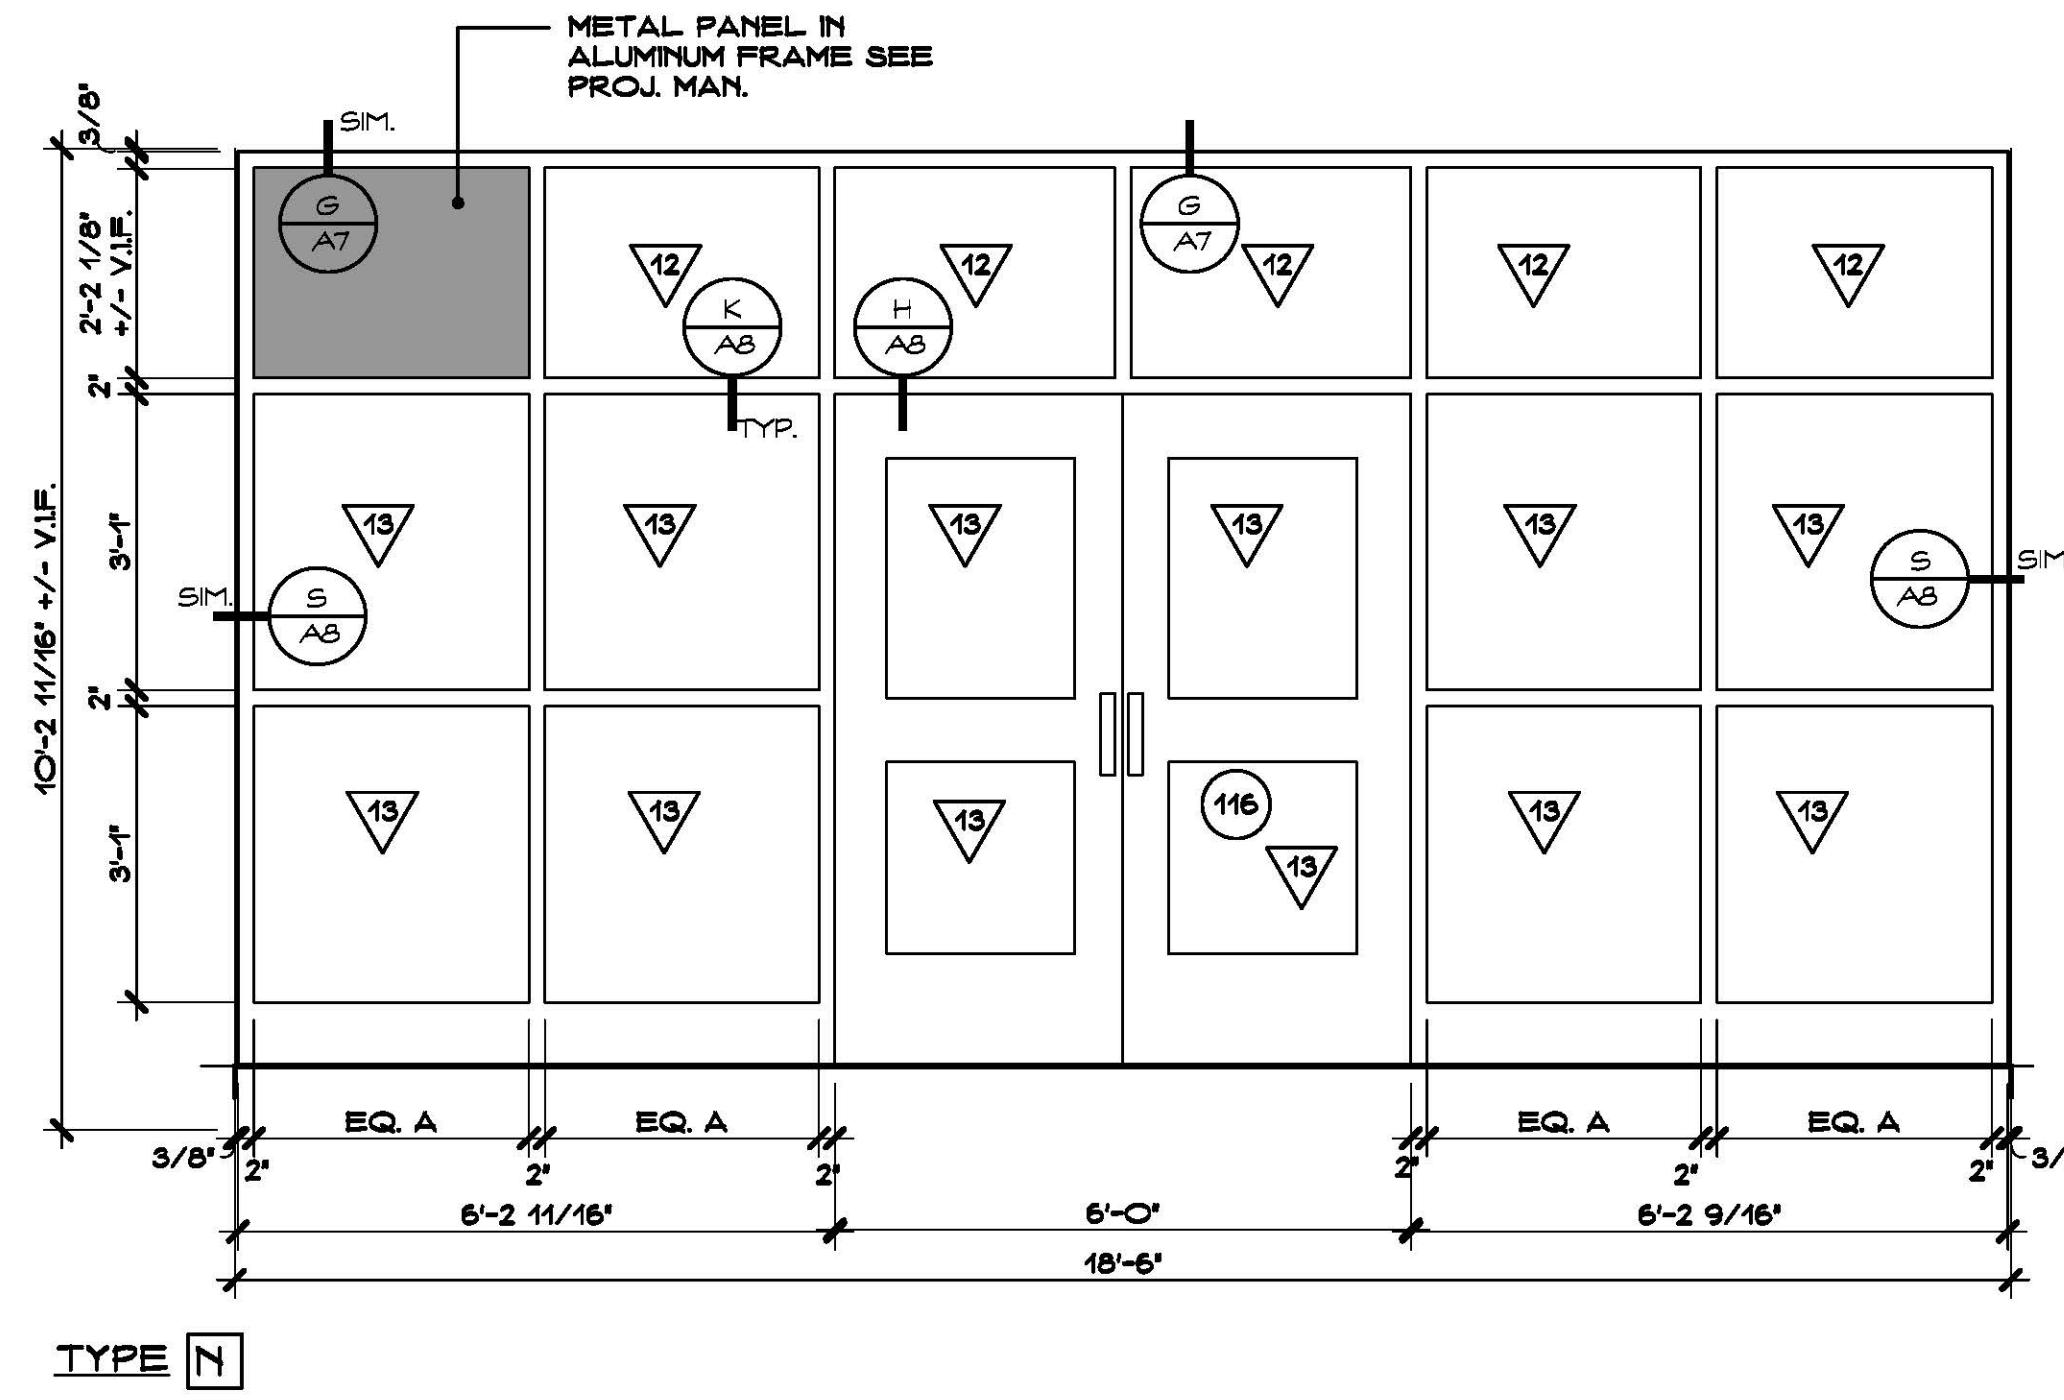

## WINDOW ELEVATIONS


**SCALE: 1/2" = 1'-0"**

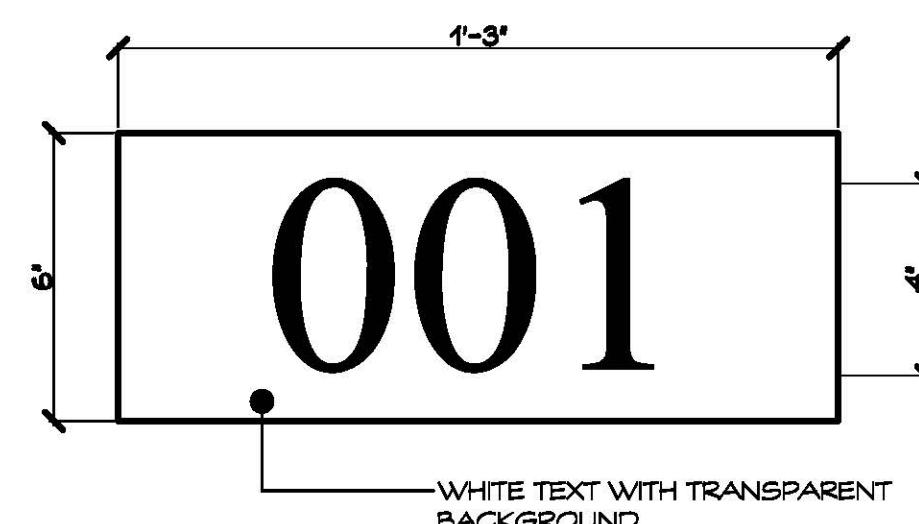


PROVIDE CLASSROOM NUMBER DECAL AT ALL CLASSROOMS HAVING EXTERIOR WINDOWS. PLACE DECALS (2 PER CLASSROOM) IN THE UPPER RIGHT HAND CORNER OF THE UPPERMOST WINDOWS (LEFT AND RIGHT HAND SIDE). SIGNAGE SPECIFICATIONS AND INSTALLATION SHALL BE IN COMPLIANCE WITH ADA STANDARDS AND OTHER APPLICABLE REGULATIONS AS REQUIRED. TYPICAL FOR ALL STOREFRONT AND CURTAIN WALL ASSEMBLIES. REFER TO CLASSROOM DECAL.

## WINDOW DECAL


SCALE: 3" ■ 1'-0"

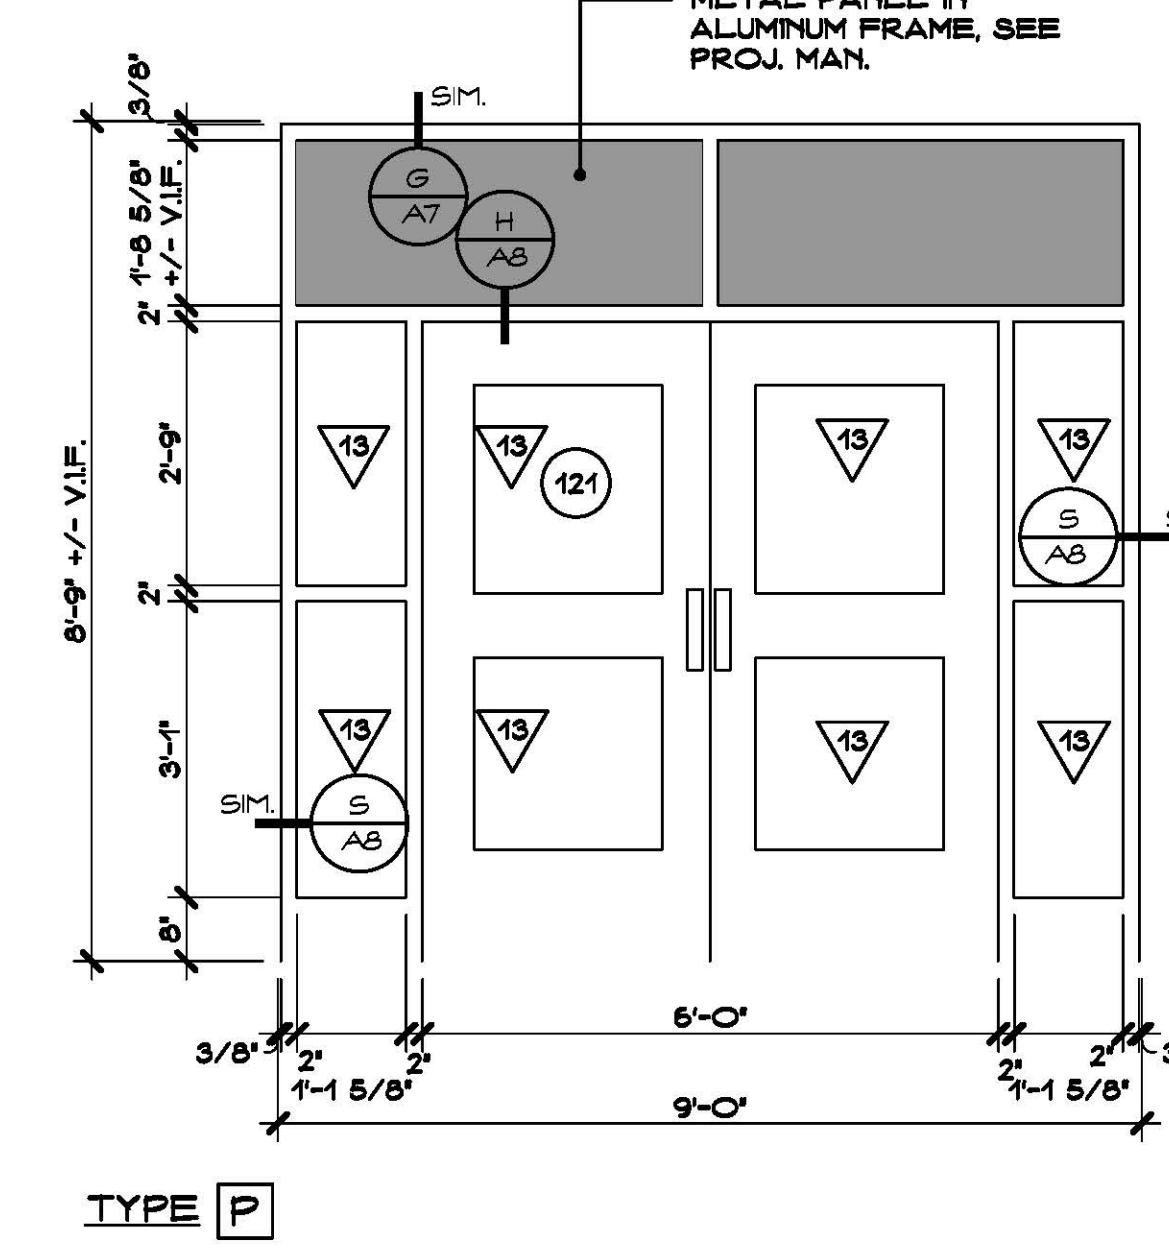


## TYPE

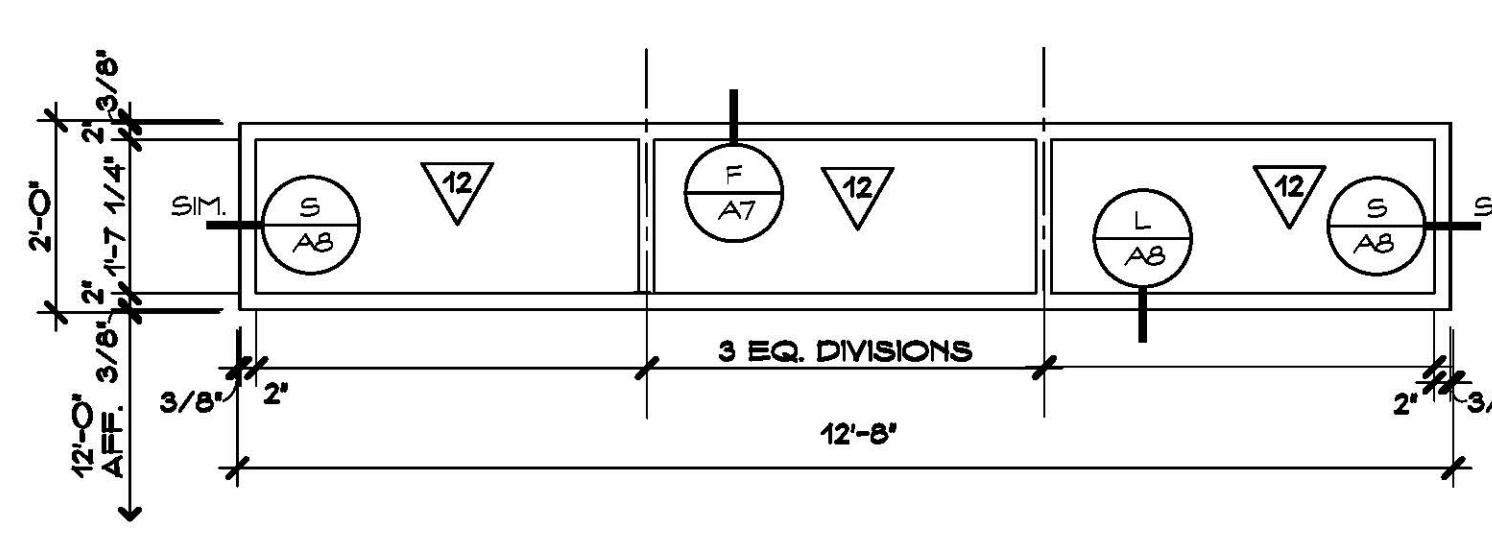


TYPE  S

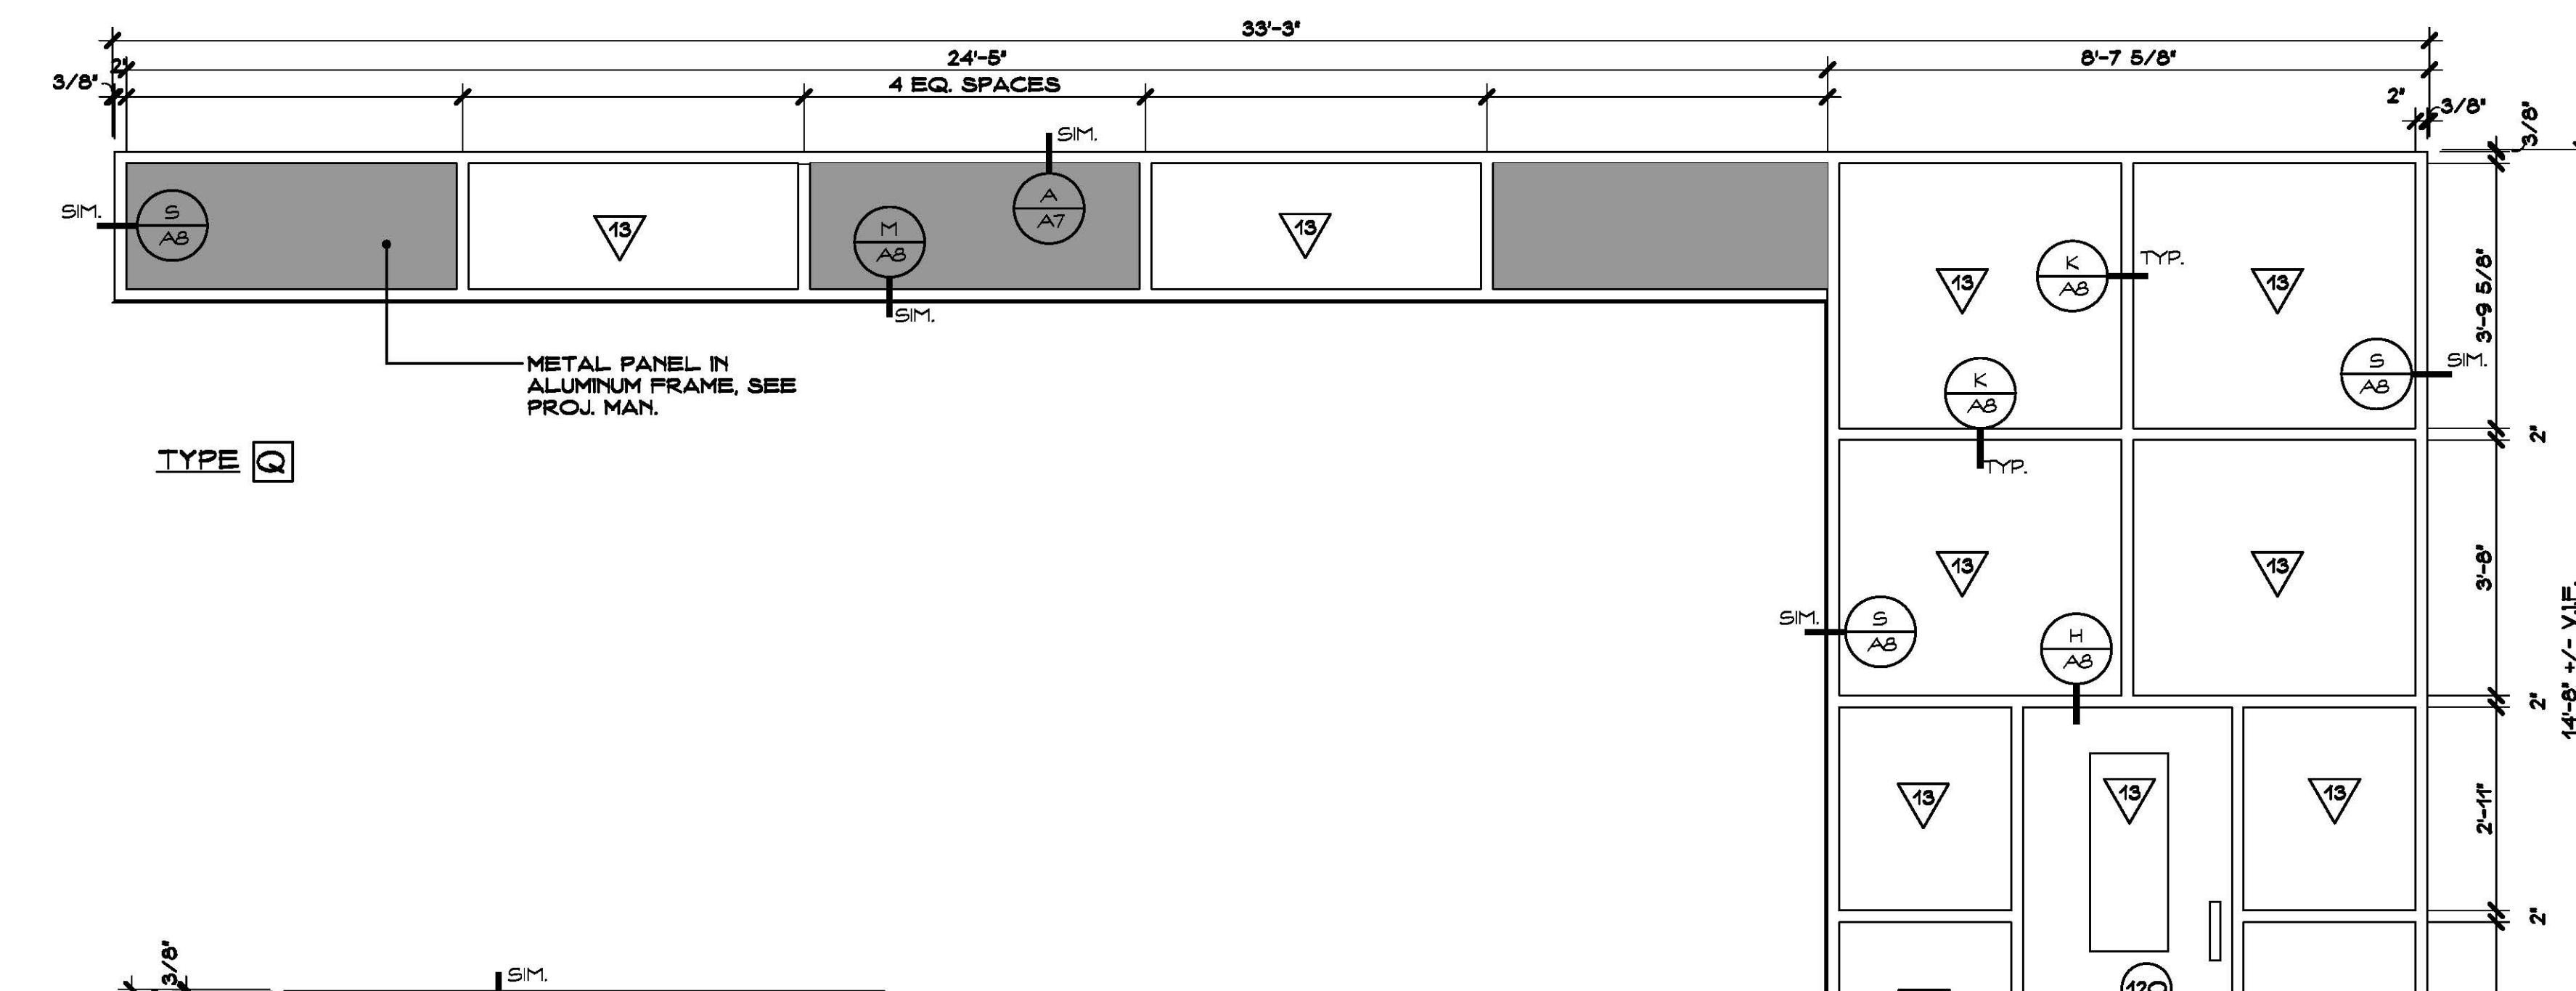


### TYPE

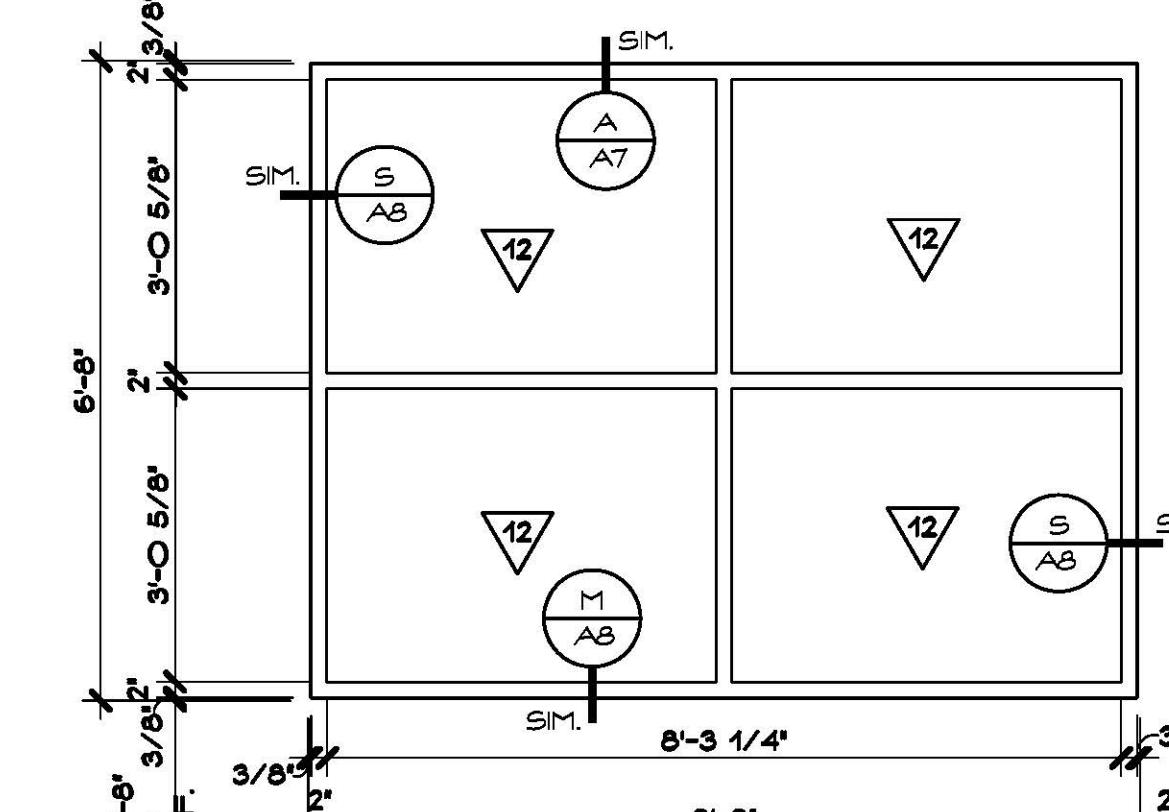

TYPE

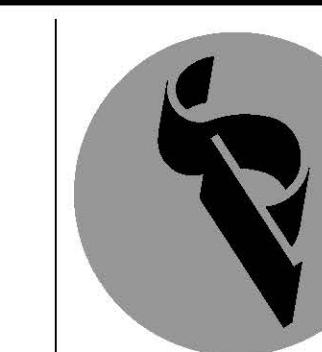


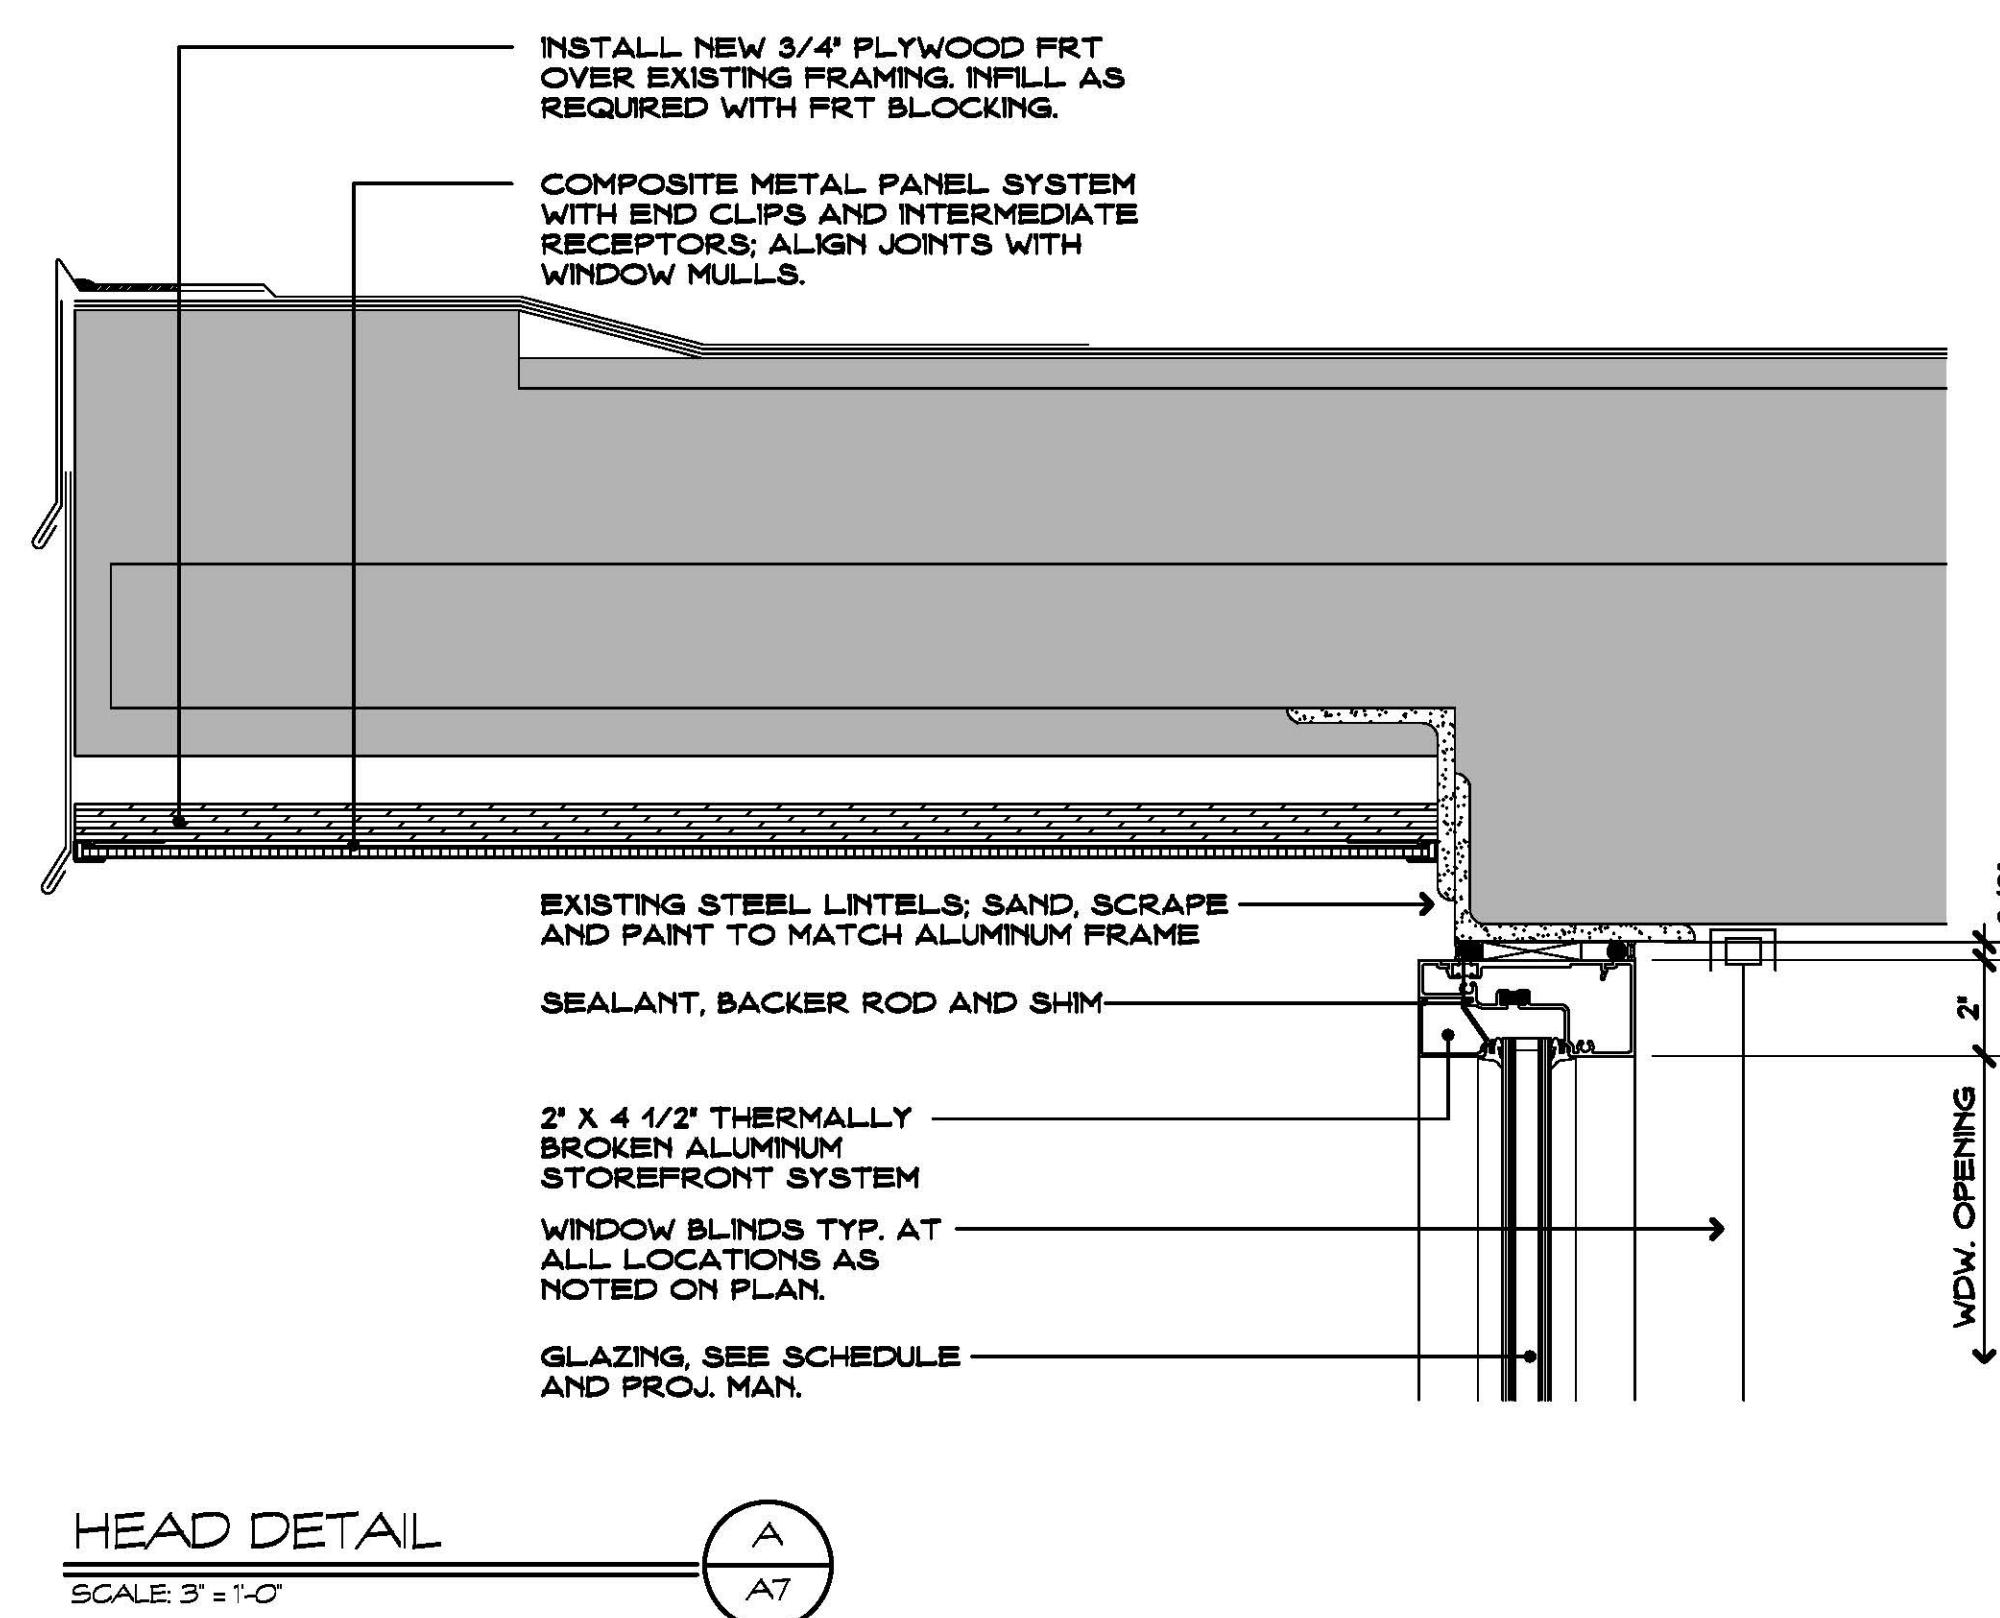


## HEAD DETAIL

---


SCALE: 3" = 1'-0"

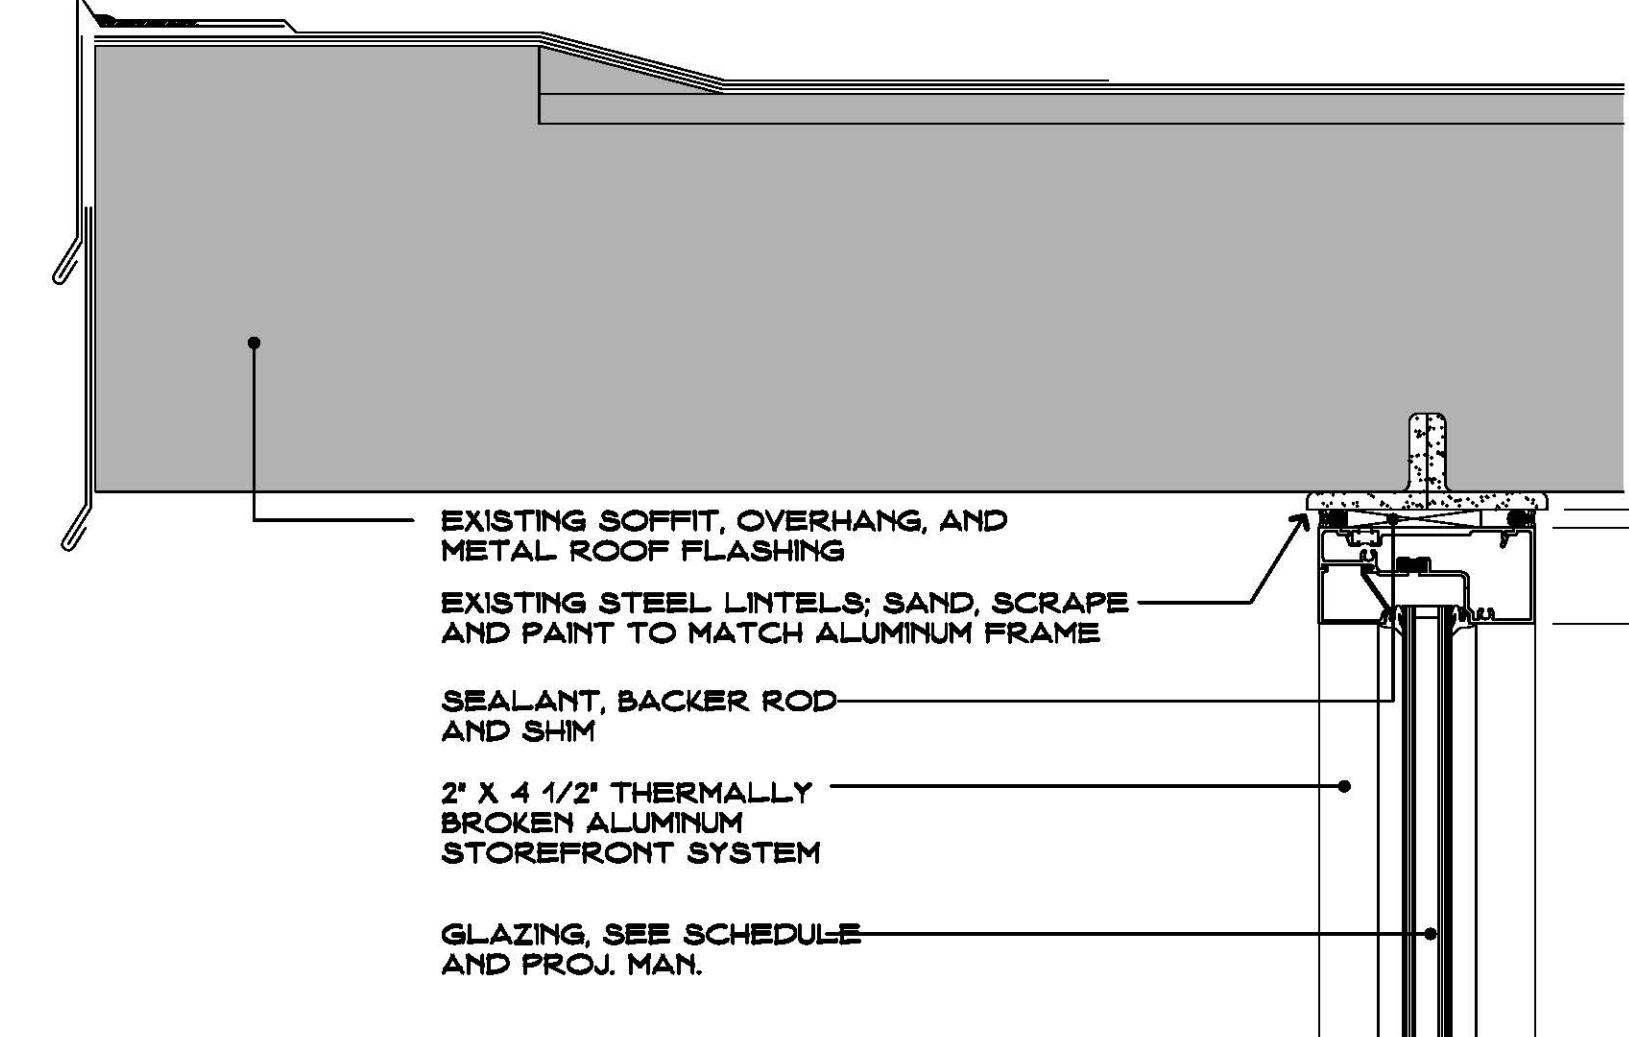


## HEAD DETAIL

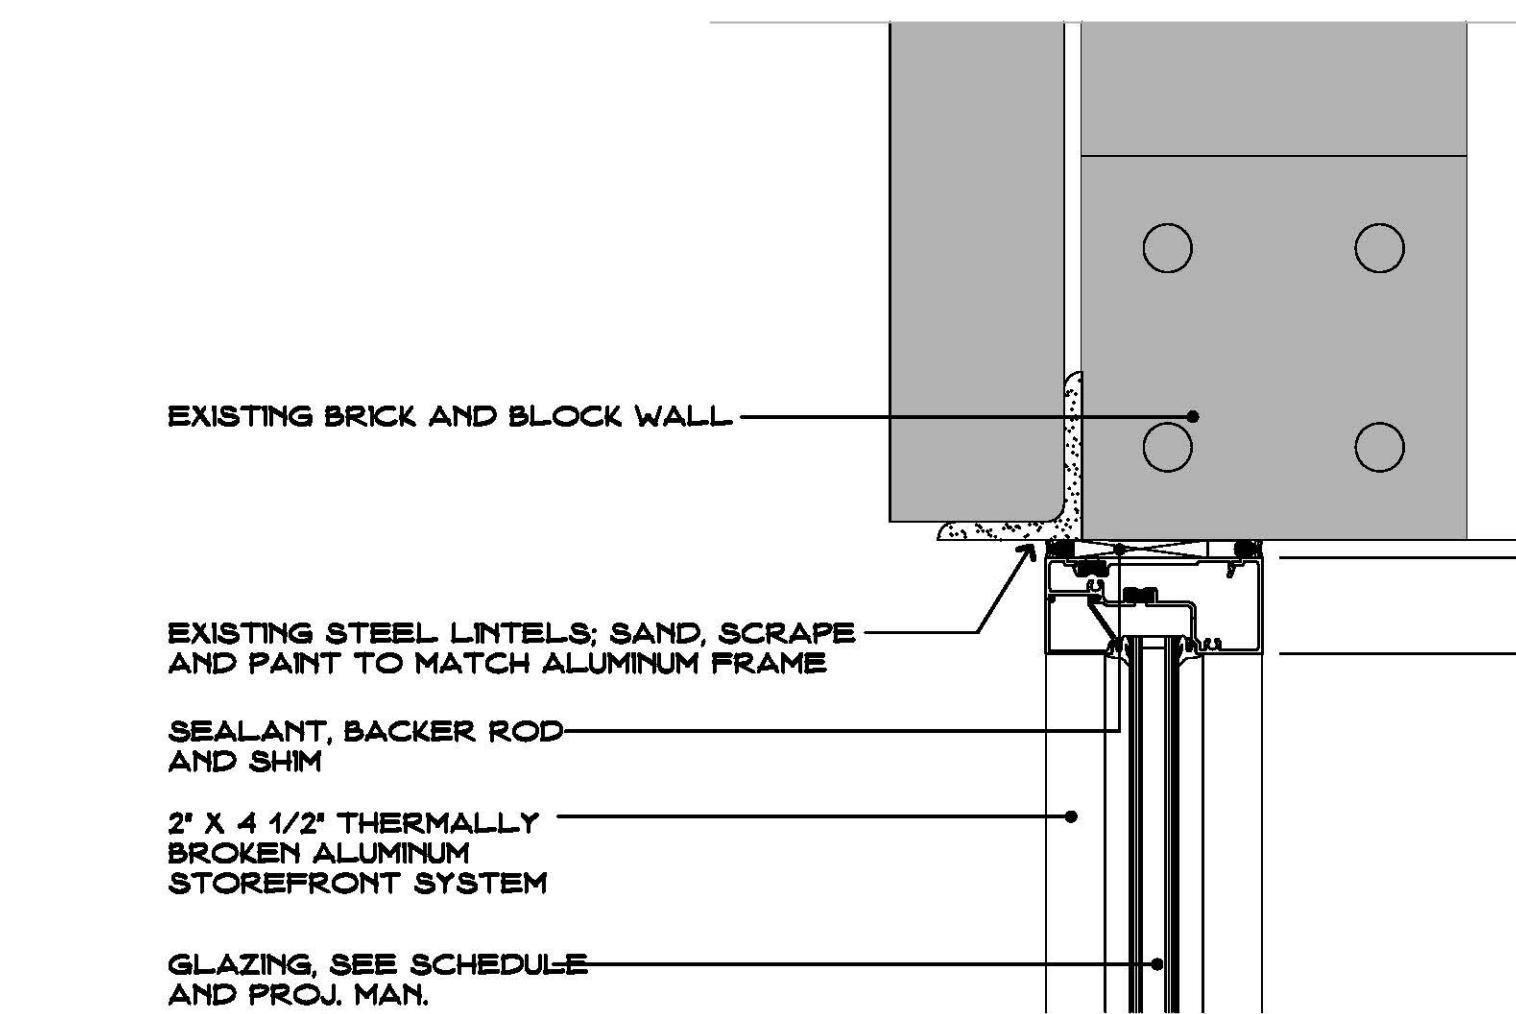


## HEAD DETAIL

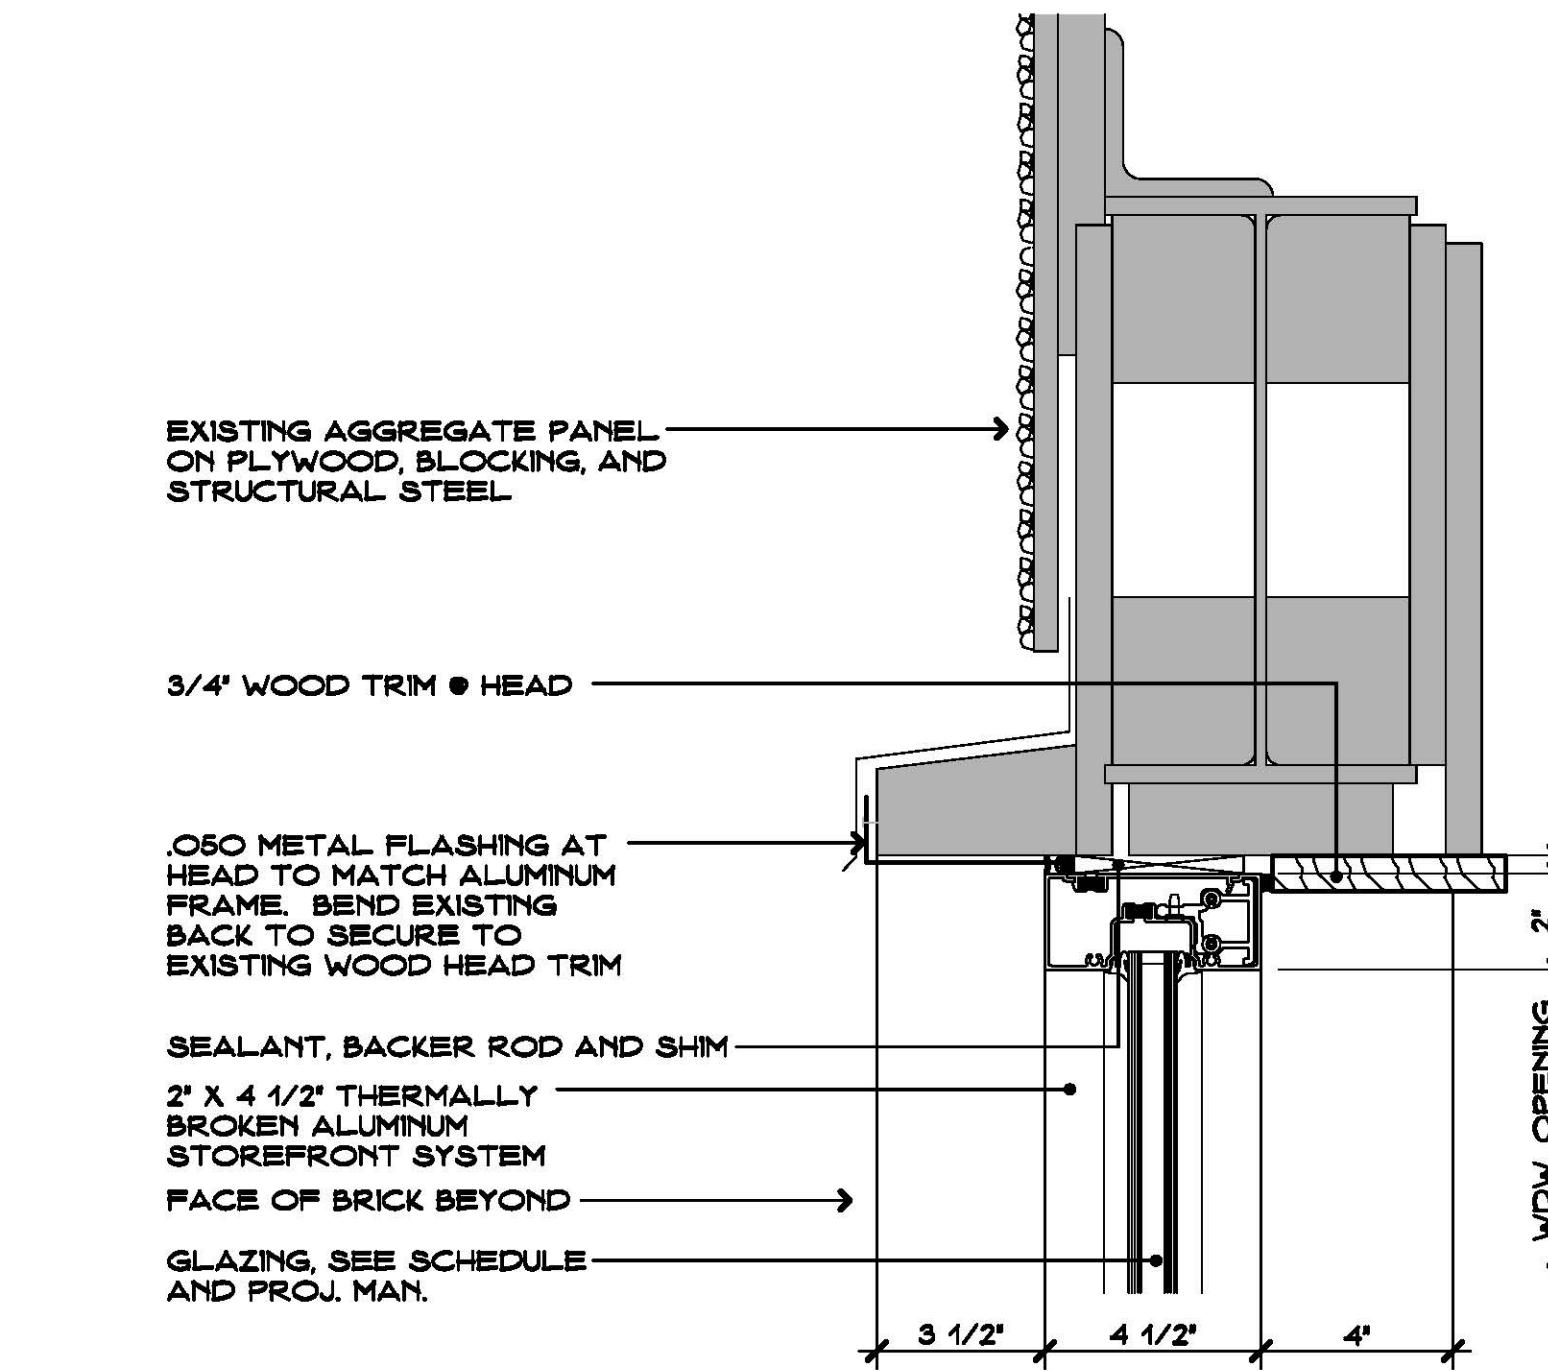


## HEAD DETAIL

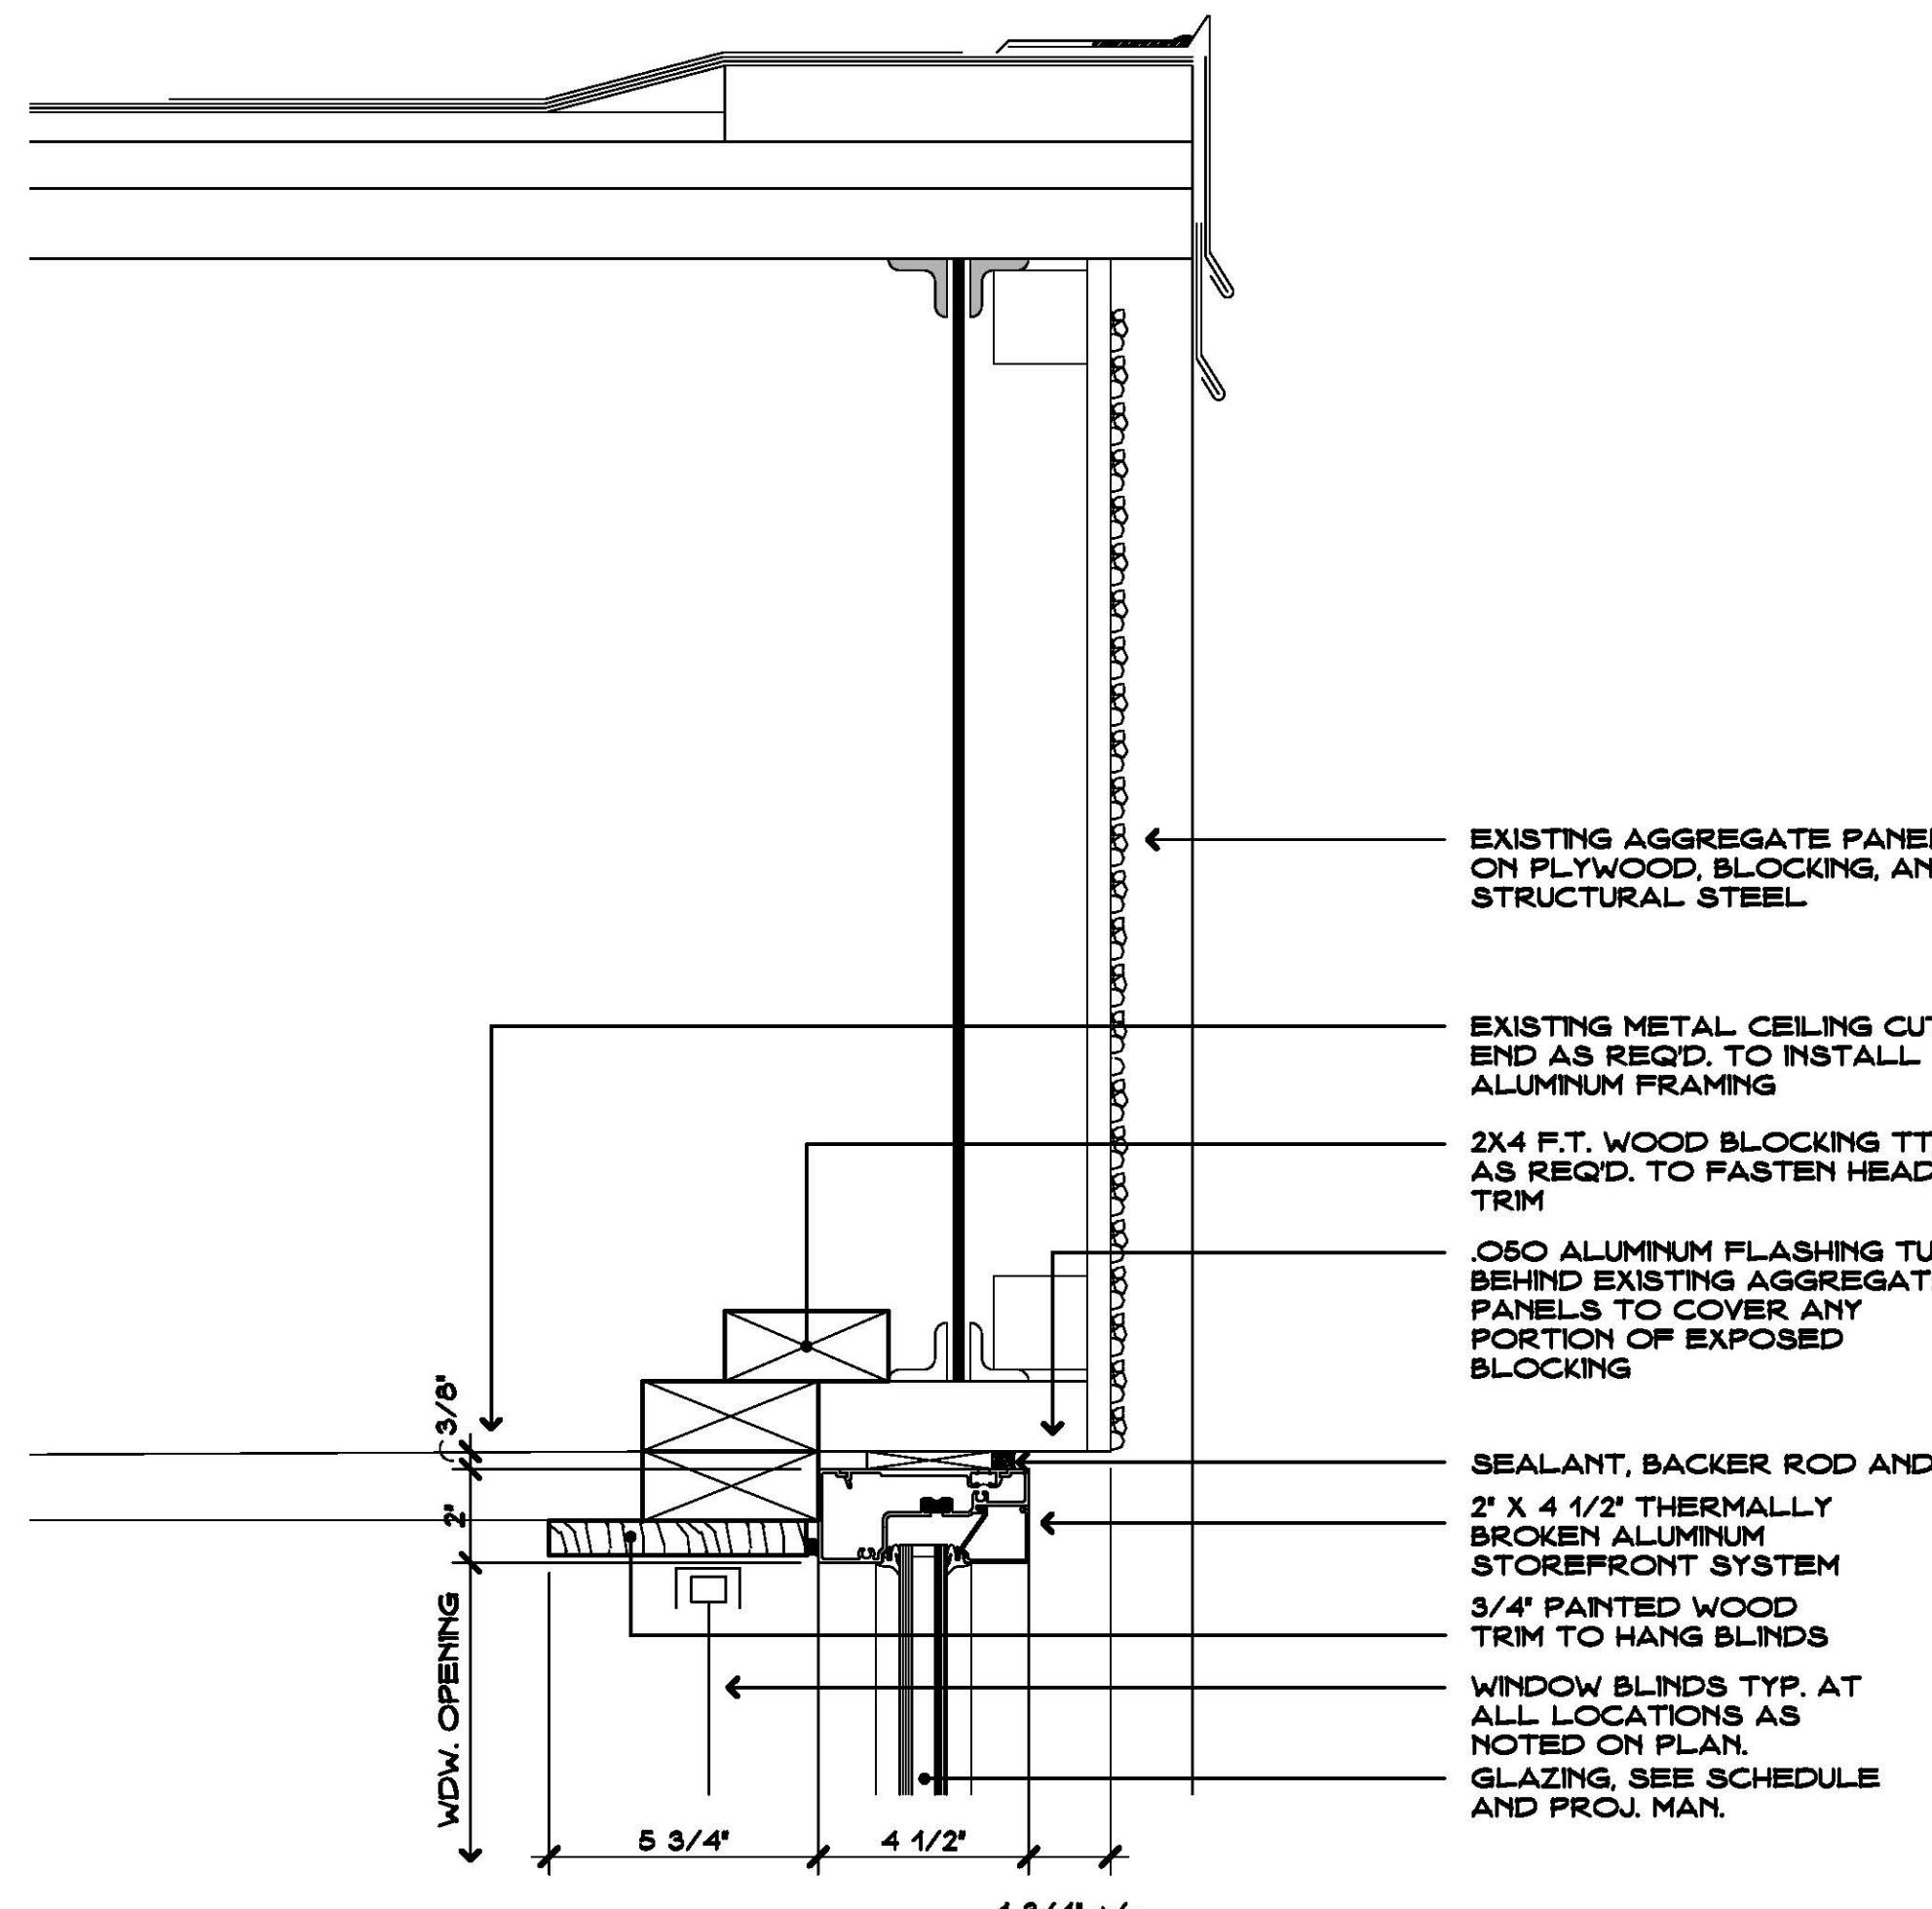

# HEAD DETAIL

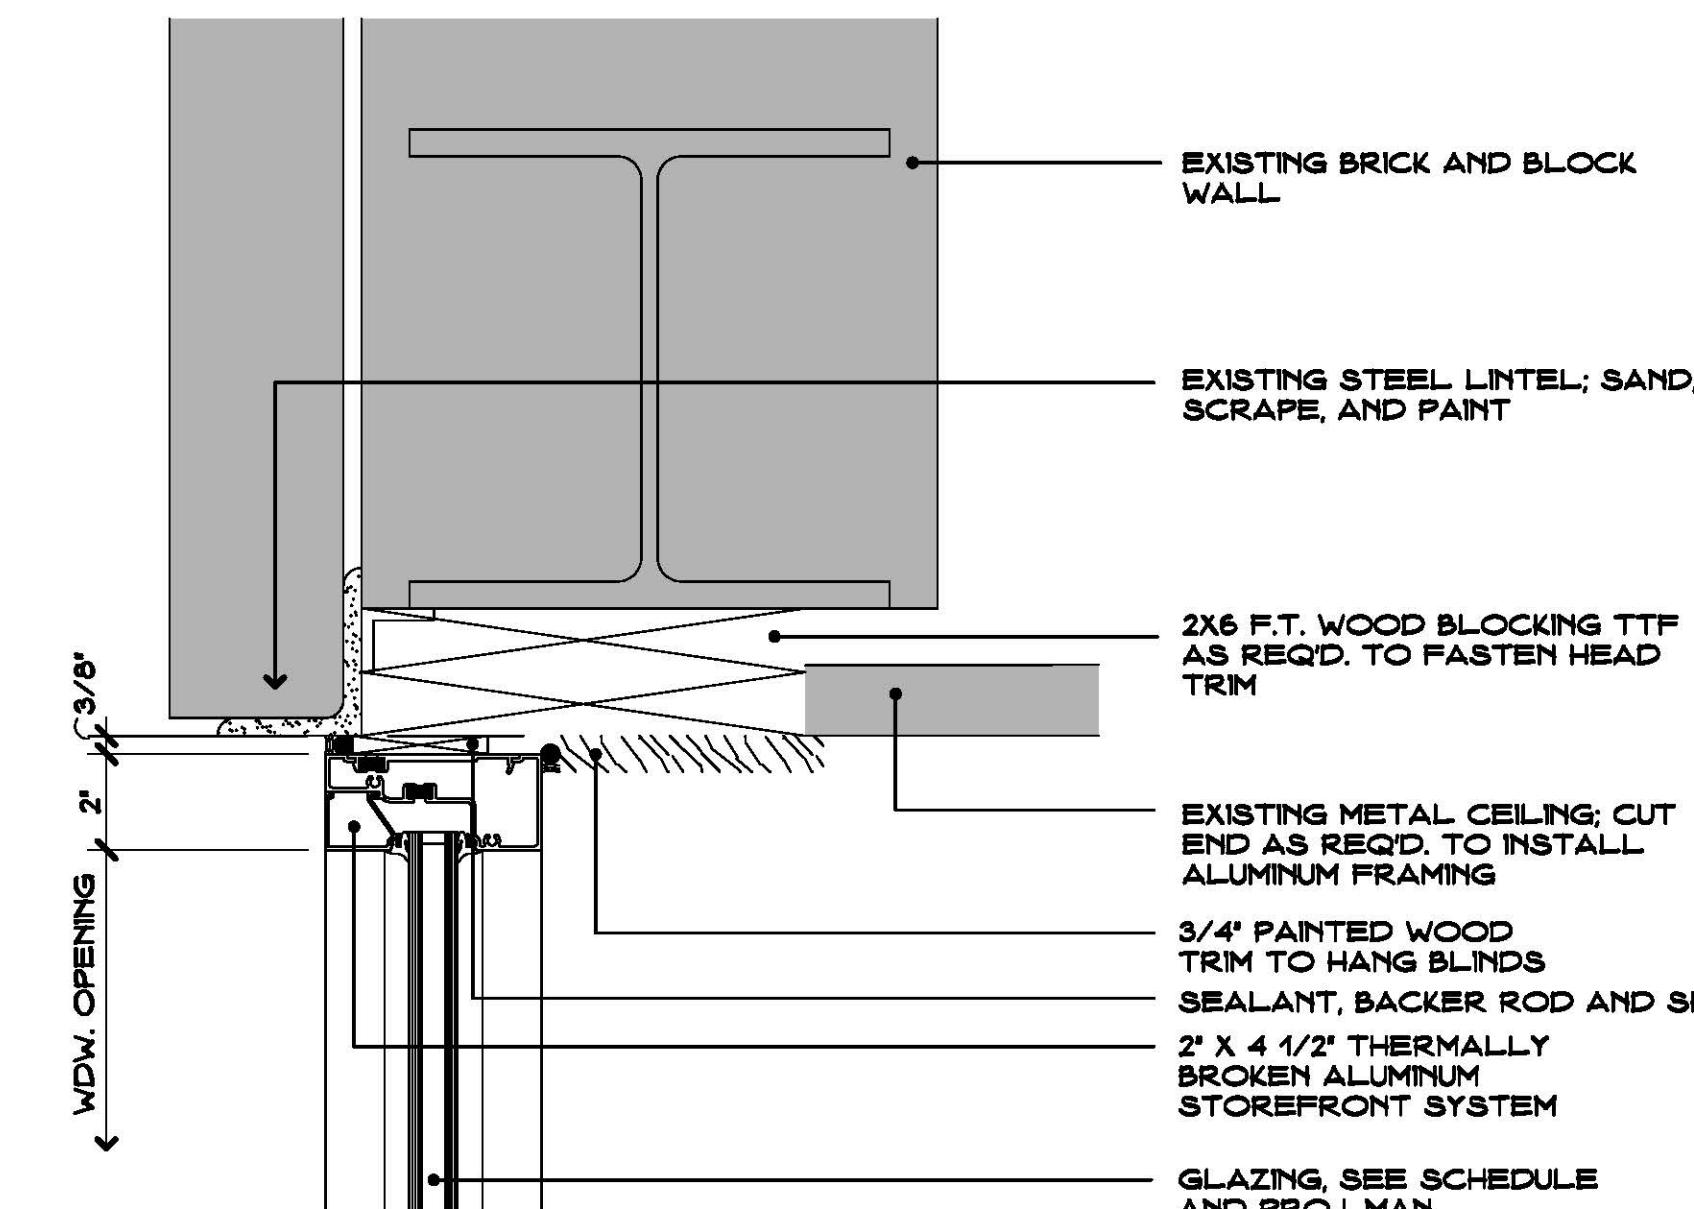

## HEAD DETAIL

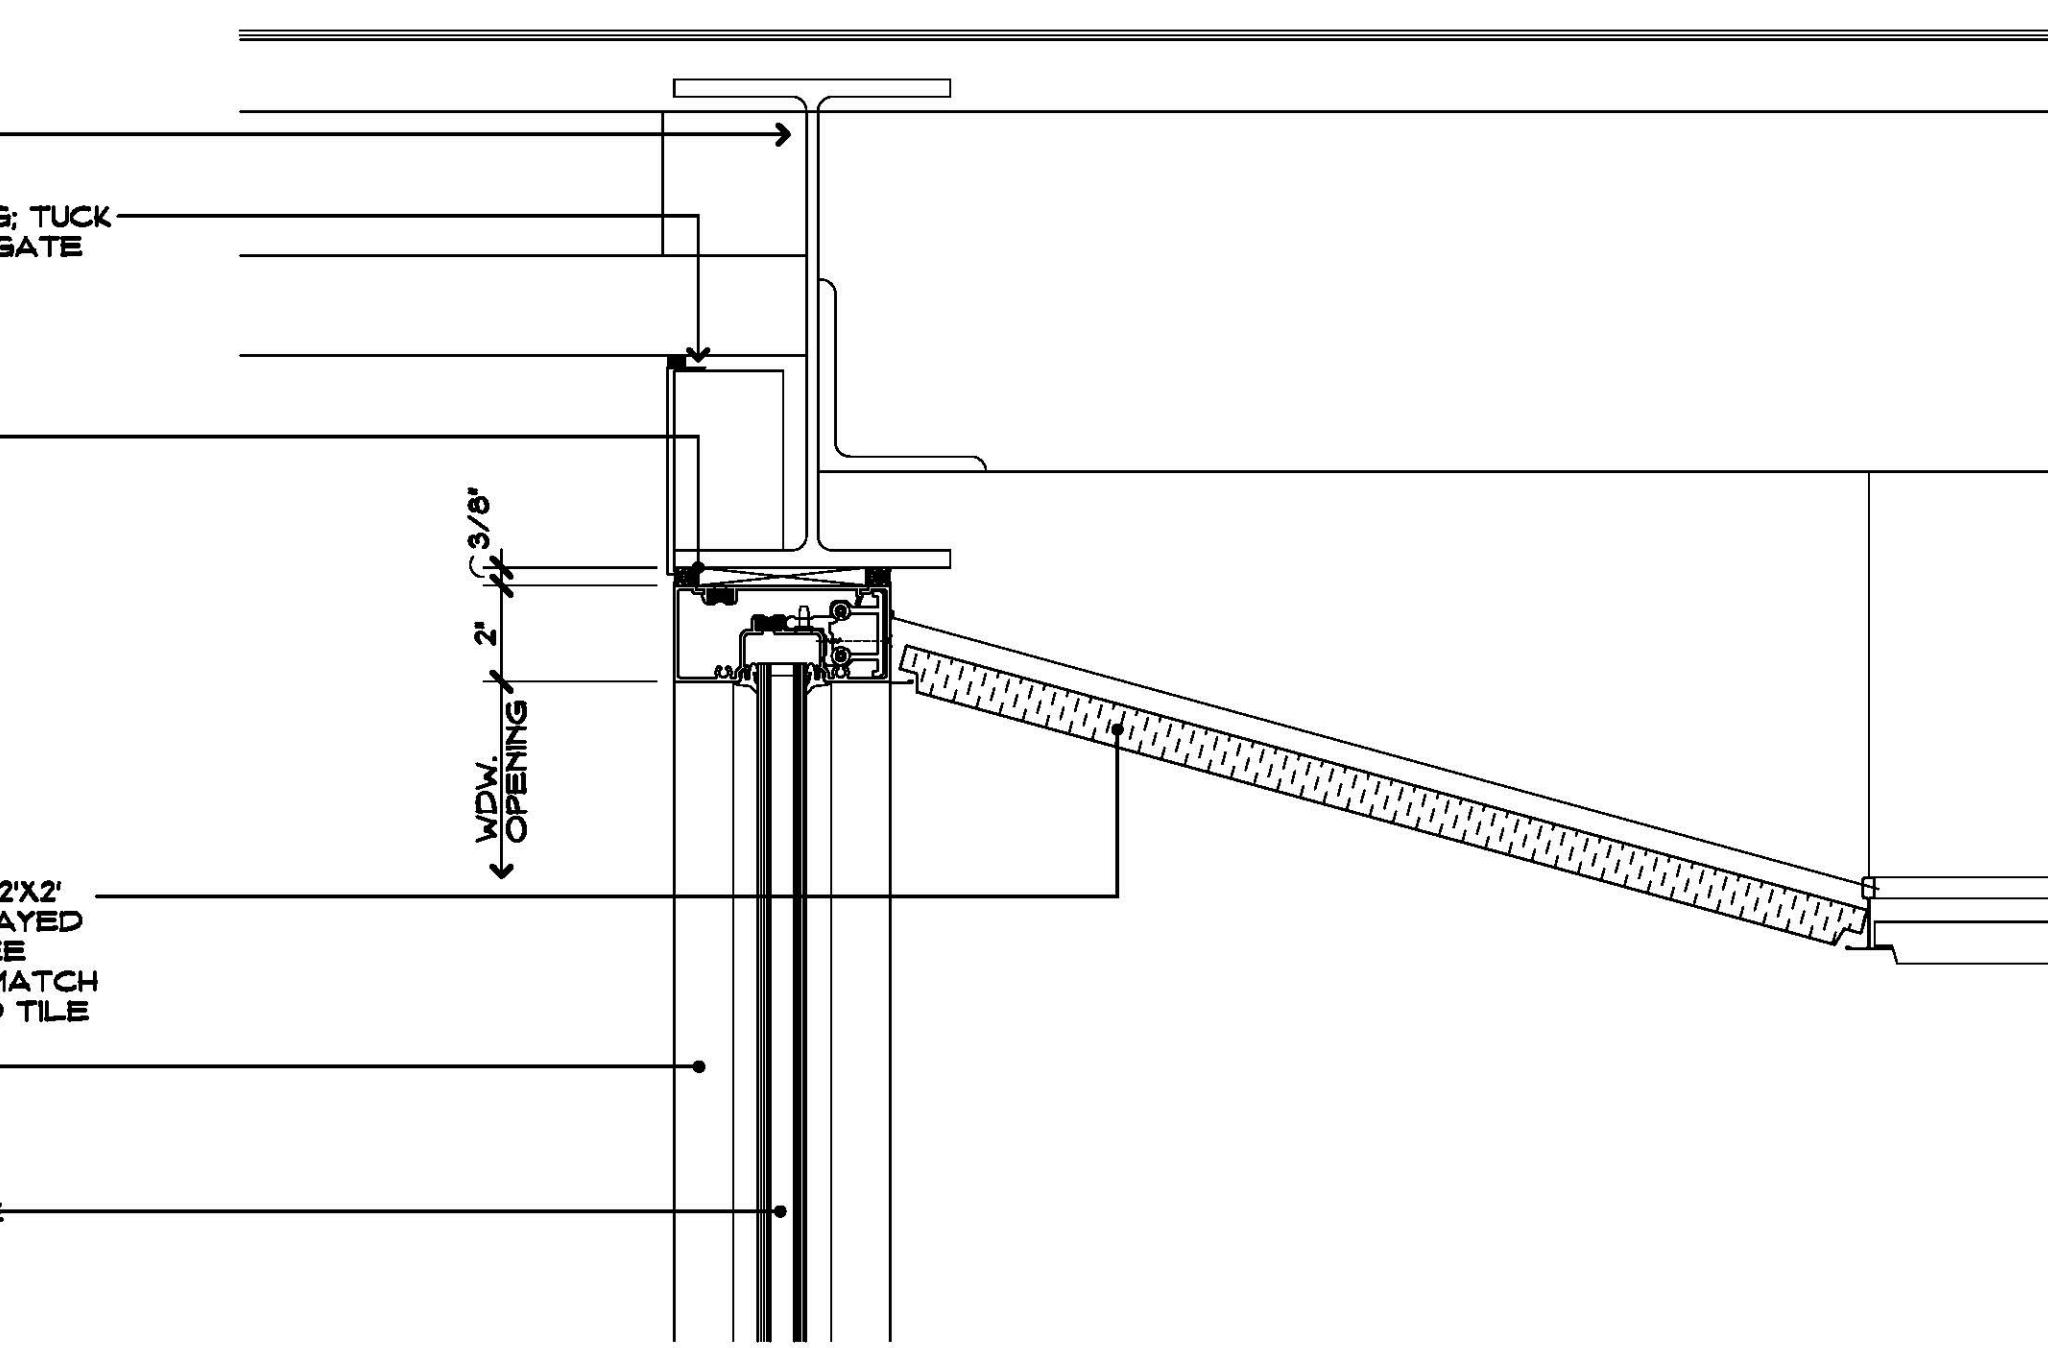

## HEAD DETAIL

## WINDOW DETAILS

---

**SCALE: 3" = 1'-0"**

*de:* **Window Replacer**  
**Jane Ryan Elem.**  
190 Park Lane  
Towanda, Connecticut 06611



# SILVER / PETRUCELLI + ASSOCIATES

*Architects / Engineers / Interior Designers*

3190 Whitney Avenue, Hamden, CT 06518-2105  
Tel. 203 230 9007 Fax. 203 230 8247  
*silverpetrucci.com*

Revision:    Description:    Date:    Revised by:

## Window Details

STATE PROJECT #144-0104 EC/CV


*Date:*  
**MAY, 24TH 2018**

*Scale:*  
**AS NOTED**

*Drawn By:*  
**CON**

*Project Number:*  
**18-031**

A7

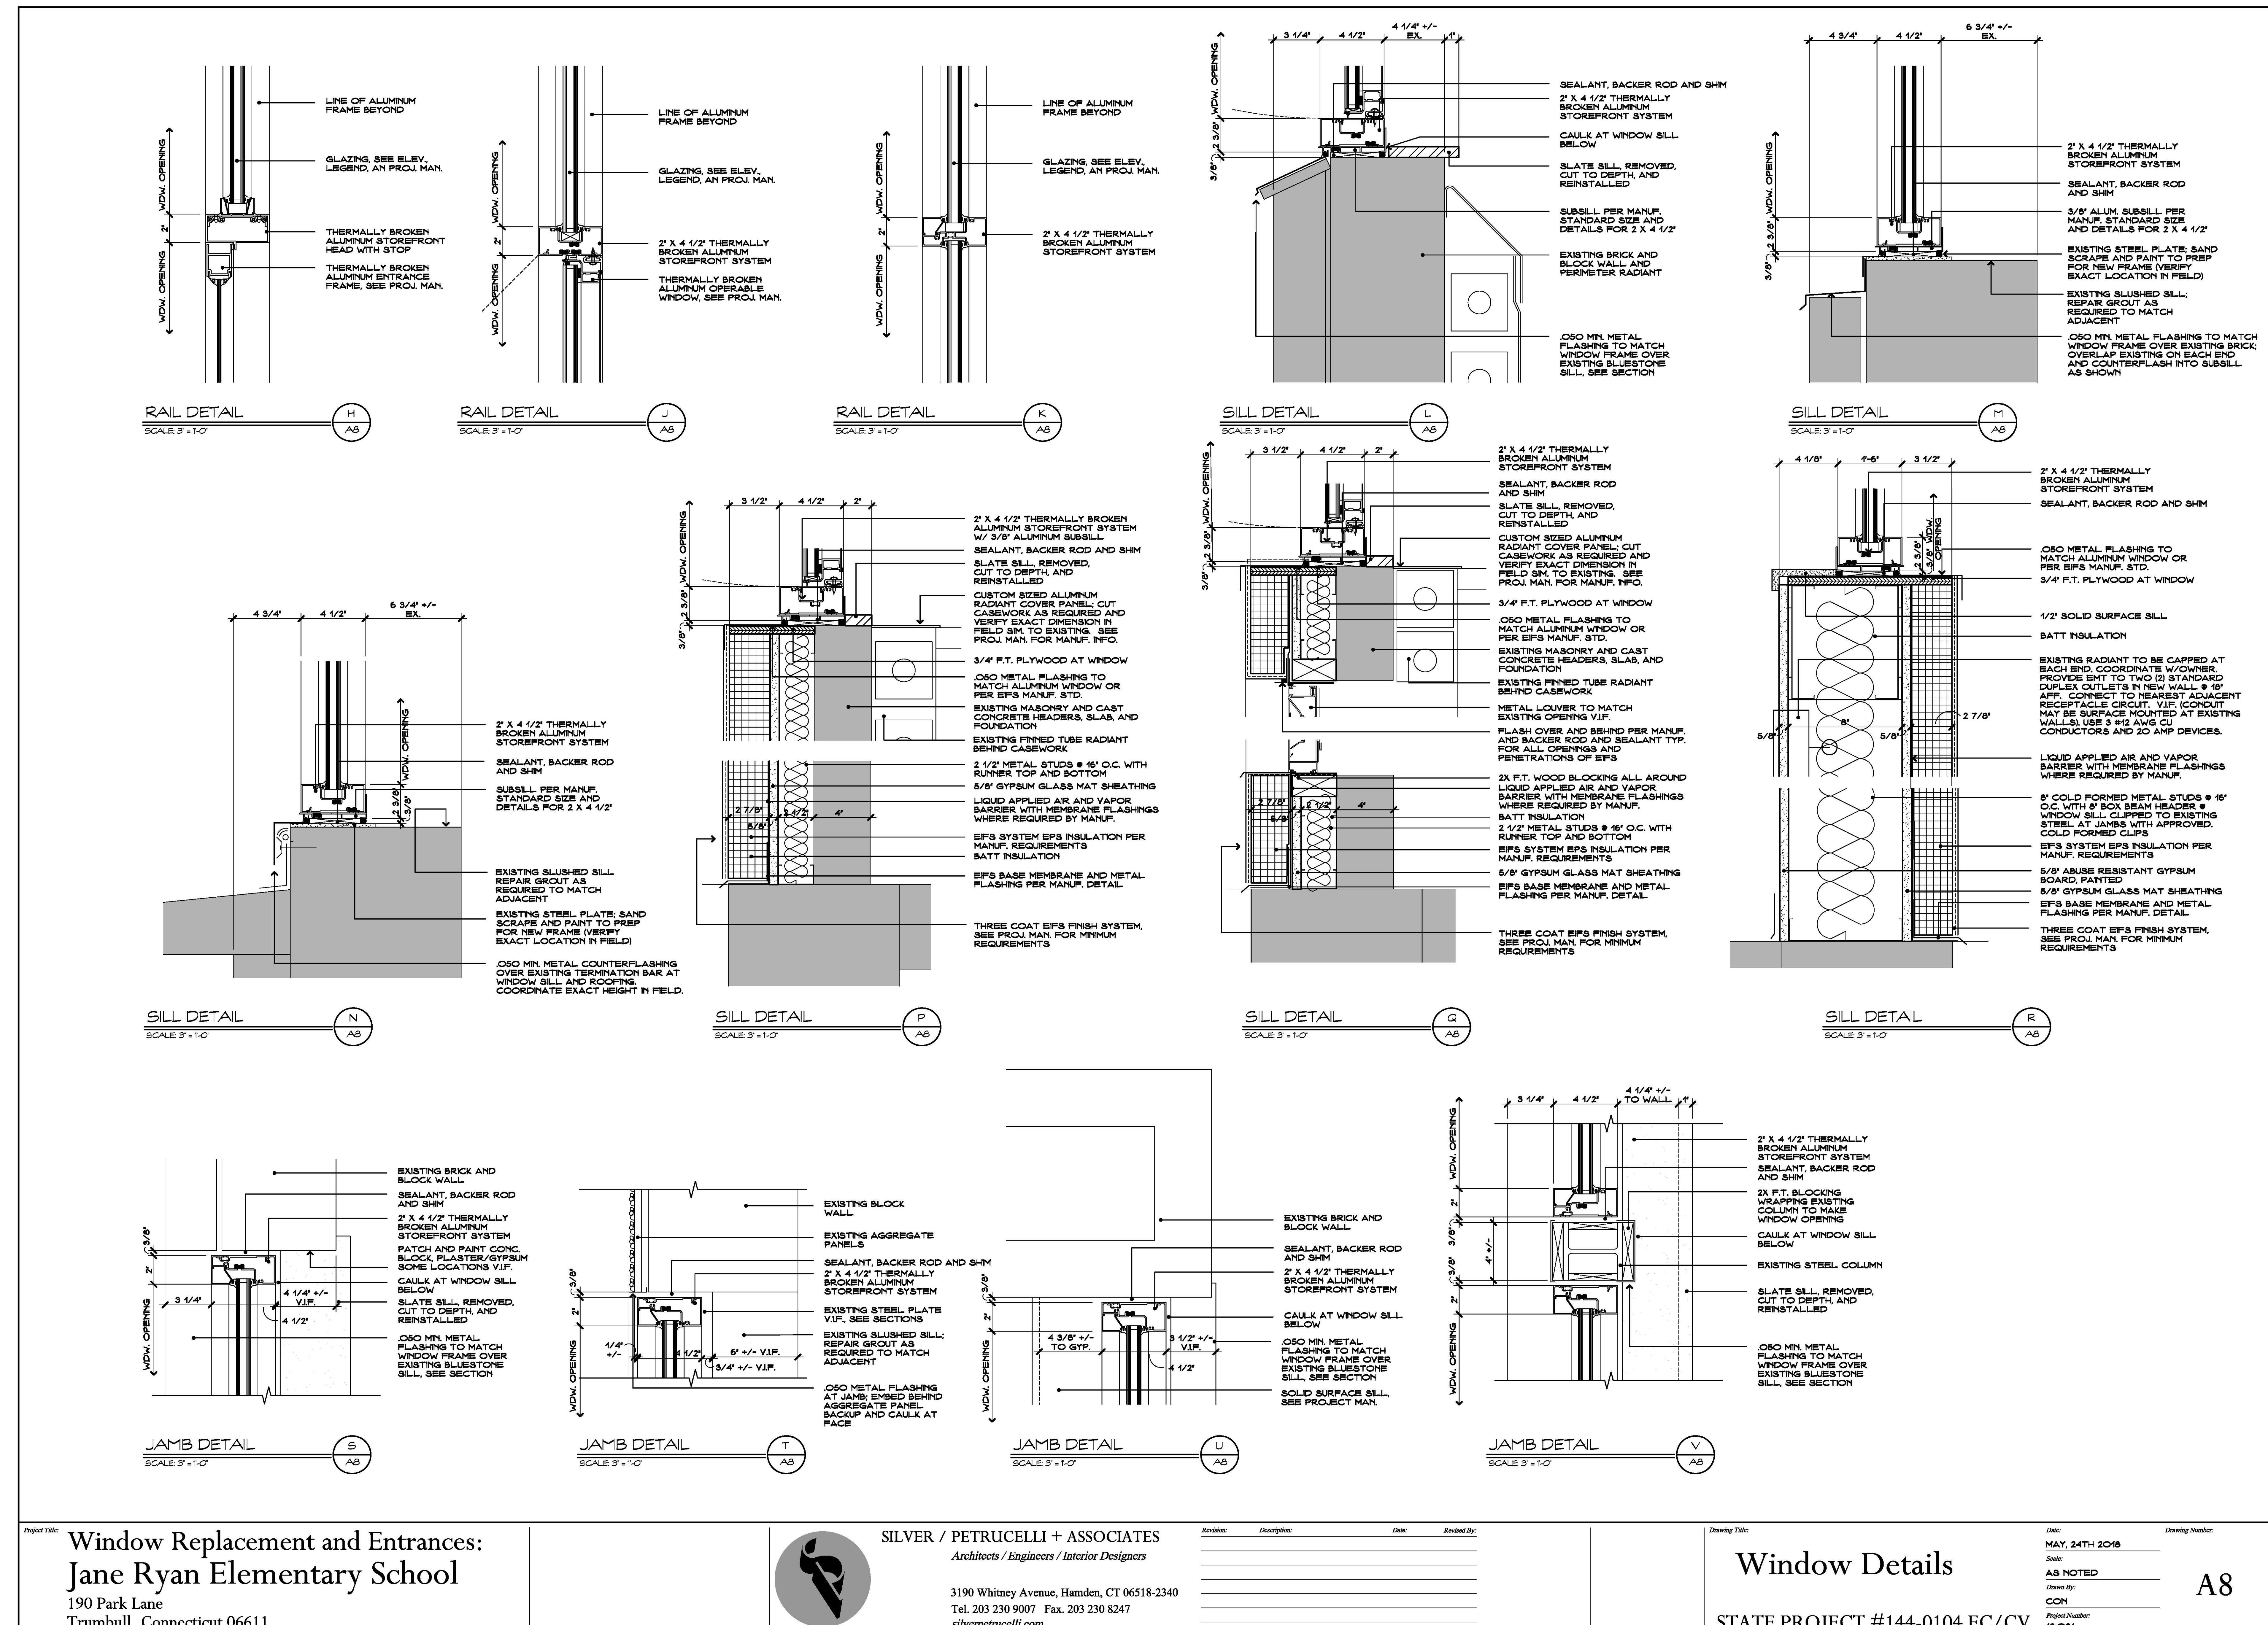

DOOR SCHEDULE																					
DOOR NUMBER	DOOR			FRAME			FIRE			HARDWARE - SEE PROJECT MANUAL			REMARKS								
	DOUBLE LEAF	WIDTH	HEIGHT	TYPE - SEE 2/ACO	MATERIAL	GLAZING (SEE LEGEND)	TYPE	WIDTH	HEIGHT	MATERIAL	HEAD DETAIL	JAMB DETAIL	SADDLE DETAIL	GLAZING	SHOE RESISTANT	RATING	FIRE CODE	DISABLED REQ.	IDENTIFICATION	(SEE TYPES FOR TYP. MOUNT. DETAIL)	
101	3'-0"	6'-8"	1	HM	EX	EX	HM	EX	EX	A					1 HR	1-1/2 HR	2 HP	PANIC DEVICE	DELAYED ACTION CLOSER	13	
102	3'-0"	6'-8"	1	HM	EX	EX	HM	EX	EX	A							PUSH/PULL/LOCKABLE	LEVER HANDLES/LOCK		16	
103	3'-0"	6'-8"	1	HM	EX	EX	HM	EX	EX	A							KICK PLATES	TACTILE WARNING		19	
104	3'-0"	6'-8"	2	HM	GL-13	EX	EX	HM	EX	EX	A						ACCESSIBLE THRESHOLD			21	EXTERIOR LEVER THIS DOOR
105	3'-4"	6'-8"	1	HM	EX	EX	HM	EX	EX	A							EXTERIOR LEVER THIS DOOR			22	
106	• 2'-6"	6'-8"	3	HM	GL-13	EX	EX	HM	EX	A										23	
107	3'-0"	6'-8"	3	HM	GL-13	EX	EX	HM	EX	A										EXTERIOR LEVER THIS DOOR, NOTE 5	
108	3'-0"	7'-0"	4	AL	GL-17	SEE	WDW, ELEV.	AL	SEE	ELEV.	A	•								1	EXTERIOR LEVER THIS DOOR, NOTE 5
109	3'-0"	7'-0"	4	AL	GL-17	SEE	WDW, ELEV.	AL	SEE	ELEV.	A	•								2	EXTERIOR LEVER THIS DOOR, NOTE 5
110	3'-0"	7'-0"	1	HM	EX	EX	HM	EX	EX	A										3	EXTERIOR LEVER THIS DOOR, NOTE 5, 6
111	• 3'-0"	7'-0"	4	AL	GL-13	SEE	WDW, ELEV.	AL	SEE	ELEV.	A	•								4	EXTERIOR LEVER THIS DOOR, NOTE 5
112	3'-0"	6'-8"	1	HM	EX	EX	HM	EX	EX	A										5	
113	3'-0"	6'-8"	1	HM	EX	EX	HM	EX	EX	A										6	
114	3'-0"	6'-8"	1	HM	EX	EX	HM	EX	EX	A										7	
115	3'-0"	6'-8"	1	HM	EX	EX	HM	EX	EX	A										8	EXTERIOR LEVER THIS DOOR, NOTE 5
116	• 3'-0"	7'-0"	4	AL	GL-13	SEE	WDW, ELEV.	AL	SEE	ELEV.	A	•								9	
117	3'-0"	6'-8"	1	HM	EX	EX	HM	EX	EX	A										10	
118	3'-0"	6'-8"	1	HM	EX	EX	HM	EX	EX	A										11	
119	3'-0"	6'-8"	1	HM	EX	EX	HM	EX	EX	A										12	
120	3'-0"	7'-0"	4	AL	GL-13	SEE	WDW, ELEV.	AL	SEE	ELEV.	A	•								13	EXTERIOR LEVER THIS DOOR
121	• 3'-0"	7'-0"	4	AL	GL-13	SEE	WDW, ELEV.	AL	SEE	ELEV.	A	•								24	
122	• 3'-0"	6'-8"	3	HM	GL-13	EX	EX	HM	EX	EX	A									25	
123	3'-0"	6'-8"	3	AL	GL-13	SEE	WDW, ELEV.	AL	SEE	ELEV.	A	•								26	
124	3'-0"	6'-8"	3	AL	GL-13	SEE	WDW, ELEV.	AL	SEE	ELEV.	A	•								27	
125	3'-0"	6'-8"	3	AL	GL-13	SEE	WDW, ELEV.	AL	SEE	ELEV.	A	•								28	
126	3'-0"	6'-8"	3	AL	GL-13	SEE	WDW, ELEV.	AL	SEE	ELEV.	A	•								29	
127	3'-0"	6'-8"	3	AL	GL-13	SEE	WDW, ELEV.	AL	SEE	ELEV.	A	•								30	
128	3'-0"	6'-8"	3	AL	GL-13	SEE	WDW, ELEV.	AL	SEE	ELEV.	A	•								31	
129	• 3'-0"	6'-8"	3	HM	GL-13	EX	EX	HM	EX	EX	A									25	

**LEGEND**
**NOTES**

EX EXISTING  
HM HOLLOW METAL  
AL ALUMINUM


1. NEW DOOR IN EXISTING FRAME. SAND FILL WITH BONDING MATERIAL.
2. ALL DOORS TO RECEIVE AN EXTERIOR DOOR NUMBERING DECAL ON THE EXTERIOR TO MATCH EXISTING.
3. CLASSROOM DOORS EXITING DIRECTLY TO THE EXTERIOR SHALL HAVE NO HARDWARE ON EXTERIOR U.O.N. ON SCHEDULE.
4. INSTALL NEW THRESHOLDS ON EXISTING FRAMES TO REMAIN.
5. EXISTING APHONE SYSTEM TO BE RECONNECTED TO NEW ENTRANCE DOOR AND PAINT EXISTING FRAMES. VERIFY DOOR WIDTHS IN FIELD DIMENSIONS SHOWN ARE APPROXIMATE.
6. APHONE TO BE ADDED FOR ACCESSIBLE ENTRANCE, TO MATCH EXISTING SYSTEM.
7. PATCH, PREP & PAINT INTERIOR WALL FINISHES 24" FROM PERIMETER.
8. RELOCATE EXISTING EXTERIOR DOOR SIGN TO WALL.

**GLAZING LEGEND**


SEE PLANS, ELEVATIONS, SCHEDULES AND PROJECT MANUAL FOR ADDITIONAL INFORMATION

GL-12 INSULATED, TINTED	GL-17 INSULATED, TINTED, LAMINATED
GL-13 INSULATED, TINTED, TEMPERED	GL-21 INSULATED, TINTED, SPANDREL, LAMINATED
GL-15 INSULATED, TINTED, FROSTED	GENERAL NOTES

1. ALL GLAZING TO BE INSULATED.

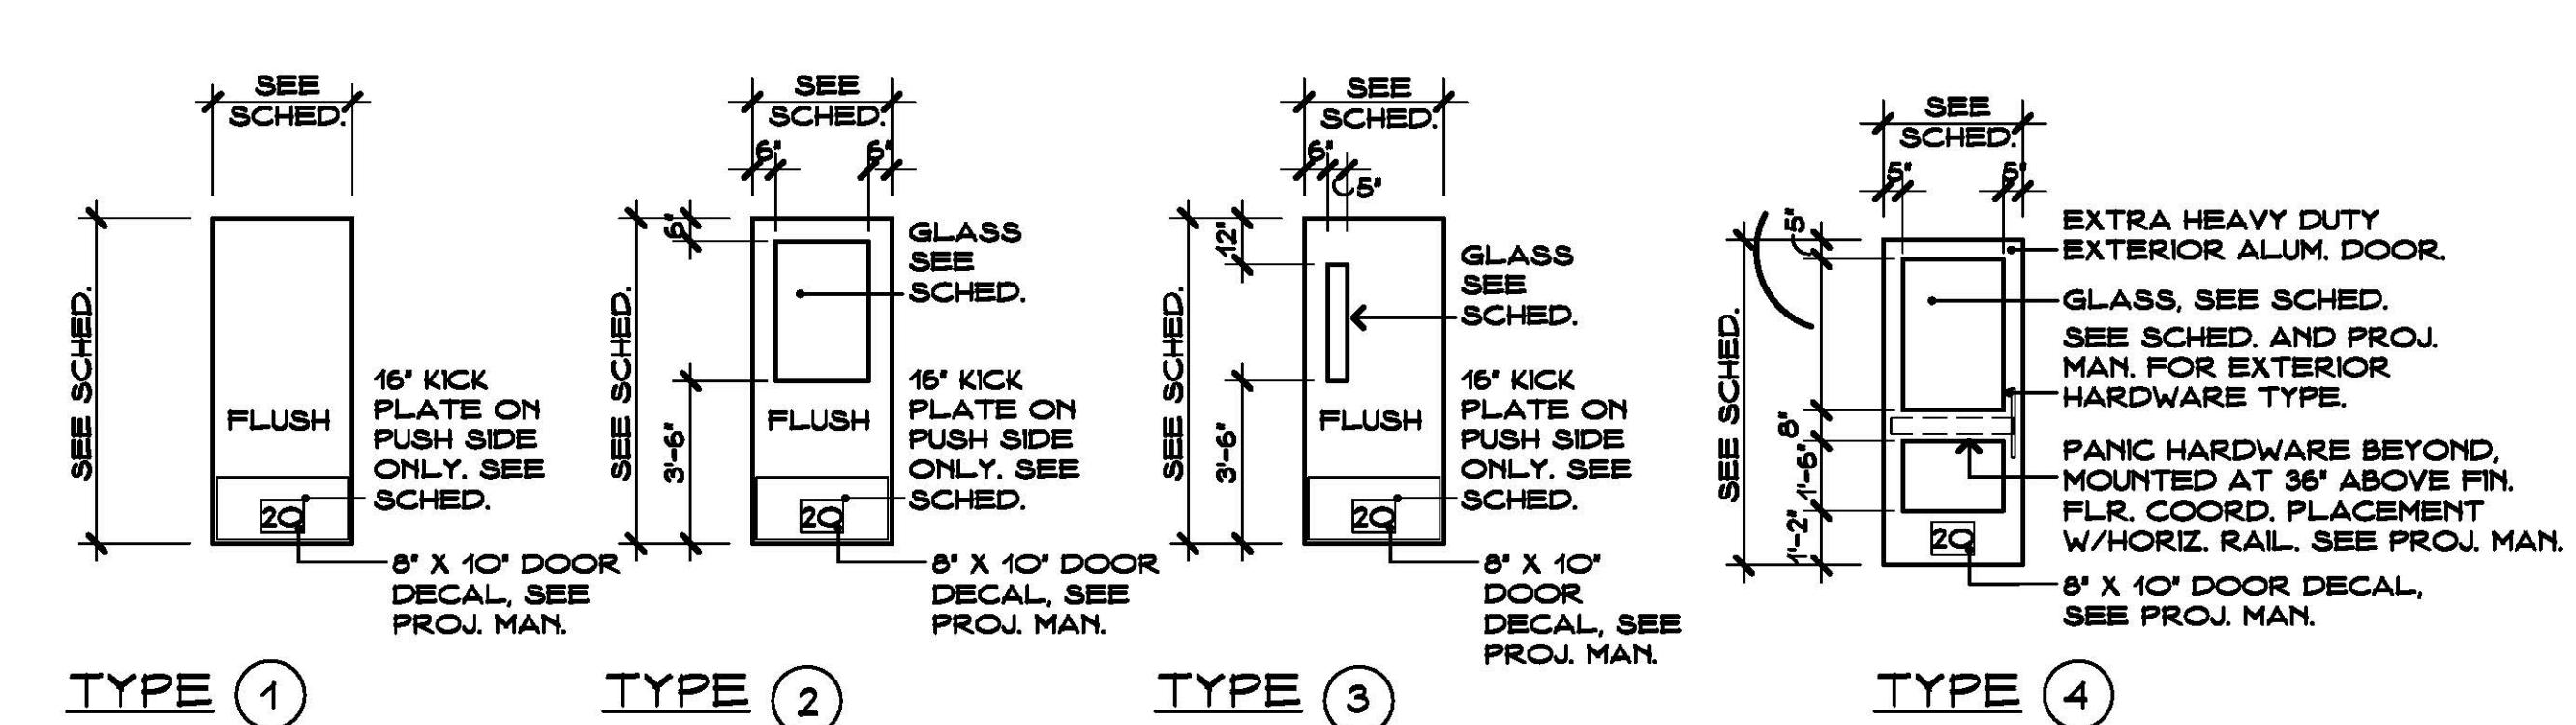
**DOOR ELEVATIONS**

SCALE: 1/2" = 1'-0"

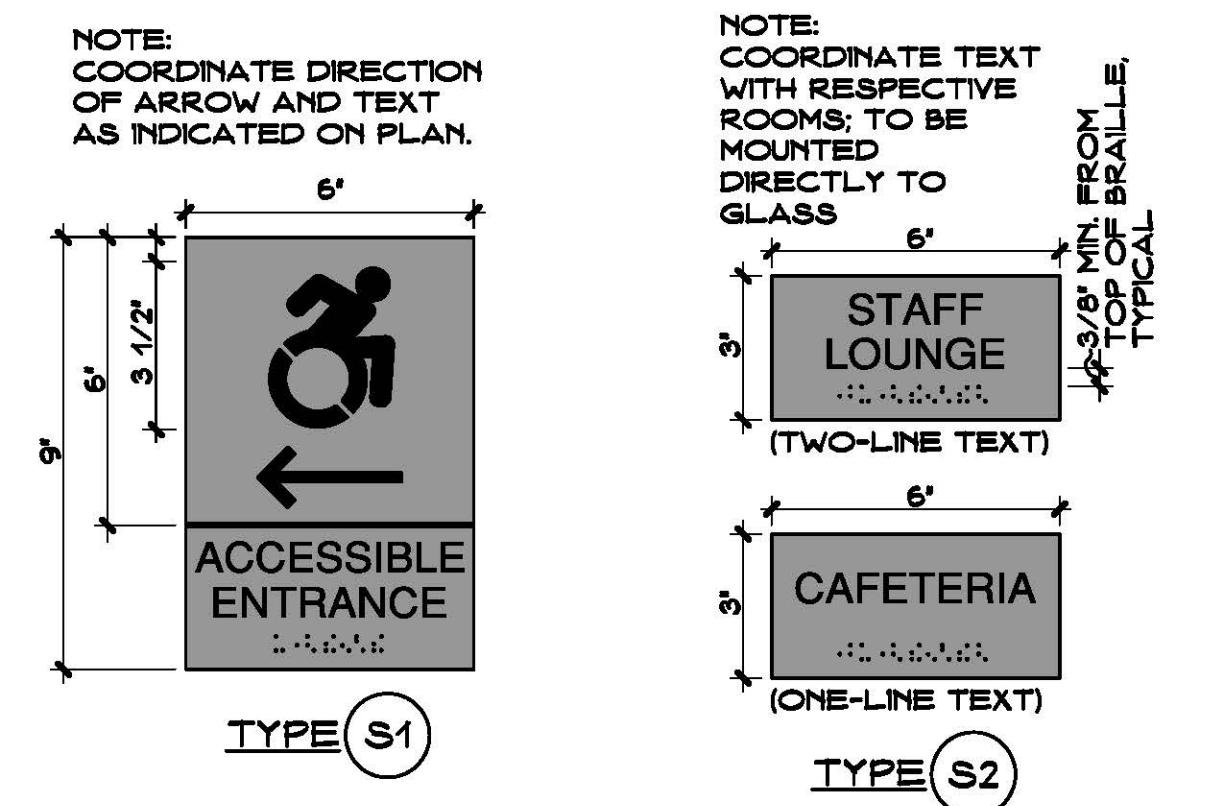
**SIGN DETAIL**

SCALE: 3' = 1'-0"



SCALE: 3' = 1'-0"

NOTE: COORDINATE DIRECTION OF ARROW AND TEXT AS INDICATED ON PLAN.

NOTE: COORDINATE DIRECTION OF ARROW AND TEXT AS INDICATED ON PLAN.

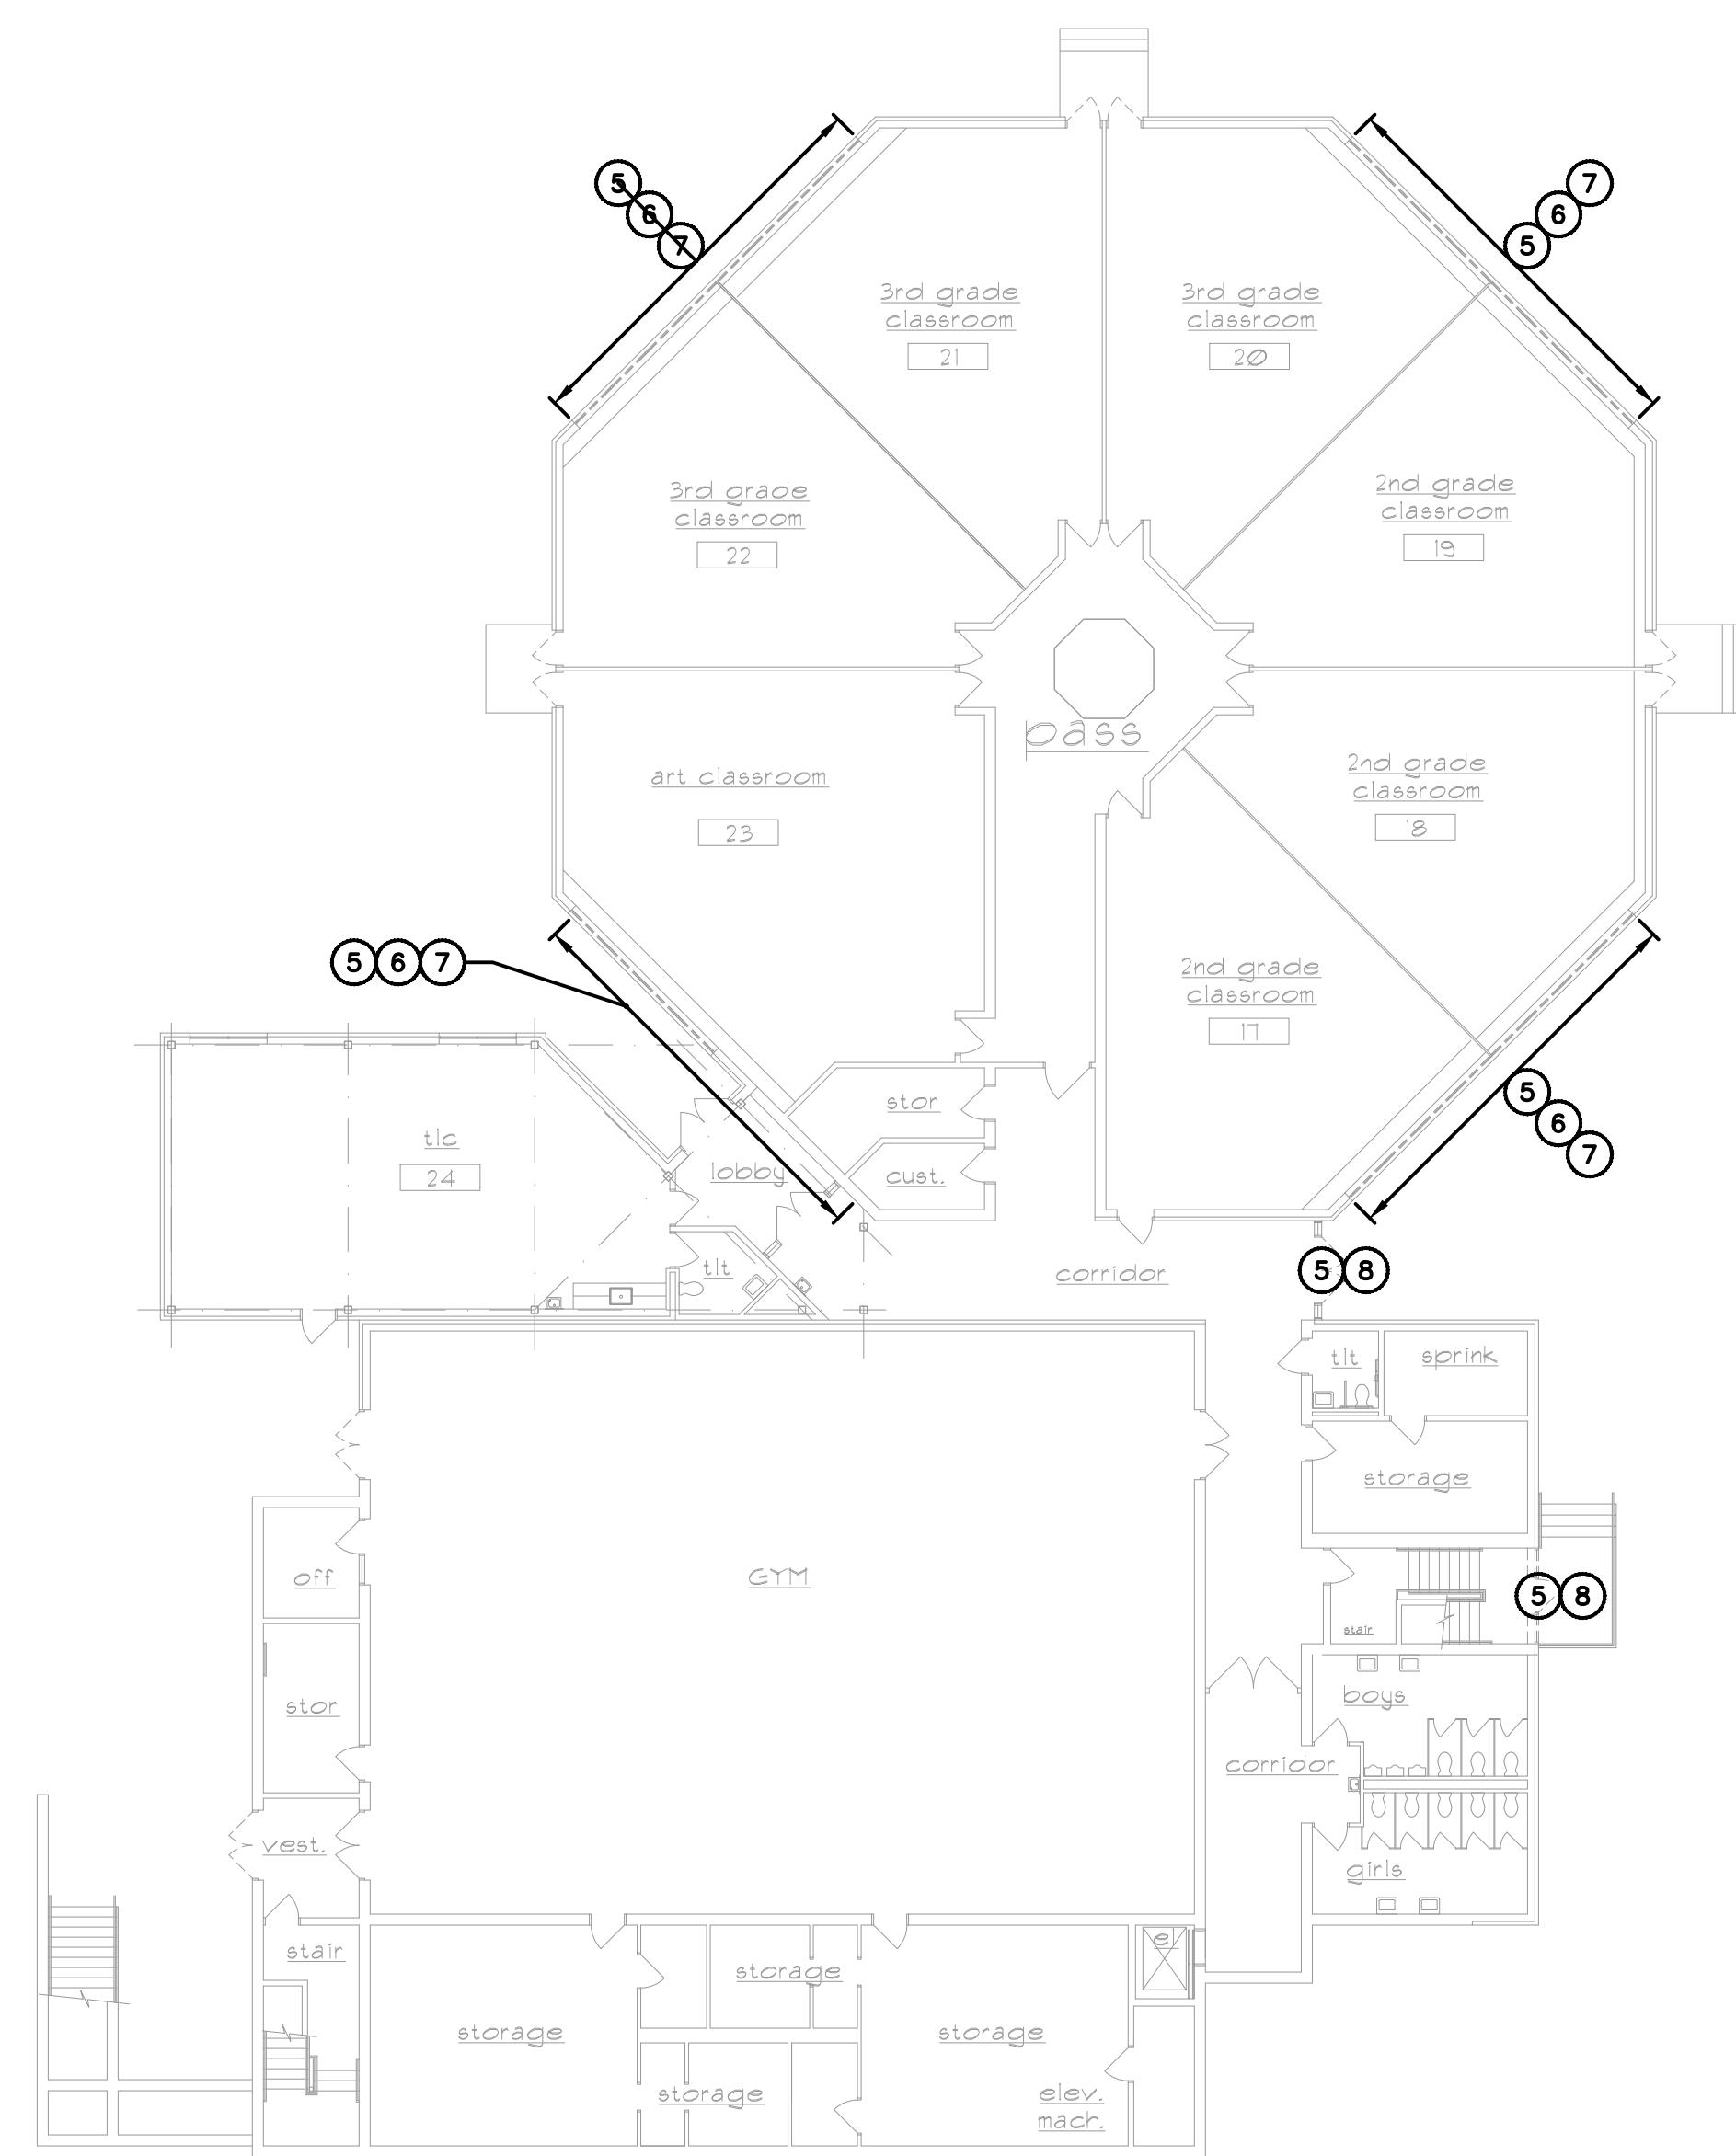


lower level abatement plan  
SCALE: 1/16" = 1'-0"  
NORTH

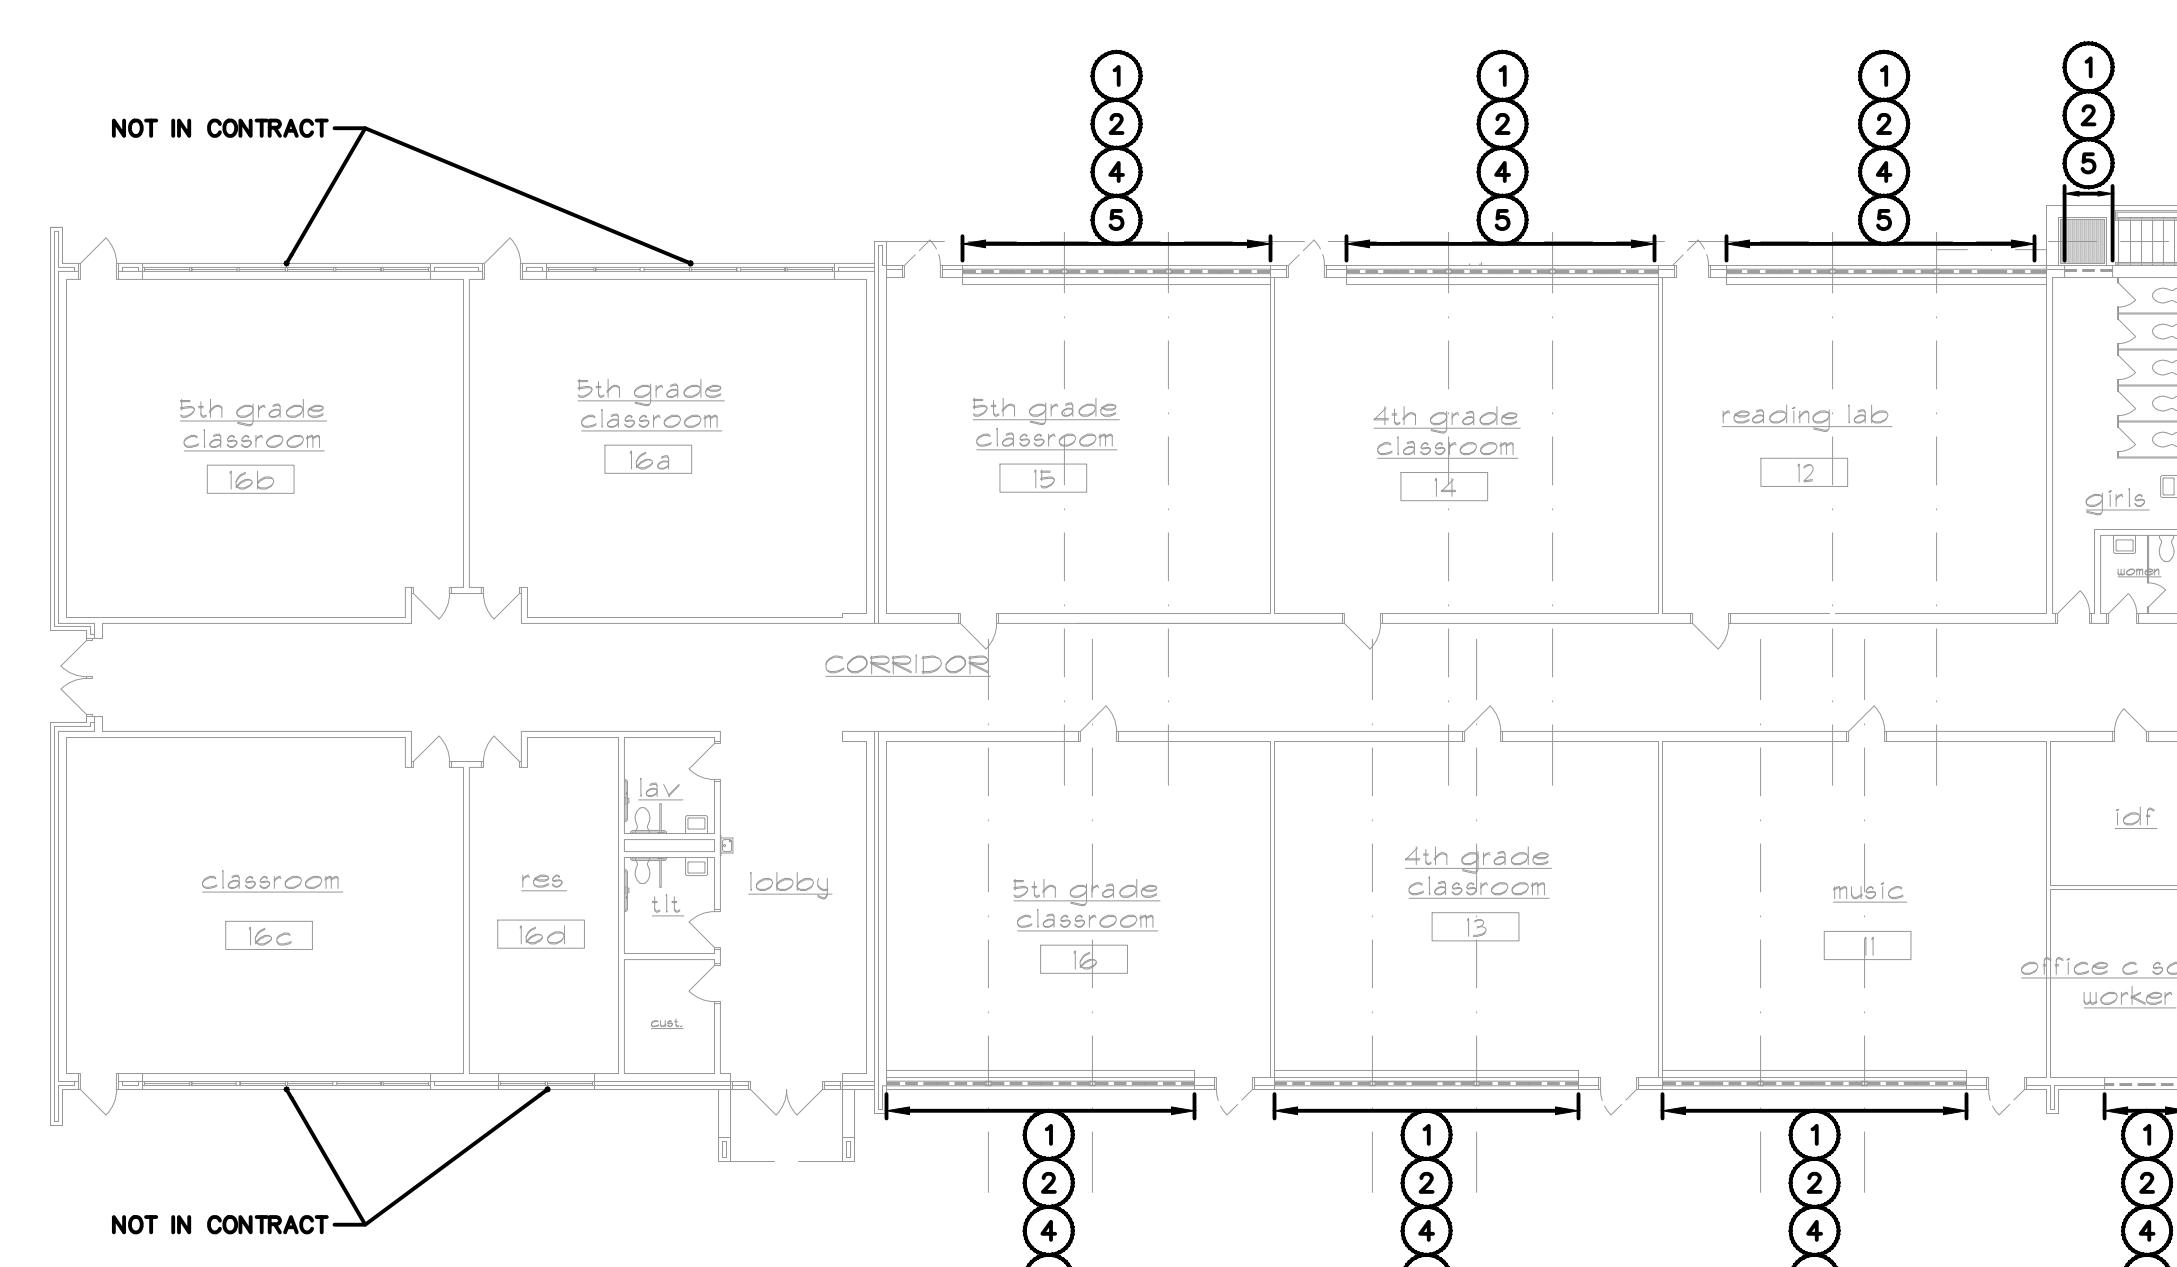


main level abatement plan  
SCALE: 1/16" = 1'-0"  
NORTH

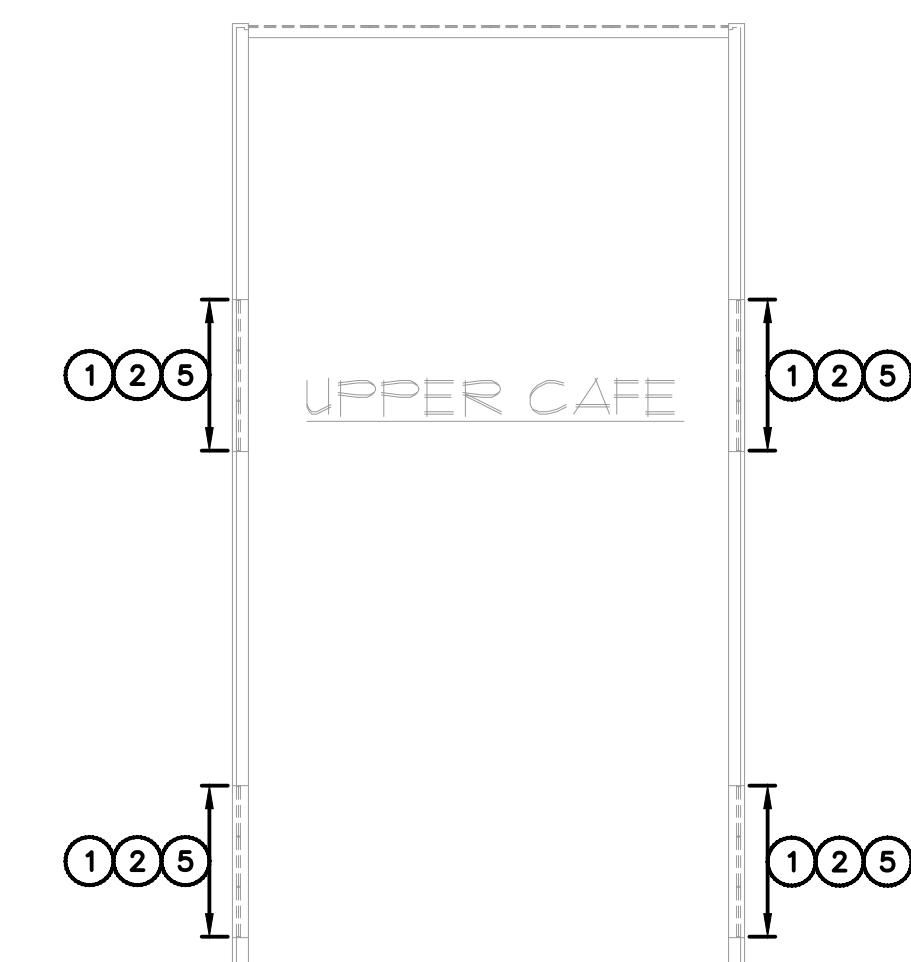

partial abatement plan  
SCALE: 1/16" = 1'-0"  
NORTH

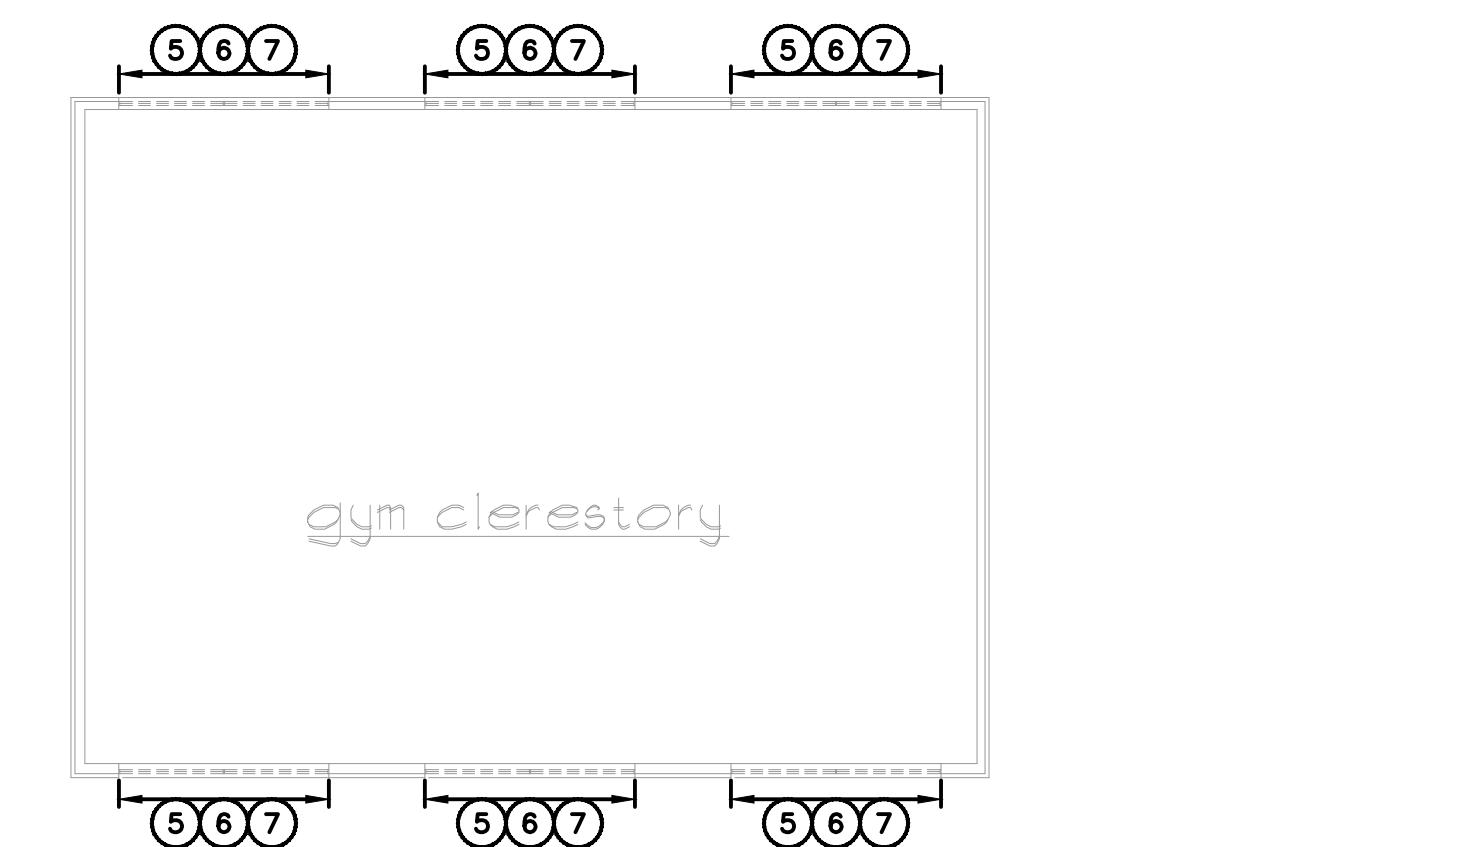

partial abatement plan  
SCALE: 1/16" = 1'-0"  
NORTH

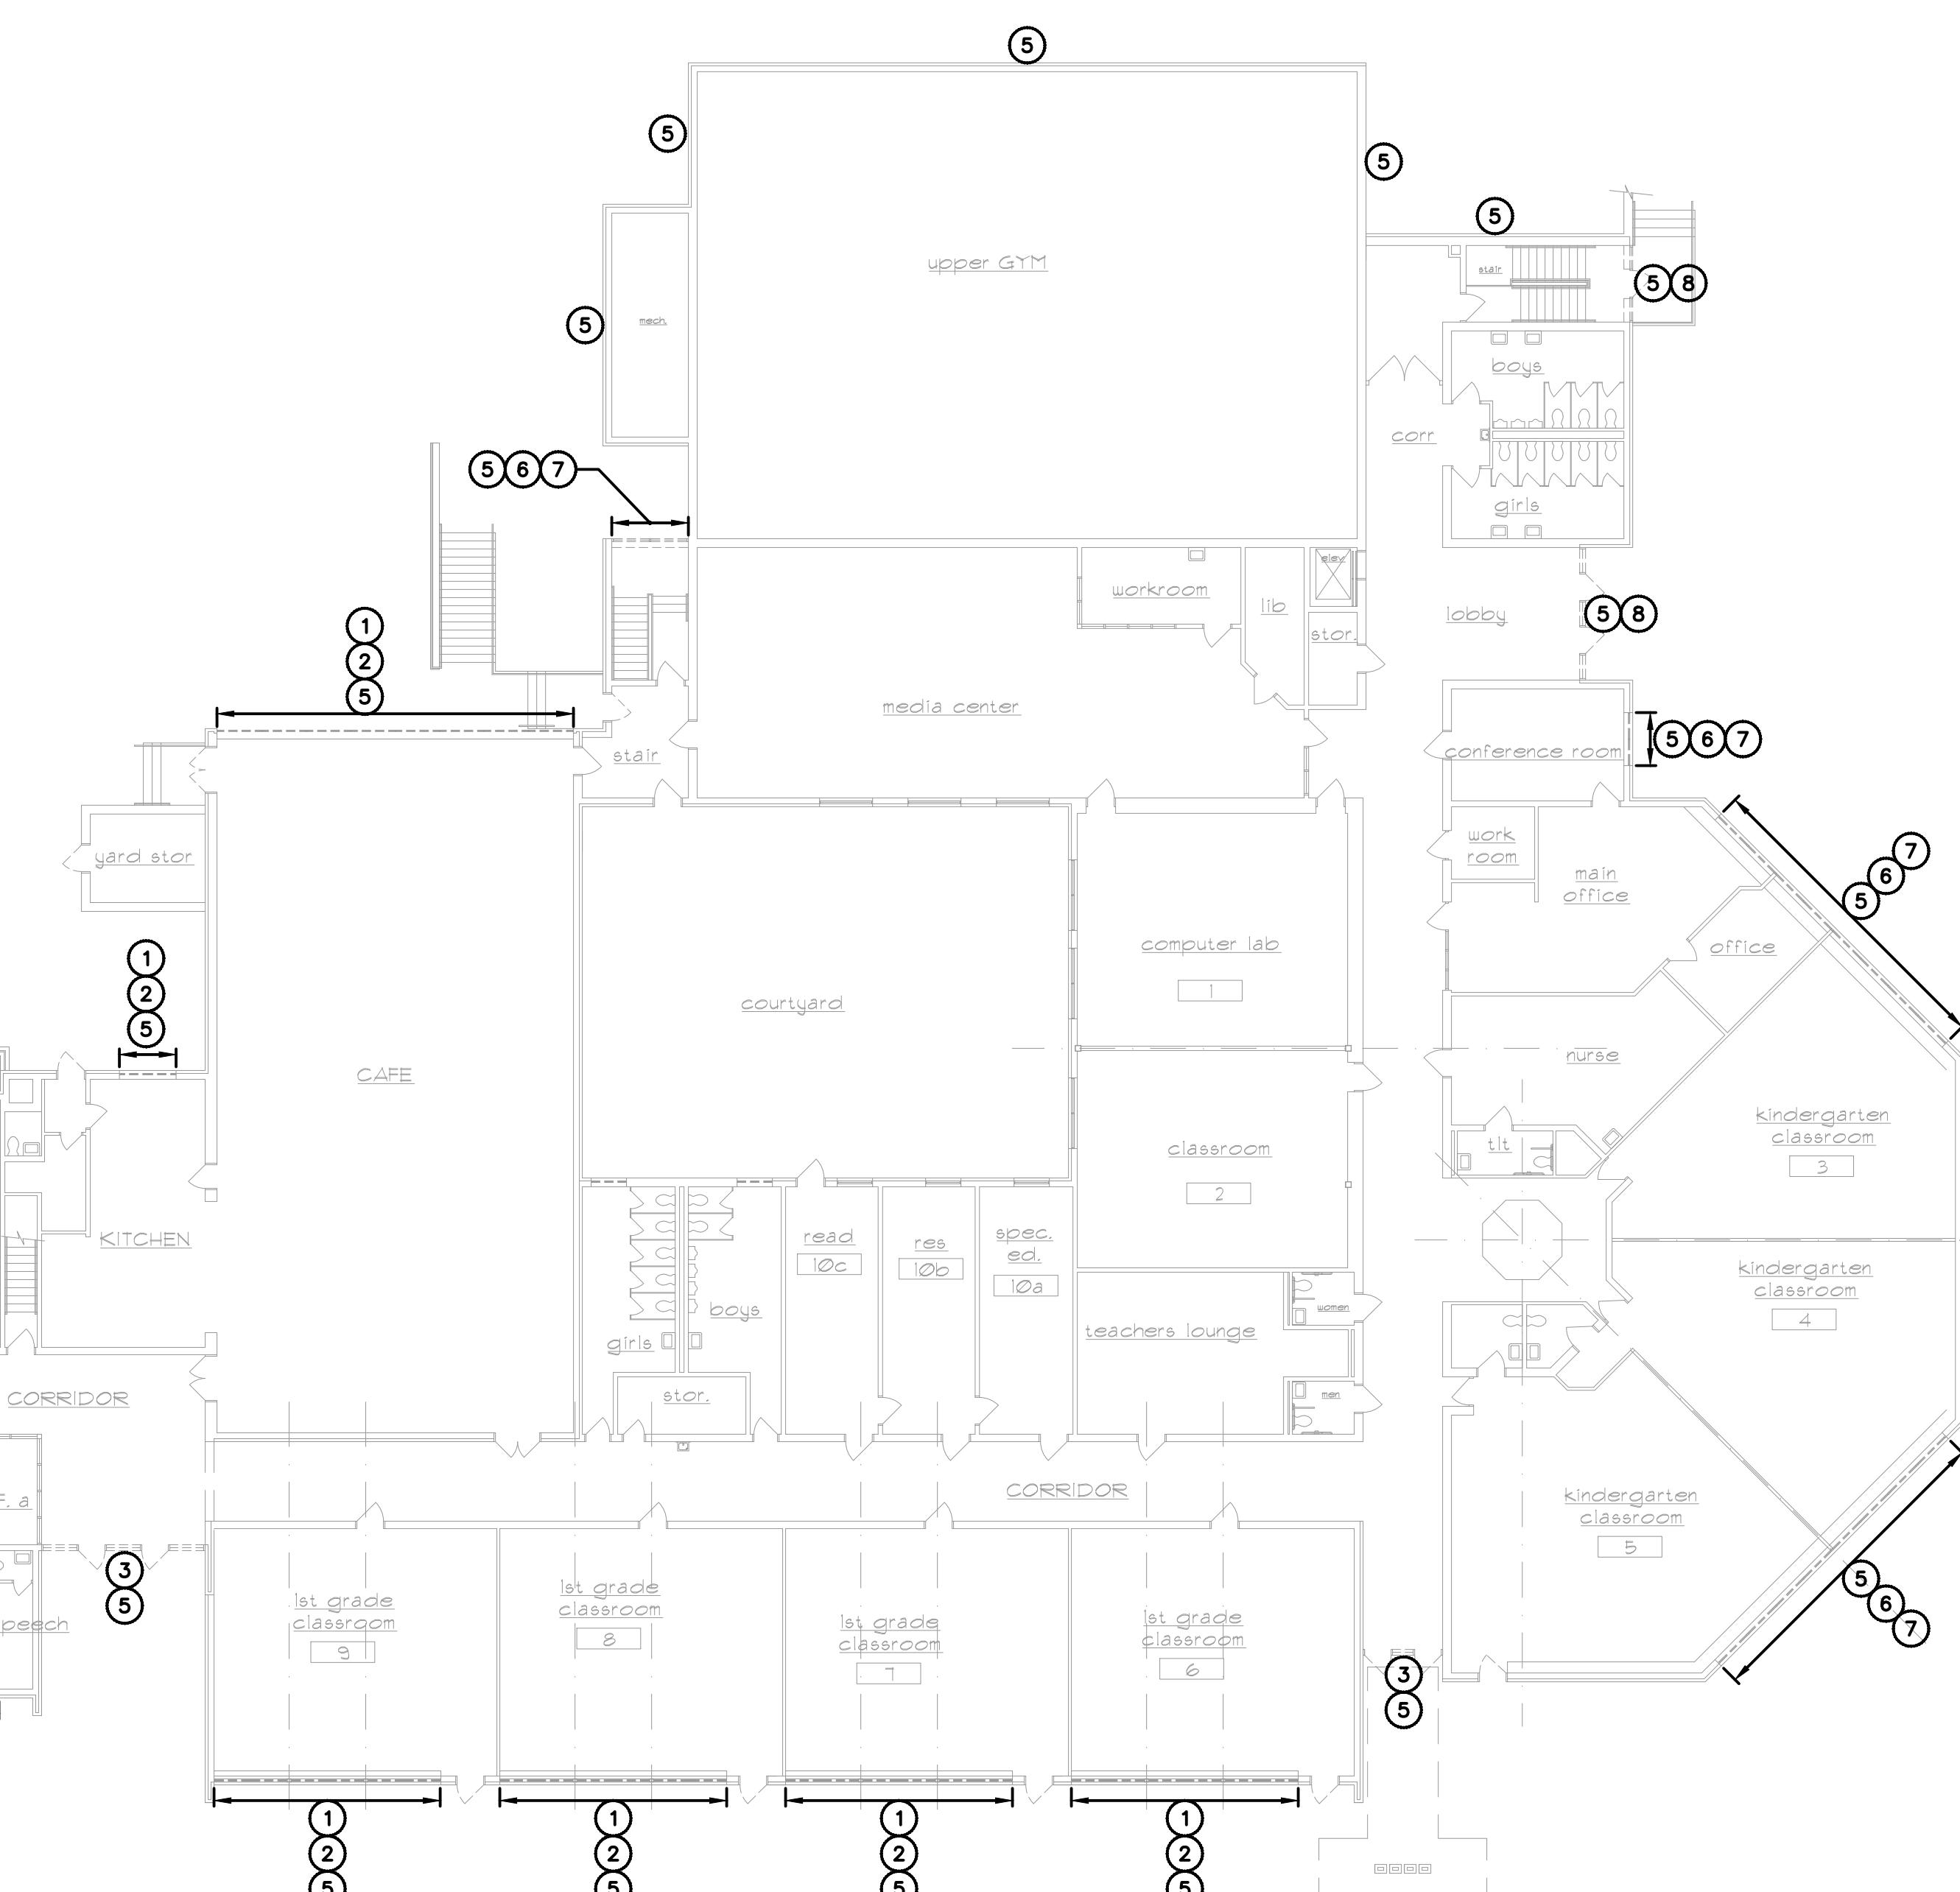

#### ASBESTOS AND PRESUMED PCB BULK PRODUCT ABATEMENT NOTES

- ① THE HAZARDOUS MATERIALS ABATEMENT CONTRACTOR SHALL REMOVE AND DISPOSE OF WINDOW CAULKING COMPOUND AS ACM AND PRESUMED PCB BULK PRODUCT MIXED WASTE.
- ② THE HAZARDOUS MATERIALS ABATEMENT CONTRACTOR SHALL REMOVE AND DISPOSE OF WINDOW GLAZING COMPOUND AS PRESUMED PCB BULK PRODUCT WASTE.
- ③ THE HAZARDOUS MATERIALS ABATEMENT CONTRACTOR SHALL REMOVE AND DISPOSE OF WINDOW/DOOR SYSTEM CAULKING COMPOUND AS ACM AND PRESUMED PCB BULK PRODUCT MIXED WASTE.
- ④ THE HAZARDOUS MATERIALS ABATEMENT CONTRACTOR SHALL REMOVE AND DISPOSE OF CEMENT BOARD (TRANSITE) SOFFIT AS ACM.
- ⑤ THE HAZARDOUS MATERIALS ABATEMENT CONTRACTOR SHALL REMOVE AND DISPOSE OF DAMP PROOFING BEHIND BRICK AS ACM.
- ⑥ THE HAZARDOUS MATERIALS ABATEMENT CONTRACTOR SHALL REMOVE AND DISPOSE OF WINDOW CAULKING COMPOUND AS PRESUMED PCB BULK PRODUCT WASTE.
- ⑦ THE HAZARDOUS MATERIALS ABATEMENT CONTRACTOR SHALL REMOVE AND DISPOSE OF WINDOW GLAZING COMPOUND AS CONTAINING TRACE AMOUNTS OF ASBESTOS AND PRESUMED PCB BULK PRODUCT MIXED WASTE.
- ⑧ THE HAZARDOUS MATERIALS ABATEMENT CONTRACTOR SHALL REMOVE AND DISPOSE OF WINDOW/DOOR SYSTEM CAULKING COMPOUND AS PRESUMED PCB BULK PRODUCT WASTE.

#### GENERAL NOTES

1. THE HAZARDOUS MATERIALS ABATEMENT CONTRACTOR SHALL BE RESPONSIBLE FOR THE VERIFICATION OF ALL EXISTING CONDITION AND QUANTITIES, AND FOR NOTIFYING THE CONSULTANT OF ANY DISCREPANCIES PRIOR TO FINALIZING BID.
2. RENOVATION AREAS REPLICATED ON THIS DRAWING ARE TO BETTER AID IN THE IDENTIFICATION OF AREAS REQUIRING ABATEMENT. THE CONTRACTOR SHALL REFER TO ARCHITECTURAL DRAWINGS FOR RENOVATION INFORMATION.
3. THE CONTRACTOR IS RESPONSIBLE FOR PROVIDING TEMPORARY WATER, POWER, HEAT, LIFTS, STAGING, ETC. AS NEEDED AT THE SITE. TEMPORARY LIGHTING WITHIN THE WORK AREAS MUST BE CONNECTED TO GROUND FAULT CIRCUIT INTERRUPTER (GFCI) POWER PANELS INSTALLED BY A STATE OF CONNECTICUT LICENSED ELECTRICIAN, PERMITTED AS REQUIRED, AND LOCATED OUTSIDE THE WORK AREAS.