

TOWN OF TRUMBULL, CT


WHITNEY AVENUE AT MAIN STREET (ROUTE 111)

INTERSECTION IMPROVEMENTS

AUGUST 2018

LIST OF DRAWINGS	
SHEET NO.	SHEET TITLE
	COVER SHEET
1	TOPOGRAPHIC AND RIGHT OF WAY SURVEY (MARTIN SURVEYING)
2	TYPICAL SECTIONS AND GENERAL NOTES
3	CONSTRUCTION PLAN
4	GRADING & SOIL EROSION AND SEDIMENT CONTROL PLAN
5	SIGNING AND PAVEMENT MARKING PLAN
6	MAINTENANCE AND PROTECTION OF TRAFFIC PLAN DETAILS
7	DETAILS
8	CROSS SECTIONS STA 0+50 TO 1+00
9	CROSS SECTIONS STA 1+25 TO 1+75
10	TRUCK TURN MOVEMENTS

CTDOT STANDARD SHEETS	
SHEET NO.	SHEET TITLE
11	SIDEWALK RAMP SHEET 1
12	SIDEWALK RAMP SHEET 2
13	SIDEWALK RAMP SHEET 3
14	SIDEWALK RAMP SHEET 4
HW-507_01	TYPE "C", "C-L" & DROP INLET CATCH BASIN
HW-507_07	TYPE "C" & "C-L" CATCH BASIN TOPS AND CURBS
HW-507_10	MANHOLE - FRAME & COVER
HW-815_01	BITUMINOUS CONCRETE CURBING
HW-921_01	DRIVEWAY RAMPS AND SIDEWALKS
TR-1208_01	SIGN PLACEMENT AND RETROREFLECTIVE STRIP DETAILS
TR-1208_02	METAL SIGN POSTS AND SIGN MOUNTING DETAIL
TR-1210_04	PAVEMENT MARKING LINES AND SYMBOLS
TR-1210_08	PAVEMENT MARKINGS FOR NON FREEWAYS
TR-1220_01	SIGNS FOR CONSTRUCTION AND PERMIT OPERATIONS
TR-1220_02	CONSTRUCTION SIGN SUPPORTS AND CHANNELIZING DEVICES

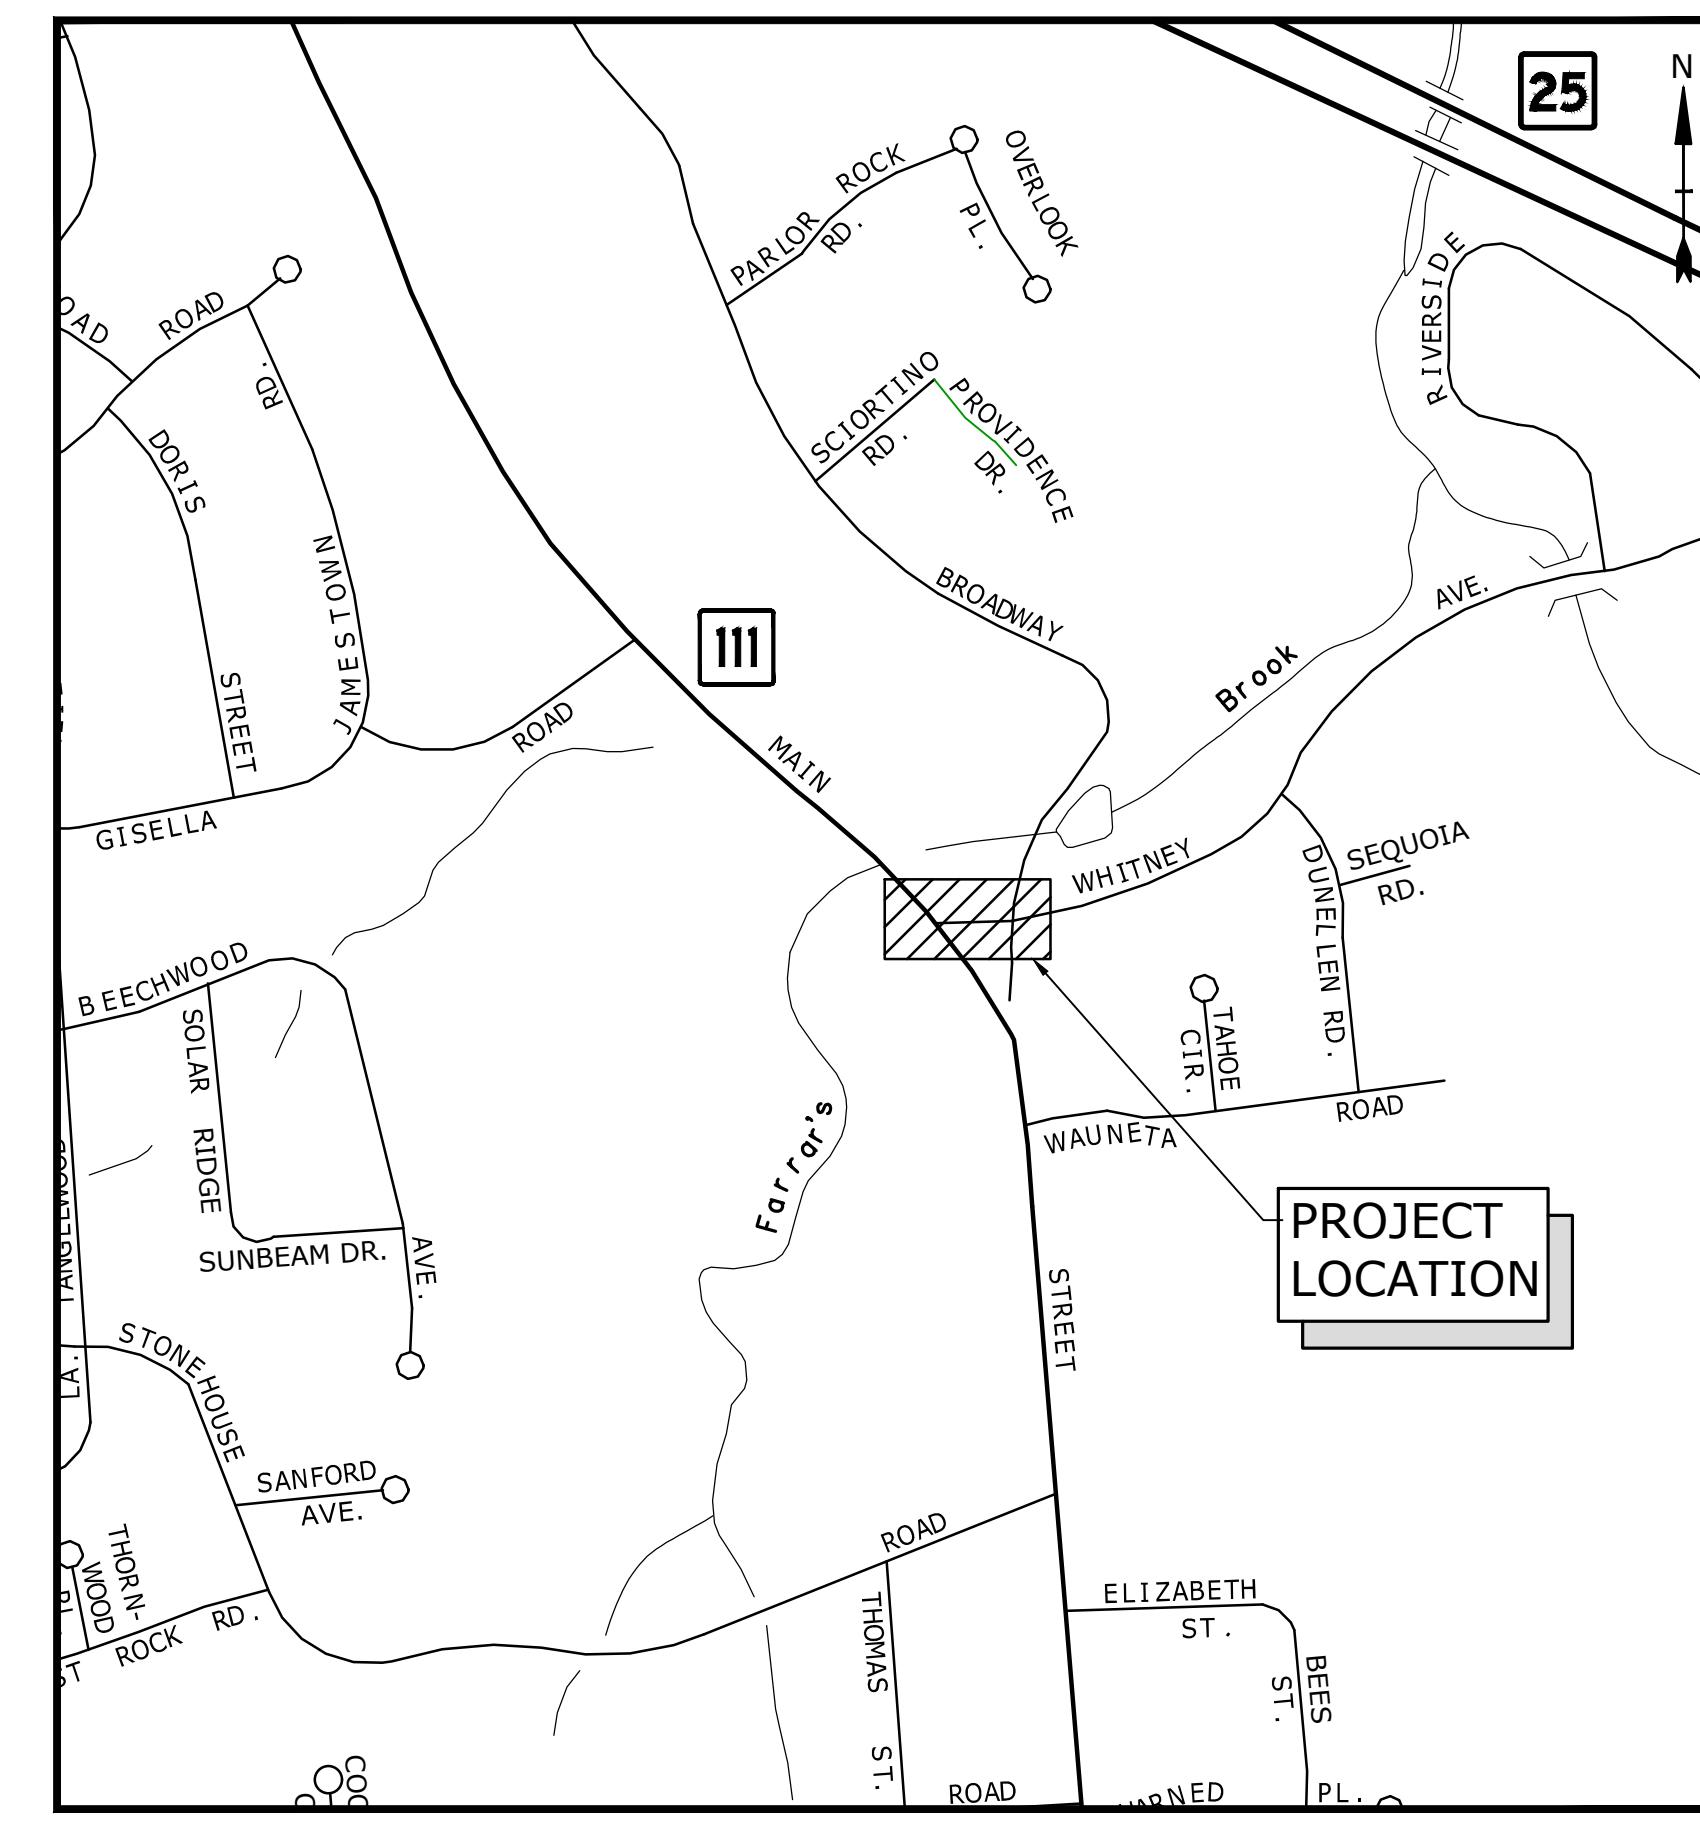


PREPARED BY:
Tighe&Bond
www.tighebond.com

ALFRED J. MASCIA JR., P.E.

DANA C. HUFF, P.E.

PREPARED FOR:
TOWN OF TRUMBULL

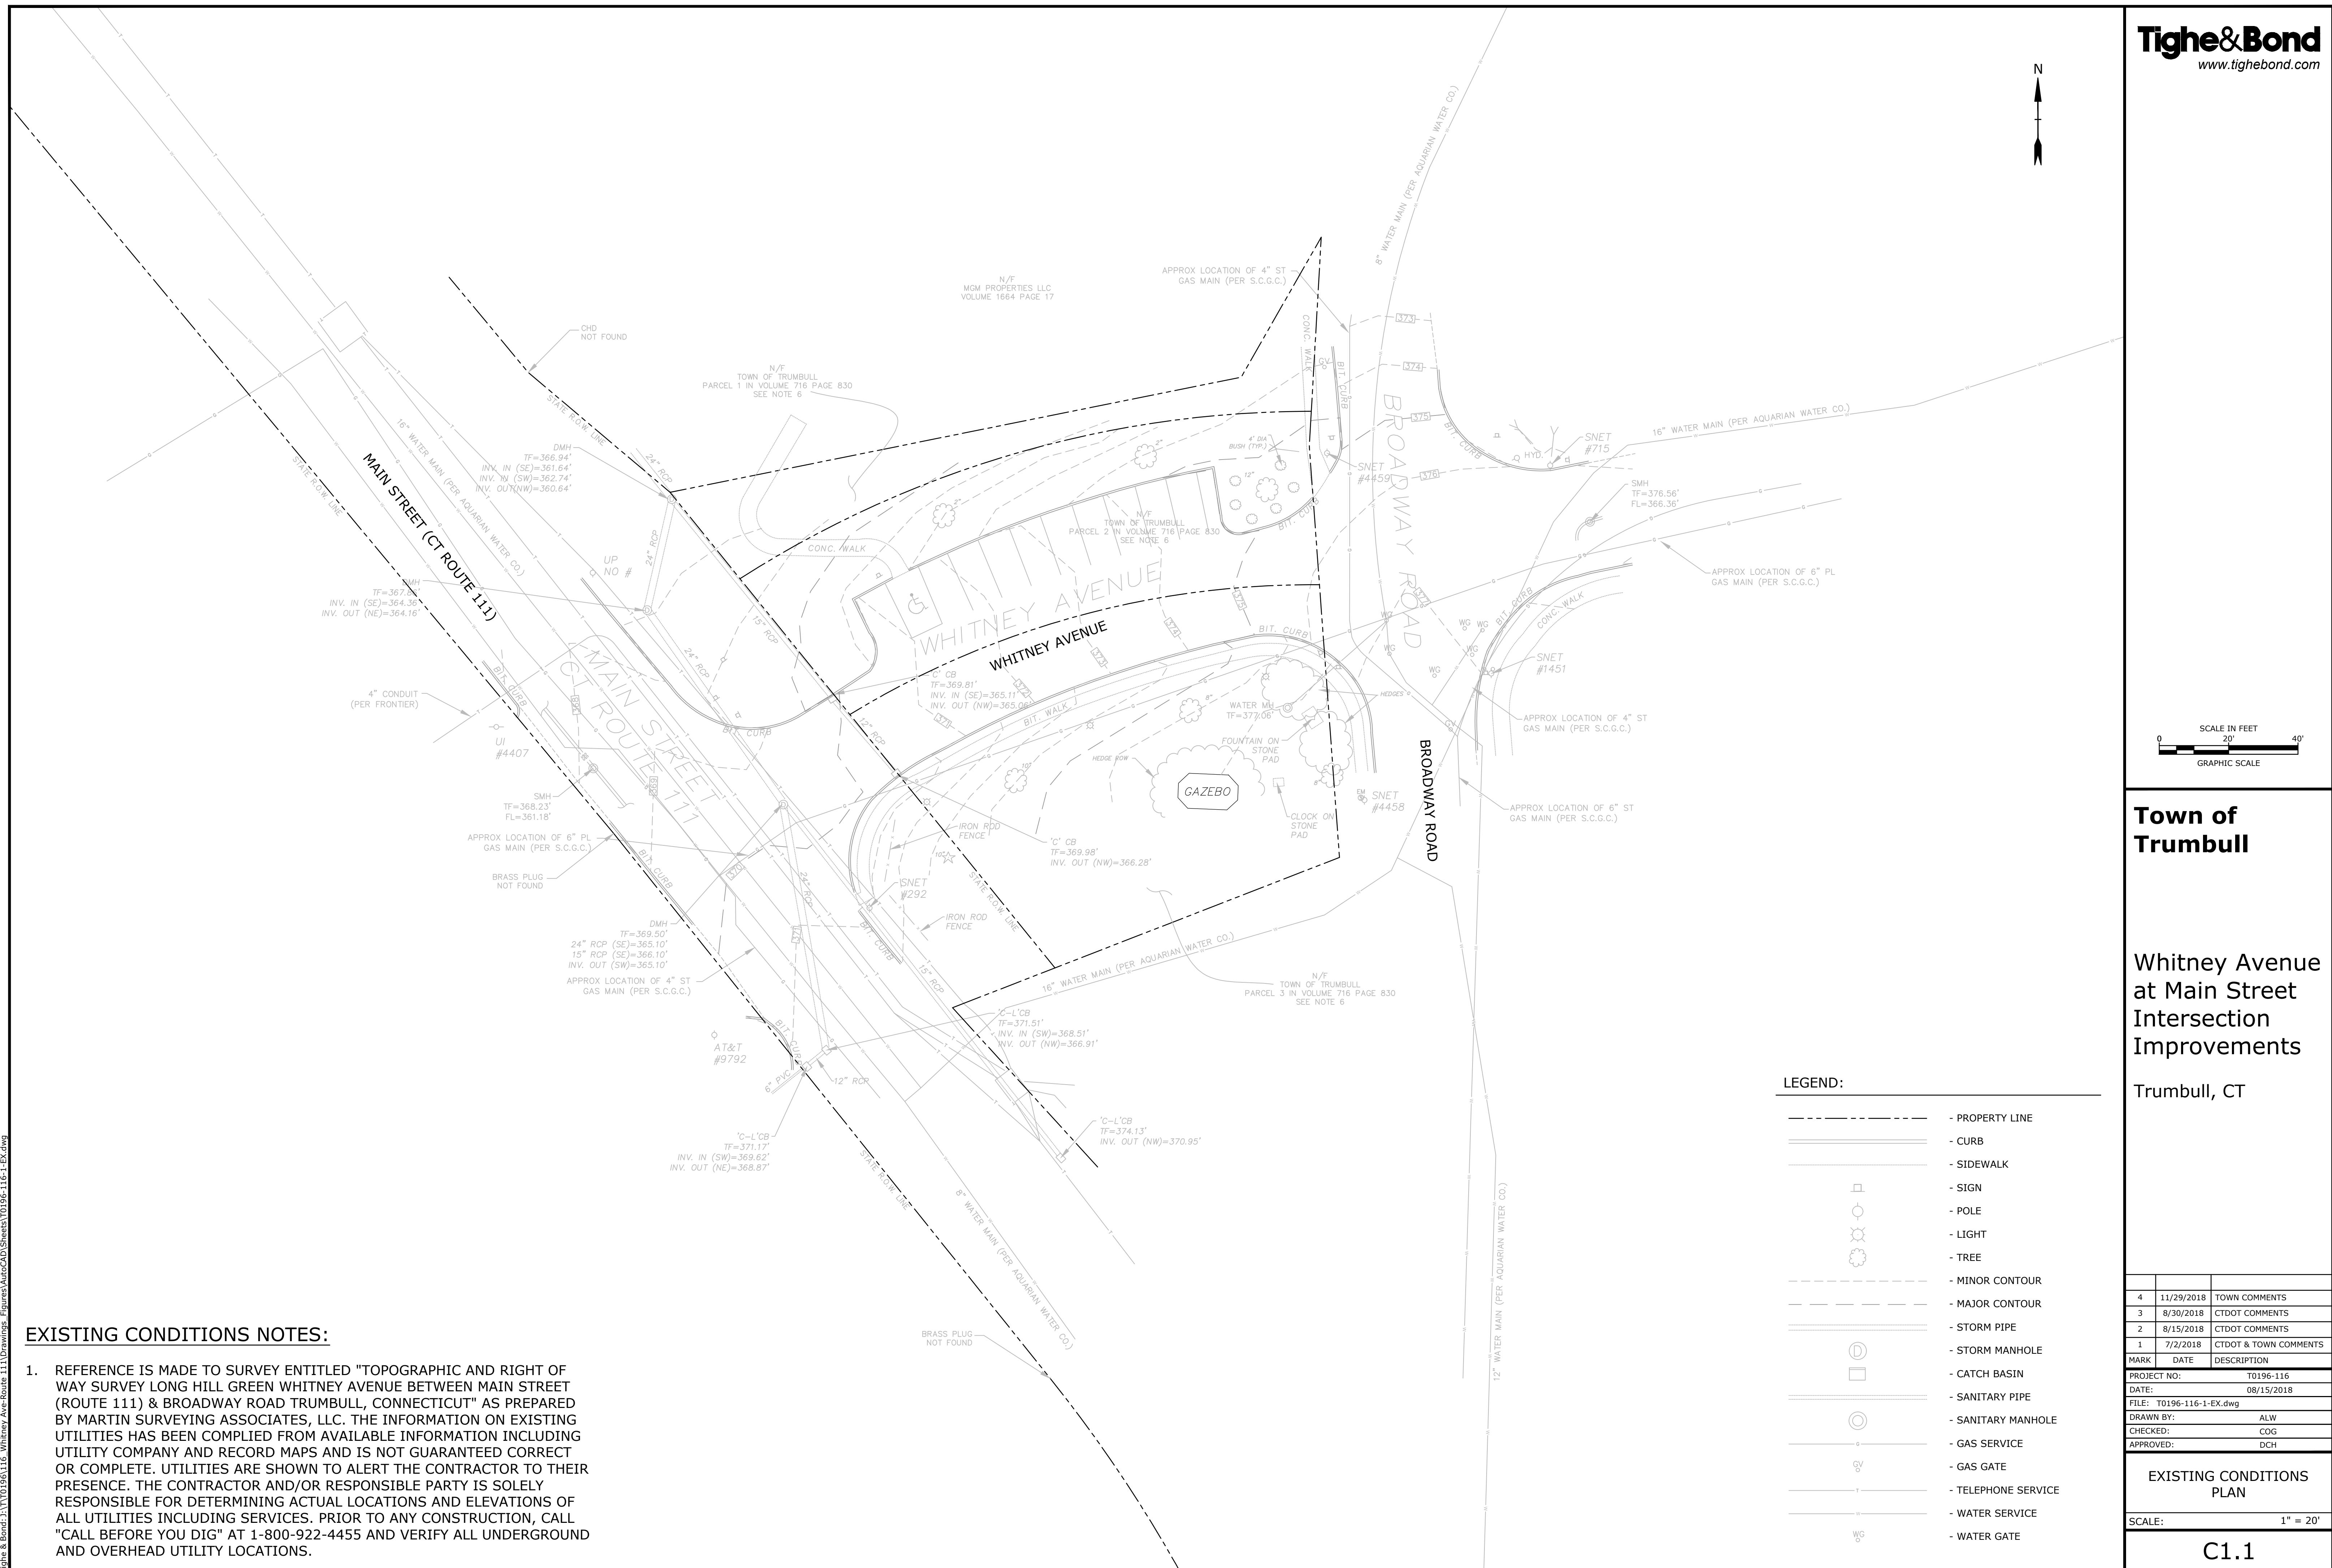

EXISTING CONDITIONS NOTES:

- REFERENCE IS MADE TO SURVEY ENTITLED "TOPOGRAPHIC AND RIGHT OF WAY SURVEY LONG HILL GREEN WHITNEY AVENUE BETWEEN MAIN STREET (ROUTE 111) & BROADWAY ROAD TRUMBULL, CONNECTICUT" DATED 12/20/2017, AS PREPARED BY MARTIN SURVEYING ASSOCIATES, LLC. THE INFORMATION ON EXISTING UTILITIES HAS BEEN COMPILED FROM AVAILABLE INFORMATION INCLUDING UTILITY COMPANY AND RECORD MAPS AND IS NOT GUARANTEED CORRECT OR COMPLETE. UTILITIES ARE SHOWN TO ALERT THE CONTRACTOR TO THEIR PRESENCE. THE CONTRACTOR AND/OR RESPONSIBLE PARTY IS SOLELY RESPONSIBLE FOR DETERMINING ACTUAL LOCATIONS AND ELEVATIONS OF ALL UTILITIES INCLUDING SERVICES. PRIOR TO ANY CONSTRUCTION, CALL "CALL BEFORE YOU DIG" AT 1-800-922-4455 AND VERIFY ALL UNDERGROUND AND OVERHEAD UTILITY LOCATIONS.

TYPICAL SECTION MATERIAL NOTES:


- FORMATION OF SUBGRADE SHALL BE CONDUCTED IN ACCORDANCE WITH SECTION 2.09 OF THE CONNECTICUT DEPARTMENT OF TRANSPORTATION FORM 817.
- PROCESSED AGGREGATE BASE SHALL BE PROVIDED IN ACCORDANCE WITH SECTION 3.04 OF THE CONNECTICUT DEPARTMENT OF TRANSPORTATION FORM 817.
- BITUMINOUS CONCRETE SHALL BE PROVIDED IN ACCORDANCE WITH SECTION 4.06 OF THE CONNECTICUT DEPARTMENT OF TRANSPORTATION FORM 817.
- TACK COAT MATERIAL SHALL BE PROVIDED IN ACCORDANCE WITH SECTION 4.06 OF THE CONNECTICUT DEPARTMENT OF TRANSPORTATION FORM 817.
- BITUMINOUS CONCRETE CURBING SHALL BE PROVIDED IN ACCORDANCE WITH SECTION 8.15 OF THE CONNECTICUT DEPARTMENT OF TRANSPORTATION FORM 817.
- CONCRETE SIDEWALKS AND RAMPS SHALL BE PROVIDED IN ACCORDANCE WITH SECTION 9.21 OF THE CONNECTICUT DEPARTMENT OF TRANSPORTATION FORM 817.
- BITUMINOUS CONCRETE SIDEWALK SHALL BE PROVIDED IN ACCORDANCE WITH SECTION 9.22 OF THE CONNECTICUT DEPARTMENT OF TRANSPORTATION FORM 817.
- TOPSOIL AND TURF ESTABLISHMENT SHALL BE PROVIDED IN ACCORDANCE WITH SECTION 9.44 OF THE CONNECTICUT DEPARTMENT OF TRANSPORTATION FORM 817.

CONSTRUCTION NOTES:


- CONSTRUCTION SHALL COMPLY WITH THE TOWN OF TRUMBULL STANDARDS & CONNDOT FORM 817.
- THE CONTRACTOR SHALL OBTAIN A TOWN OF TRUMBULL ROADWAY ENCROACHMENT PERMIT PRIOR TO ANY WORK BEING PERFORMED WITHIN TOWN RIGHT-OF-WAY.
- THE CONTRACTOR IS RESPONSIBLE FOR THE MAINTENANCE AND PROTECTION OF TRAFFIC. THE CONTRACTOR SHALL PROVIDE A PLAN SHOWING PROPOSED MAINTENANCE AND PROTECTION OF TRAFFIC TO THE TOWN OF TRUMBULL AND THE ENGINEER FOR APPROVAL PRIOR TO THE START OF CONSTRUCTION.
- ALL UNDERGROUND UTILITIES SHOULD BE CONSIDERED APPROXIMATE LOCATIONS. CONTRACTOR SHALL CONTACT "CALL BEFORE YOU DIG" PRIOR TO ANY EXCAVATION.
- EXCAVATION OF ANY TYPE SHALL BE ACCOMPLISHED IN SUCH A MANNER THAT UNDERGROUND UTILITIES OR STRUCTURES ARE NOT DAMAGED. IT SHALL BE THE CONTRACTOR'S SOLE RESPONSIBILITY FOR ANY DAMAGED INCURRED DURING EXCAVATION OPERATIONS. ALL EXCAVATION SHALL BE IN CONFORMANCE WITH THE LATEST OSHA REQUIREMENTS.
- ALL WORK TO BE CONFINED WITHIN THE CONTRACT LIMITS WITH NO CLEARING, EXCAVATION, OR DEPOSITION OF FILL TO TAKE PLACE WITHIN REGULATED AREAS OUTSIDE OF THE PROJECT LIMITS.
- ALL DRIVEWAYS, ROADS, STAIRS, AND SIDEWALKS DISTURBED BY THE CONSTRUCTION IN OR OUTSIDE THE PROJECT LIMIT LINE SHALL BE RETURNED TO THEIR ORIGINAL CONDITION OR BETTER AND SHALL BE GRADED TO MEET THE PROPOSED CONSTRUCTION AS DIRECTED BY THE OWNER'S REPRESENTATIVE AT NO ADDITIONAL COST TO THE OWNER.
- ANY DAMAGE TO EXISTING CURB, SIDEWALK OR ANY OTHER HIGHWAY APPURTEINANCES SHALL BE REPAIRED BY THE CONTRACTOR AT NO COST TO THE TOWN OF TRUMBULL.
- PROVIDE A CONSTRUCTION SCHEDULE, PRIOR TO THE BEGINNING OF WORK, TO THE TOWN OF TRUMBULL ENGINEERING DEPARTMENT AND INSPECTOR. PROVIDE UPDATED SCHEDULE ON A BI-WEEKLY BASIS THROUGHOUT CONSTRUCTION.
- IT IS THE RESPONSIBILITY OF EACH BIDDER IN EVALUATING THESE PLANS TO MAKE EXAMINATIONS IN THE FIELD BY VARIOUS METHODS AND OBTAIN NECESSARY INFORMATION FROM AVAILABLE RECORDS, UTILITY COMPANIES, AND INDIVIDUALS AS TO THE LOCATION OF ALL SUBSURFACE STRUCTURES. REVIEW ALL OF THE DRAWINGS AND SPECIFICATIONS ASSOCIATED WITH THIS PROJECT WORK SCOPE PRIOR TO SUBMITTING A BID. SHOULD THE CONTRACTOR FIND A CONFLICT WITH THE DOCUMENTS RELATIVE TO THE SPECIFICATIONS OR APPLICABLE CODES, IT IS THE CONTRACTOR'S RESPONSIBILITY TO NOTIFY THE TOWN ENGINEER IN WRITING PRIOR TO THE BID OPENING. FAILURE BY THE CONTRACTOR TO NOTIFY THE TOWN ENGINEER SHALL CONSTITUTE ACCEPTANCE OF FULL RESPONSIBILITY BY THE CONTRACTOR TO COMPLETE THE SCOPE OF WORK AS DEFINED BY THE DRAWINGS AND IN FULL CONFORMANCE WITH LOCAL REGULATIONS AND CODES.
- IT IS THE RESPONSIBILITY OF THE CONTRACTOR TO VERIFY ALL ELEVATIONS, PROPERTY LINES, LOCATIONS OF UTILITIES AND SITE CONDITIONS IN THE FIELD. IF AN UNFORESEEN INTERFERENCE EXISTS BETWEEN AN EXISTING AND A PROPOSED STRUCTURE, THE CONTRACTOR SHALL NOTIFY THE DESIGN ENGINEER SO THAT THE APPROPRIATE REVISIONS CAN BE MADE.

817 CONSTRUCTION NOTES:

- REMOVAL OF PAVEMENT MARKINGS ALONG STATE ROADWAYS SHALL BE COMPLETED BY A NON-DESTRUCTIVE METHOD IN COMPLIANCE WITH THE STATE OF CONNECTICUT DEPARTMENT OF TRANSPORTATION STANDARD SPECIFICATIONS FOR ROAD, BRIDGES, AND INCIDENTAL CONSTRUCTION FORM 817 SECTION 12.11 AS REVISED.
- NEW PAVEMENT MARKINGS SHALL BE PAINTED WITH EPOXY RESIN PAINT IN COMPLIANCE WITH THE STATE OF CONNECTICUT DEPARTMENT OF TRANSPORTATION STANDARD SPECIFICATIONS FOR ROADS, BRIDGES, AND INCIDENTAL CONSTRUCTION FOR 817 SECTION 12.10 AS REVISED.
- NEW SIGN MATERIAL AND SHEETING SHALL BE MADE OF REFLECTIVE MATERIAL IN COMPLIANCE WITH STATE OF CONNECTICUT DEPARTMENT OF TRANSPORTATION STANDARD SPECIFICATIONS FOR ROADS, BRIDGES, AND INCIDENTAL CONSTRUCTION FOR 817 SECTION 12.08 AS REVISED. TYPE 1 REFLECTIVE SHEETING SHALL BE USED FOR SIGNS WITH WHITE BACKGROUND, TYPE 3 REFLECTIVE SHEETING SHALL BE USED FOR SIGNS WITH COLORED BACKGROUND EXCEPT FOR SIGNS WITH RED BACKGROUND THAT SHALL BE TYPE 8 OR 9 REFLECTIVE SHEETING.
- ALL SIGNS AND PAVEMENT MARKINGS INSTALLED ALONG THE STATE ROAD MUST CONFORM TO THE "MANUAL ON UNIFORM TRAFFIC CONTROL DEVICES," THE LATEST STATE OF CONNECTICUT CATALOG OF SIGNS, AND STANDARDS.
- ANY DAMAGE TO THE EXISTING CURB, SIDEWALK OR ANY OTHER HIGHWAY APPURTEINANCES SHALL BE REPLACED BY THE CONTRACTOR AS DIRECTED BY THE DISTRICT 3 PERMIT SECTION AT NO COST TO THE STATE.
- ALL WORK WITHIN THE STATE RIGHT OF WAY WILL COMPLY WITH THE STATE OF CONNECTICUT DEPARTMENT OF TRANSPORTATION STANDARD SPECIFICATIONS FOR ROADS, BRIDGES AND INCIDENTAL CONSTRUCTION FORM 817 WITH THE LATEST SPECIAL PROVISIONS AND TYPICAL STATE STANDARD DETAILS.

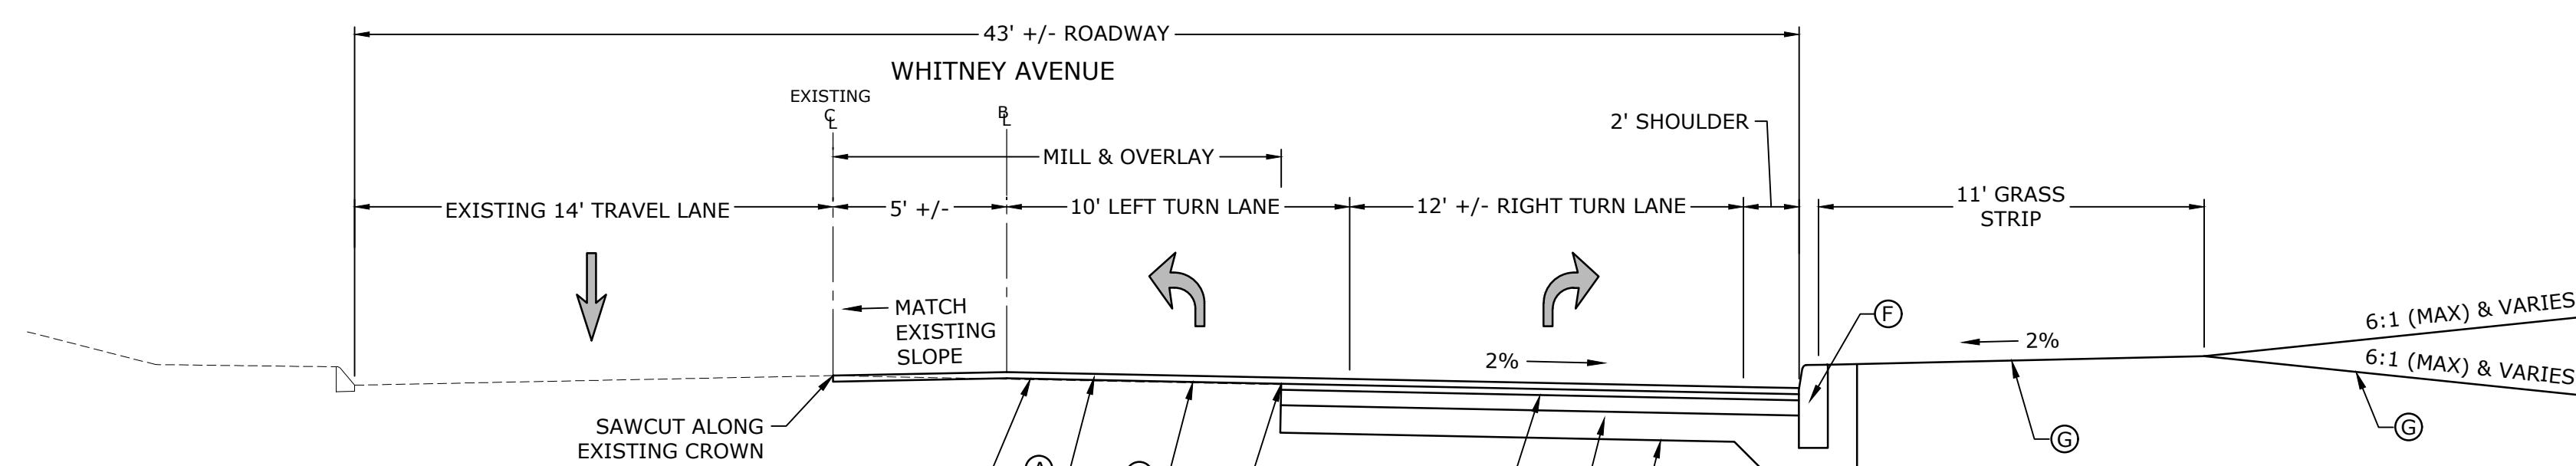

TYPICAL SECTION 1 - WHITNEY AVENUE
STA: 0+80 TO 1+63
NO SCALE

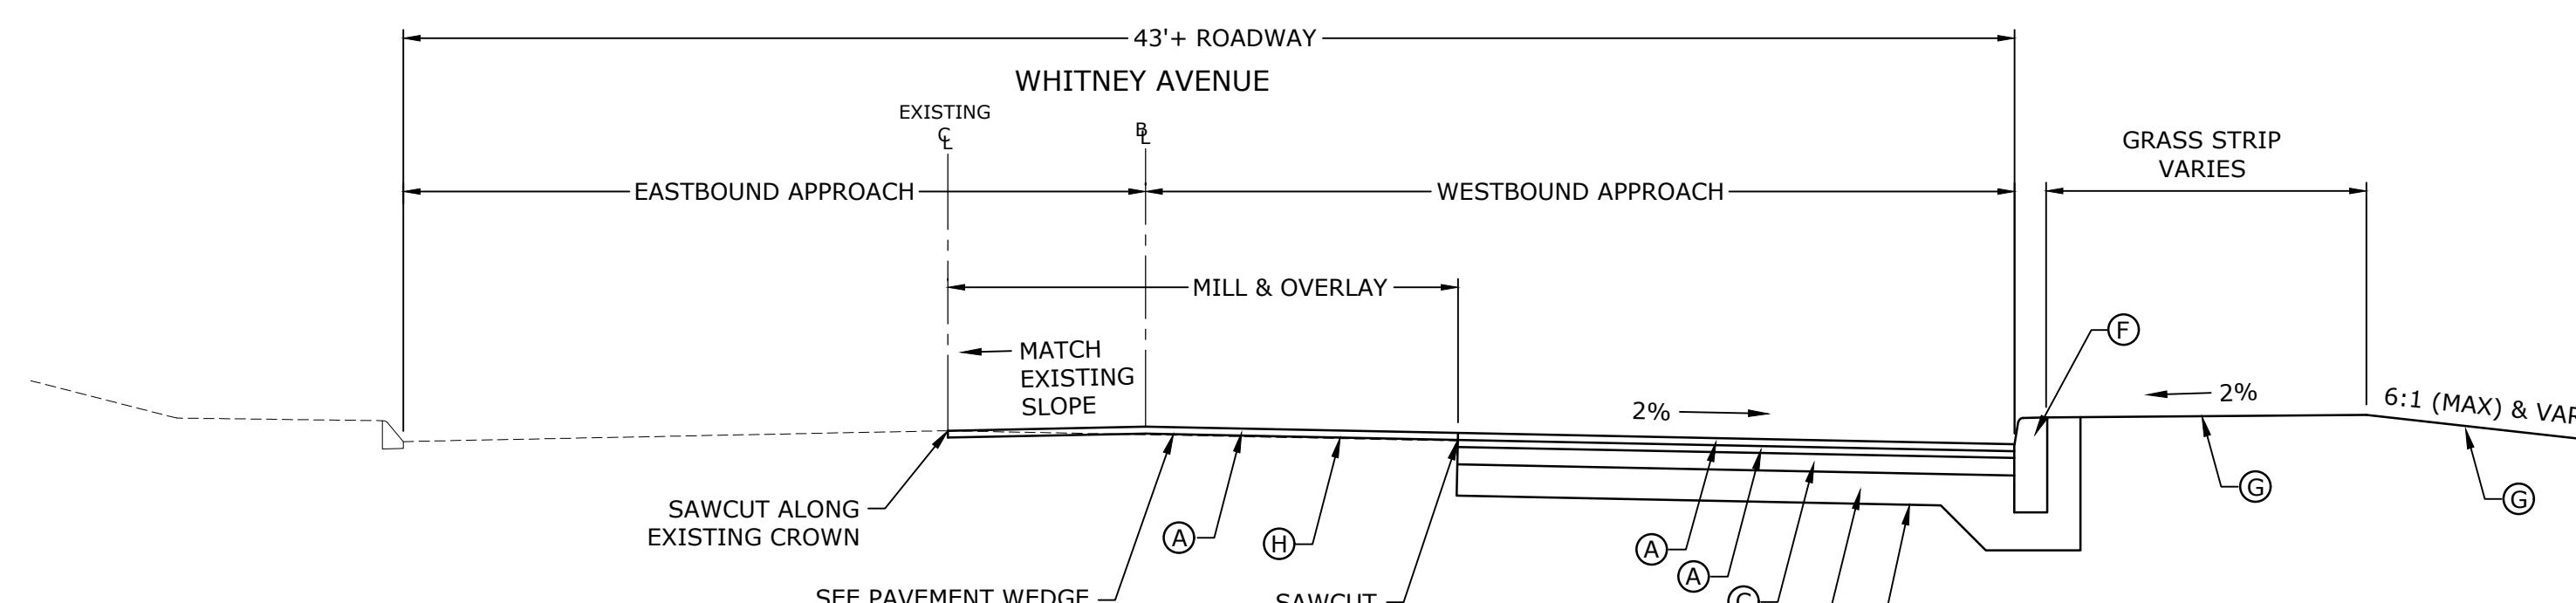

TYPICAL SECTION 2 - WHITNEY AVENUE
STA: 1+63 TO 2+03
NO SCALE

TYPICAL SECTION LEGEND:

- (A) - 2" HMA S0.5 TRAFFIC LEVEL 2
- (B) - 3" HMA S1.0
- (C) - 5" HMA S1.0 TRAFFIC LEVEL 2 (PLACED IN TWO EQUAL LIFTS)
- (D) - 12" PROCESSED AGGREGATE BASE
- (E) - FORMATION OF SUBGRADE
- (F) - 6" CONCRETE CURBING
- (G) - 4" TOPSOIL & TURF ESTABLISHMENT
- (H) - TACK COAT

Town of Trumbull

Whitney Avenue at Main Street Intersection Improvements

Trumbull, CT


STANDARD ABBREVIATIONS

@	AT	CONC	CONCRETE	MISC	MISCELLANEOUS	SAN	SANITARY
&	AND	CO	CLEAN-OUT	MON	MONUMENT	SCH	SCHEDULE
ABDN'D)	ABANDON(ED)	CPP	CORRUGATED	NIC	NOT IN CONTRACT	SDMH	STORM DRAIN MANHOLE
AC	ACRE		POLYETHYLENE PIPE	N	NORTH	SF	SQUARE FEET
AOBE	AS ORDERED BY THE	CY	CUBIC YARDS	NTS	NOT TO SCALE	S	SOUTH
BSMT	BASEMENT	DIP	DUCTILE IRON PIPE	N/A	NOT APPLICABLE	SMH	SANITARY SEWER
BCLC	BITUMINOUS CONCRETE	DWG	DRAWING	N/F	NOW OR FORMERLY	MANHOLE	MANHOLE
BGS	LIP CURBING	EOP	EDGE OF PAVEMENT	OH	OVERHEAD	STA	STATION
BOW	BELOW GROUND SURFACE	ELEC	ELECTRIC	PCC	POINT OF CURVATURE	STD	STANDARD
BL	BACK OF WALK	EL/ELEV	ELEVATION	PC	POINT OF COMPOUND	STRM	STORM
BIT	BASELINE	EMH	ELECTRIC MANHOLE	PCPP	CURVATURE	T	TANGENT LENGTH/TEL-DATA
BC	BITUMINOUS	EG	EXISTING GRADE	PED	POLYETHYLENE	TEL	TEL-DATA
BLDG	BOTTOM	EX/EXIST	EXISTING	PEDESTRIAN	TF	TOP OF FRAME	
BOT	BUILDING	G	PERF.	PERFORATED	TYP	TYPICAL	
CATV	BOTTOM	HC	PERFORATED	POINT OF INTERSECTION	TC	TOP OF CURB	
CIP	CABLE TELEVISION	HYD	PERFORATED	POINT OF TANGENCY	INCHES	TOP OF WALL	
CB	CAST IRON PIPE	IN	POINT OF REVERSE	PRC	POINT OF REVERSE	VSJ	VERTICAL STEM JOINT
CJ	CATCH BASIN	INC	INCORPORATED	PS	CURVATURE	W	WATER
CL	CONSTRUCTION JOINT	INV	INVERT	PARKING SPACES	PVC	WATER GATE/VALVE	
CLF	CENTERLINE	L	LENGTH OF CURVE	POLYVINYL CHLORIDE	RADIUS		
CTDEEP	CHAIN LINK FENCE	LT	LEFT	R	REINFORCED CONCRETE		
CTDOT	CONNECTICUT DEPT. OF ENERGY & ENV. PROTECTION	LOC	LOCATION	RCP	PIPE		
	CONNECTICUT DEPT. OF TRANSPORTATION	LP	LIGHT POLE	REV	REVISION		
		MAX	MAXIMUM	ROW	RIGHT OF WAY		
		MIN	MINIMUM	RT	RIGHT		
		MH	MANHOLE				

TYPICAL SECTIONS AND GENERAL NOTES

- SCALE: NO SCALE

SHEET 2

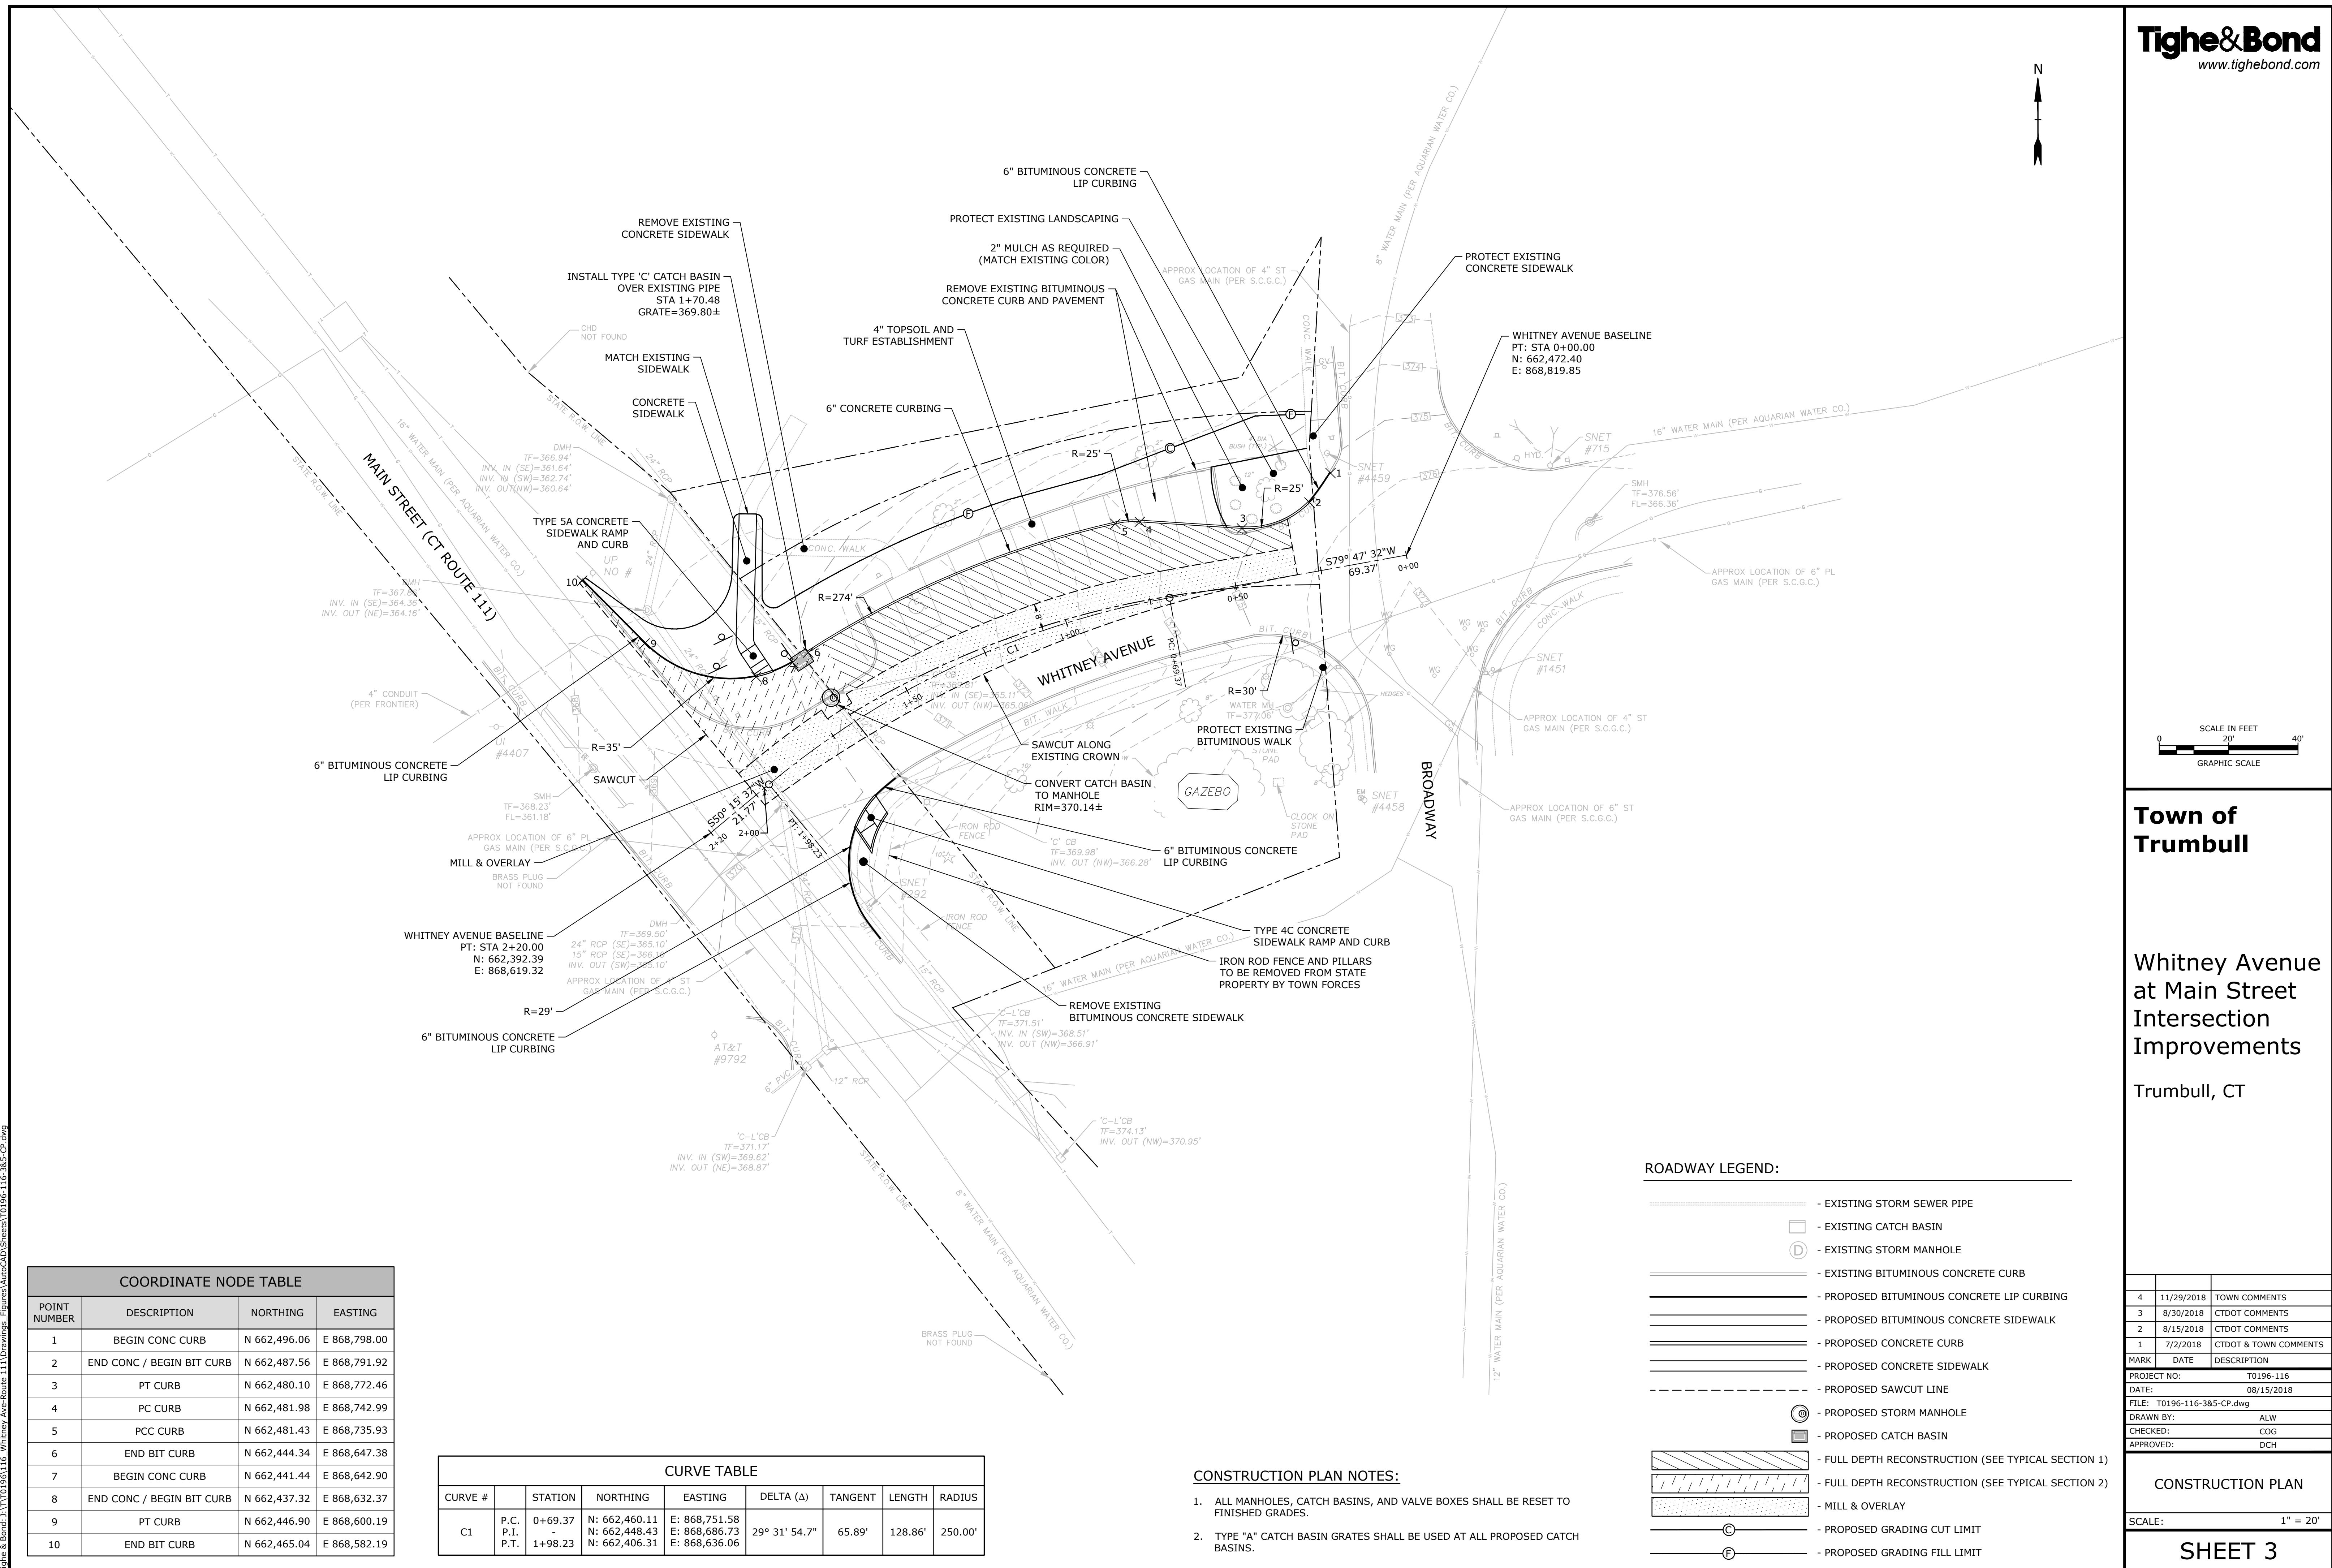


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Town of Trumbull

**Whitney Avenue
at Main Street
Intersection
Improvements**

Trumbull, CT

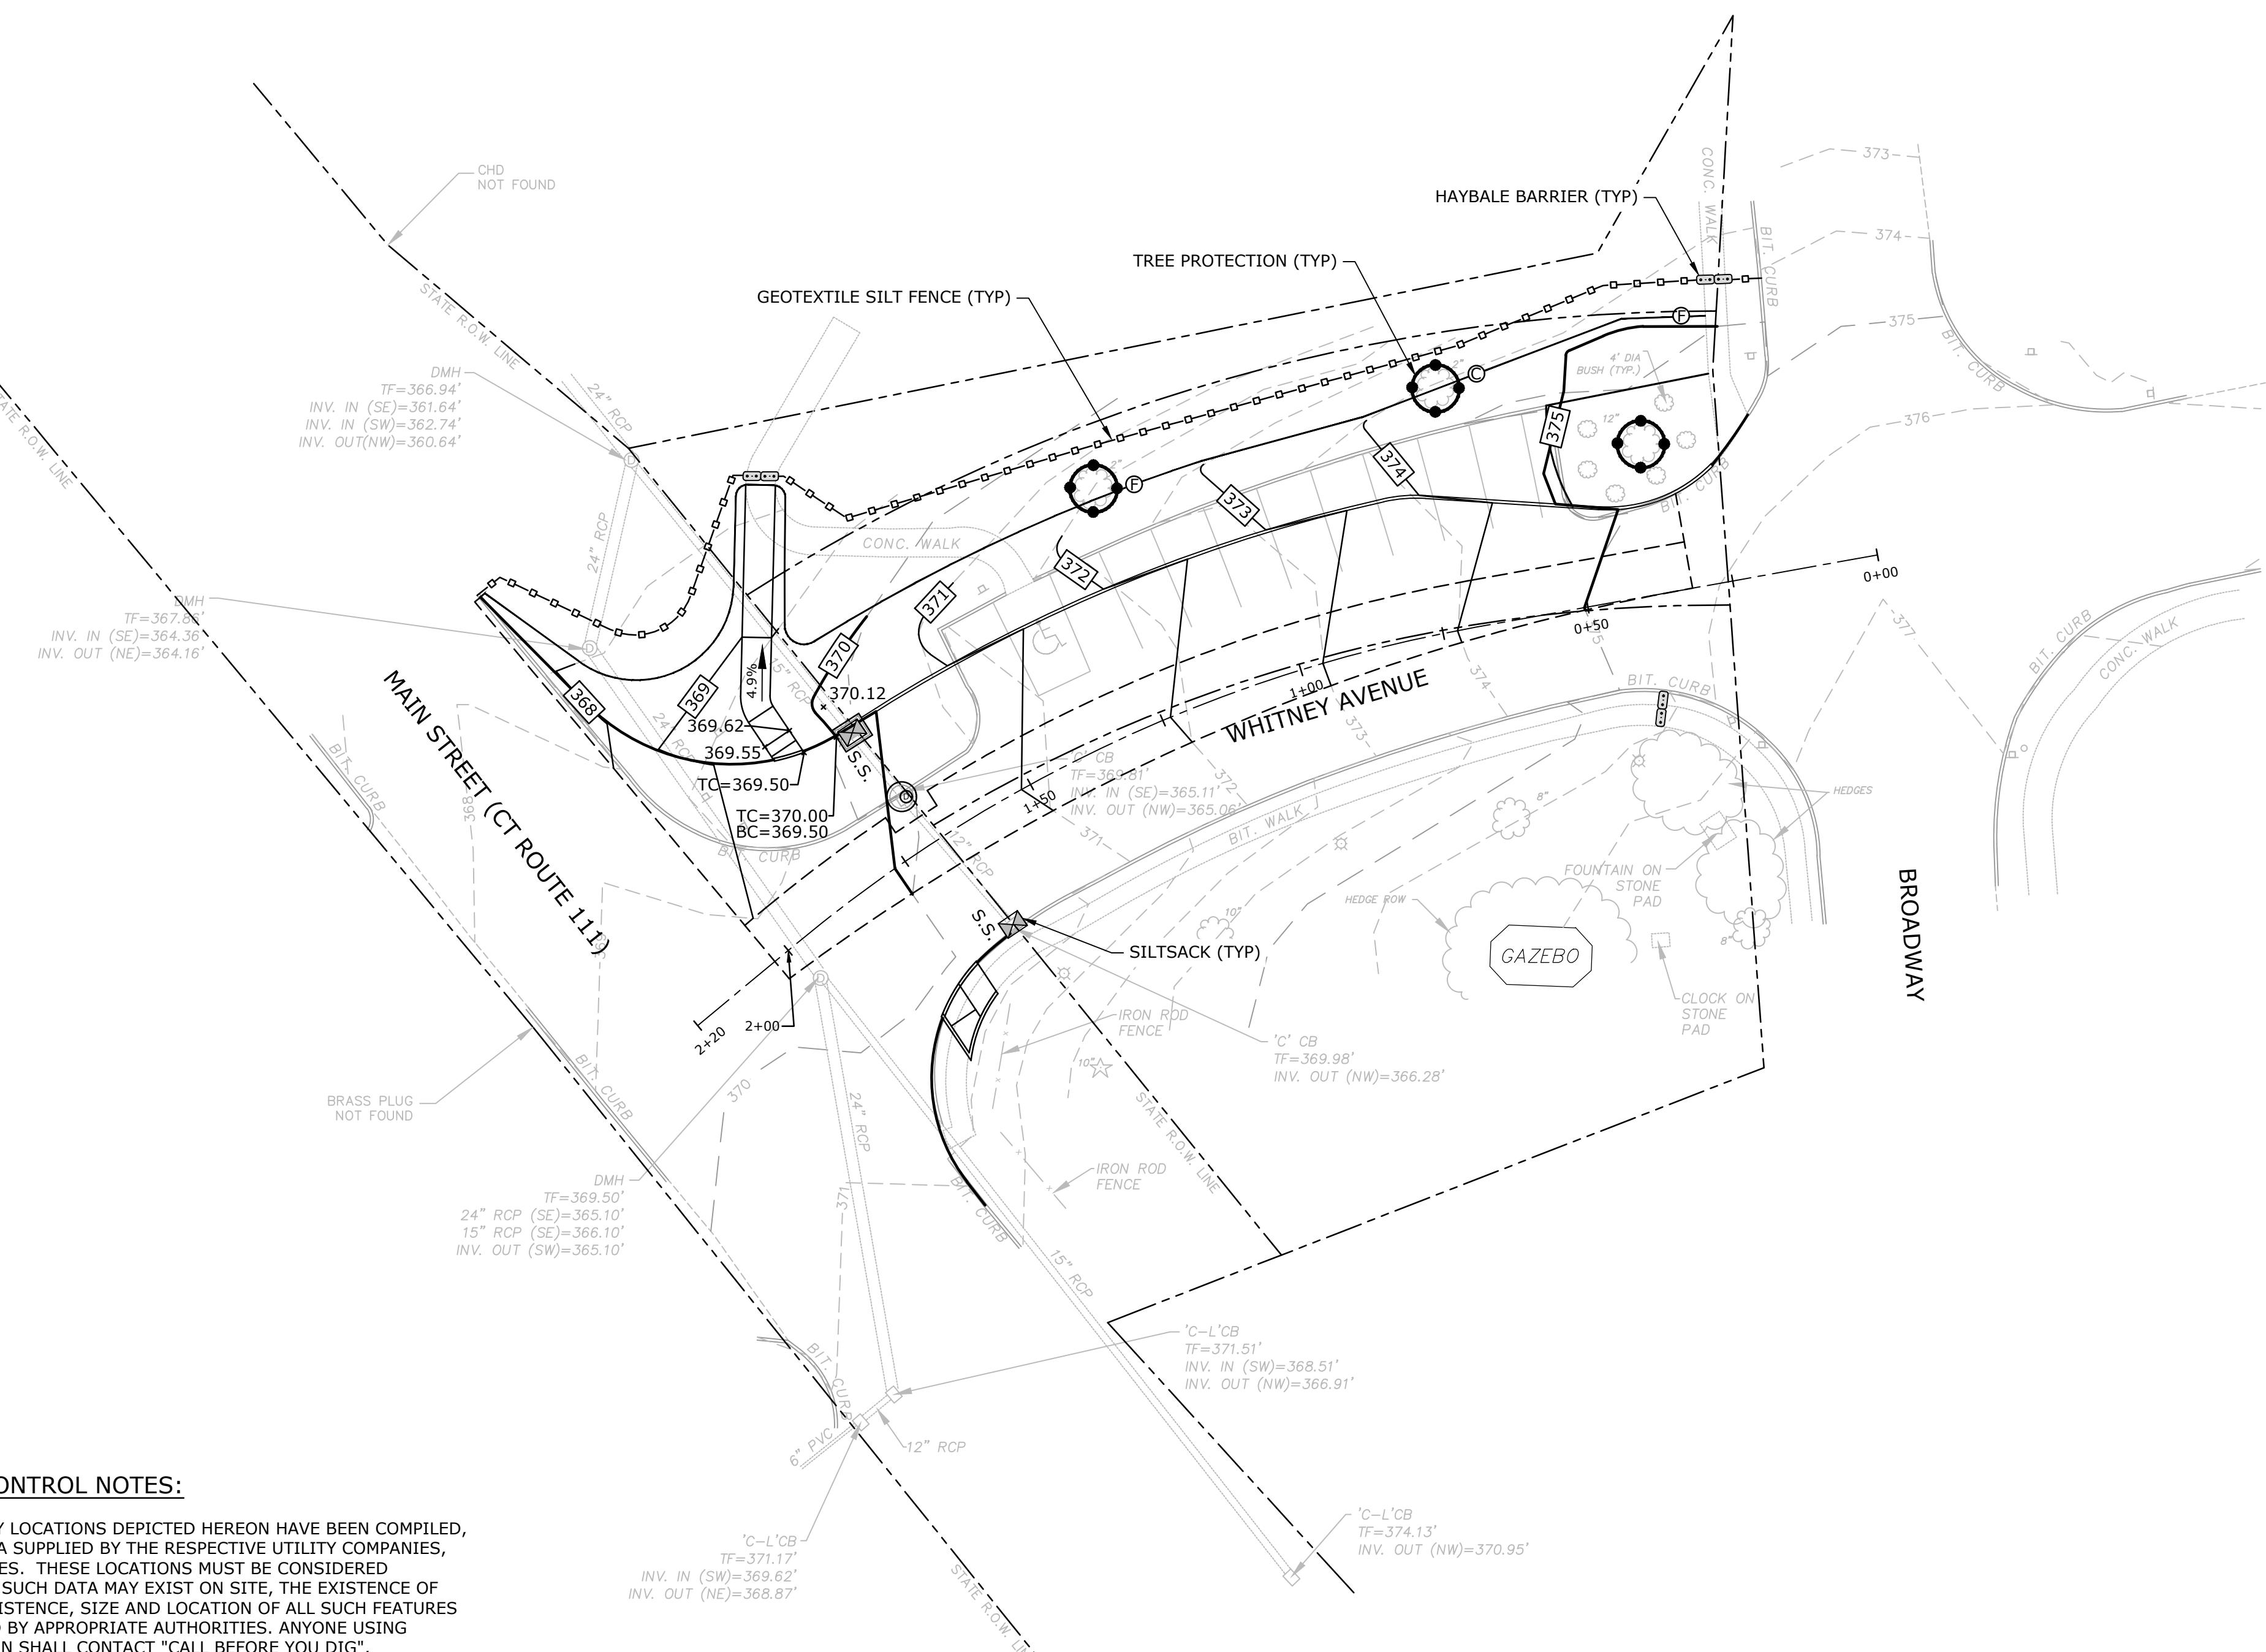

SOIL EROSION AND SEDIMENTATION CONTROL NOTES:

1. UNDERGROUND UTILITY, STRUCTURE AND FACILITY LOCATIONS DEPICTED HEREON HAVE BEEN COMPILED, IN PART, FROM RECORD MAPPING AND OTHER DATA SUPPLIED BY THE RESPECTIVE UTILITY COMPANIES, GOVERNMENTAL AGENCIES AND/OR OTHER SOURCES. THESE LOCATIONS MUST BE CONSIDERED APPROXIMATE IN NATURE. ADDITIONALLY, OTHER SUCH DATA MAY EXIST ON SITE, THE EXISTENCE, SIZE AND LOCATION OF ALL SUCH FEATURES MUST BE DETERMINED AND VERIFIED IN THE FIELD BY APPROPRIATE AUTHORITIES. ANYONE USING UTILITY INFORMATION AND DATA PROVIDED HEREIN SHALL CONTACT "CALL BEFORE YOU DIG", 1-800-922-4455 OR WWW.CBYD.COM, 72 HOURS IN ADVANCE TO VERIFY THE LOCATION OF UTILITIES PRIOR TO STARTING CONSTRUCTION.
2. ALL SEDIMENTATION AND EROSION CONTROL MEASURES SHALL BE IN ACCORDANCE WITH THE STANDARDS AND SPECIFICATIONS OF THE "2002 CONNECTICUT GUIDELINES FOR SOIL EROSION AND SEDIMENT CONTROL" DEP BULLETIN NO 34, AND ALL AMENDMENTS AND ADDENDA THERETO AS PUBLISHED BY THE CONNECTICUT DEPARTMENT OF ENERGY AND ENVIRONMENTAL PROTECTION.
3. LAND DISTURBANCE SHALL BE KEPT TO THE MINIMUM NECESSARY FOR CONSTRUCTION.
4. ALL EROSION CONTROL MEASURES SHALL BE INSTALLED AS SHOWN ON THE PLANS AND ELSEWHERE AS ORDERED BY THE OWNER'S REPRESENTATIVE, OR THE TOWN OF TRUMBULL.
5. ALL CATCH BASINS SHALL BE PROTECTED WITH SILT SACKS THROUGHOUT THE CONSTRUCTION PERIOD AND UNTIL ALL DISTURBED AREAS ARE THOROUGHLY STABILIZED.
6. WHEREVER POSSIBLE, EROSION AND SEDIMENT CONTROL MEASURES SHALL BE INSTALLED PRIOR TO CONSTRUCTION.
7. ADDITIONAL CONTROL MEASURES SHALL BE INSTALLED DURING CONSTRUCTION PERIOD AS ORDERED BY THE OWNER'S REPRESENTATIVE, OR THE TOWN OF TRUMBULL.
8. ALL SEDIMENTATION AND EROSION CONTROL MEASURES SHALL BE MAINTAINED IN EFFECTIVE CONDITION THROUGHOUT THE CONSTRUCTION PERIOD.
9. SEDIMENT REMOVED SHALL BE DISPOSED OF LEGALLY OFFSITE.
10. THE CONTRACTOR SHALL BE RESPONSIBLE FOR CONSTRUCTION AND MAINTENANCE OF ALL EROSION CONTROL MEASURES THROUGHOUT THE CONSTRUCTION PERIOD.


11. THE CONTRACTOR SHALL MAINTAIN A SUPPLY OF SILT FENCE/HAYBALES ON-SITE FOR EMERGENCY REPAIRS.
12. THE CONTRACTOR SHALL UTILIZE APPROVED METHODS/MATERIALS FOR PREVENTING THE BLOWING AND MOVEMENT OF DUST FROM EXPOSED SOIL SURFACES ONTO ADJACENT PROPERTIES AND SITE AREAS.
13. ALL DRAINAGE STRUCTURES SHALL BE INSPECTED WEEKLY BY THE CONTRACTOR AND CLEANED.
14. KEEP ALL PAVED SURFACES CLEAN. SWEEP BEFORE FORECASTED STORMS OR WEEKLY AS NECESSARY. SWEEP IMPACTED PUBLIC ROADS OF ALL DIRT AND DEBRIS AT THE END OF EACH WORK DAY.
15. TREAT ALL UNPAVED SURFACES WITH 4" MINIMUM OF TOPSOIL AND SEEDING PRIOR TO FINAL STABILIZATION.
16. HAYBALE BARRIERS AND SILT FENCING SHALL BE INSTALLED ALONG THE TOE OF CRITICAL CUT AND FILL SLOPES AS SHOWN ON THE PLANS AND AS DIRECTED BY THE OWNER'S REPRESENTATIVE OR THE TOWN OF TRUMBULL.
17. ALL TRUCKS LEAVING THE SITE MUST BE COVERED.
18. ALL SEDIMENTATION AND EROSION CONTROLS SHALL BE CHECKED WEEKLY AND AFTER EACH RAINFALL EVENT. NECESSARY REPAIRS SHALL BE MADE WITHOUT DELAY.
19. PRIOR TO ANY FORECASTED RAINFALL, EROSION AND SEDIMENT CONTROLS SHALL BE INSPECTED AND REPAIRED AS NECESSARY.
20. AFTER ALL DISTURBED AREAS HAVE BEEN STABILIZED, EROSION CONTROLS MAY BE REMOVED ONCE AUTHORIZATION TO DO SO HAS BEEN SECURED FROM THE TOWN OF TRUMBULL. DISTURBED AREAS SHALL BE SEEDED AND MULCHED.





SOIL EROSION AND SEDIMENT CONTROL AND GRADING PLAN LEGEND:

MARK	DATE	DESCRIPTION
47	11/29/2018	TOWN COMMENTS
50	8/30/2018	CTDOT COMMENTS
2	8/15/2018	CTDOT COMMENTS
1	7/2/2018	CTDOT & TOWN COMMENTS
PROJECT NO:	T0196-116	
DATE:	08/15/2018	
FILE:	T0196-116-4-SESC.dwg	
DRAWN BY:	ALW	
CHECKED:	COG	
APPROVED:	DCH	
GRADING & SEDIMENTATION AND EROSION CONTROL PLAN		
SCALE:	1" = 20'	
SHEET 4		

SITE GRADING NOTES:

21. THE GENERAL CONTRACTOR SHALL PROVIDE FIELD ENGINEERING SERVICES TO ESTABLISH AND RECORD GRADES, LINES, AND ELEVATIONS.
22. MAKE SMOOTH TRANSITIONS BETWEEN ALL SLOPE CHANGES AND FEATHER EDGES OF ALL CUTS AND FILLS TO BLEND WITH EXISTING CONDITIONS.
23. ALL EXCAVATED MATERIAL NOT REQUIRED FOR GRADING OR FILLING SHALL BE REMOVED PROMPTLY FROM THE SITE AND DISPOSED OF LEGALLY OFF-SITE PER THE PROJECT SPECIFICATIONS.
24. ANY AREAS DISTURBED BY CONSTRUCTION ACTIVITIES AND IS NOT PROVIDED WITH A SPECIFIC SITE IMPROVEMENT (PAVING, SIDEWALK, LANDSCAPING, ETC.) SHALL HAVE 4" TOPSOIL AND TURF ESTABLISHMENT IN ACCORDANCE WITH THE PROJECT LANDSCAPE SPECIFICATIONS.
25. THE LOCATIONS OF ITEMS NOT DIMENSIONED ON THE DRAWINGS SHALL BE FIELD STAKED BY THE CONTRACTOR AND THEIR LOCATIONS APPROVED BY THE OWNER'S REPRESENTATIVE PRIOR TO INSTALLATION.

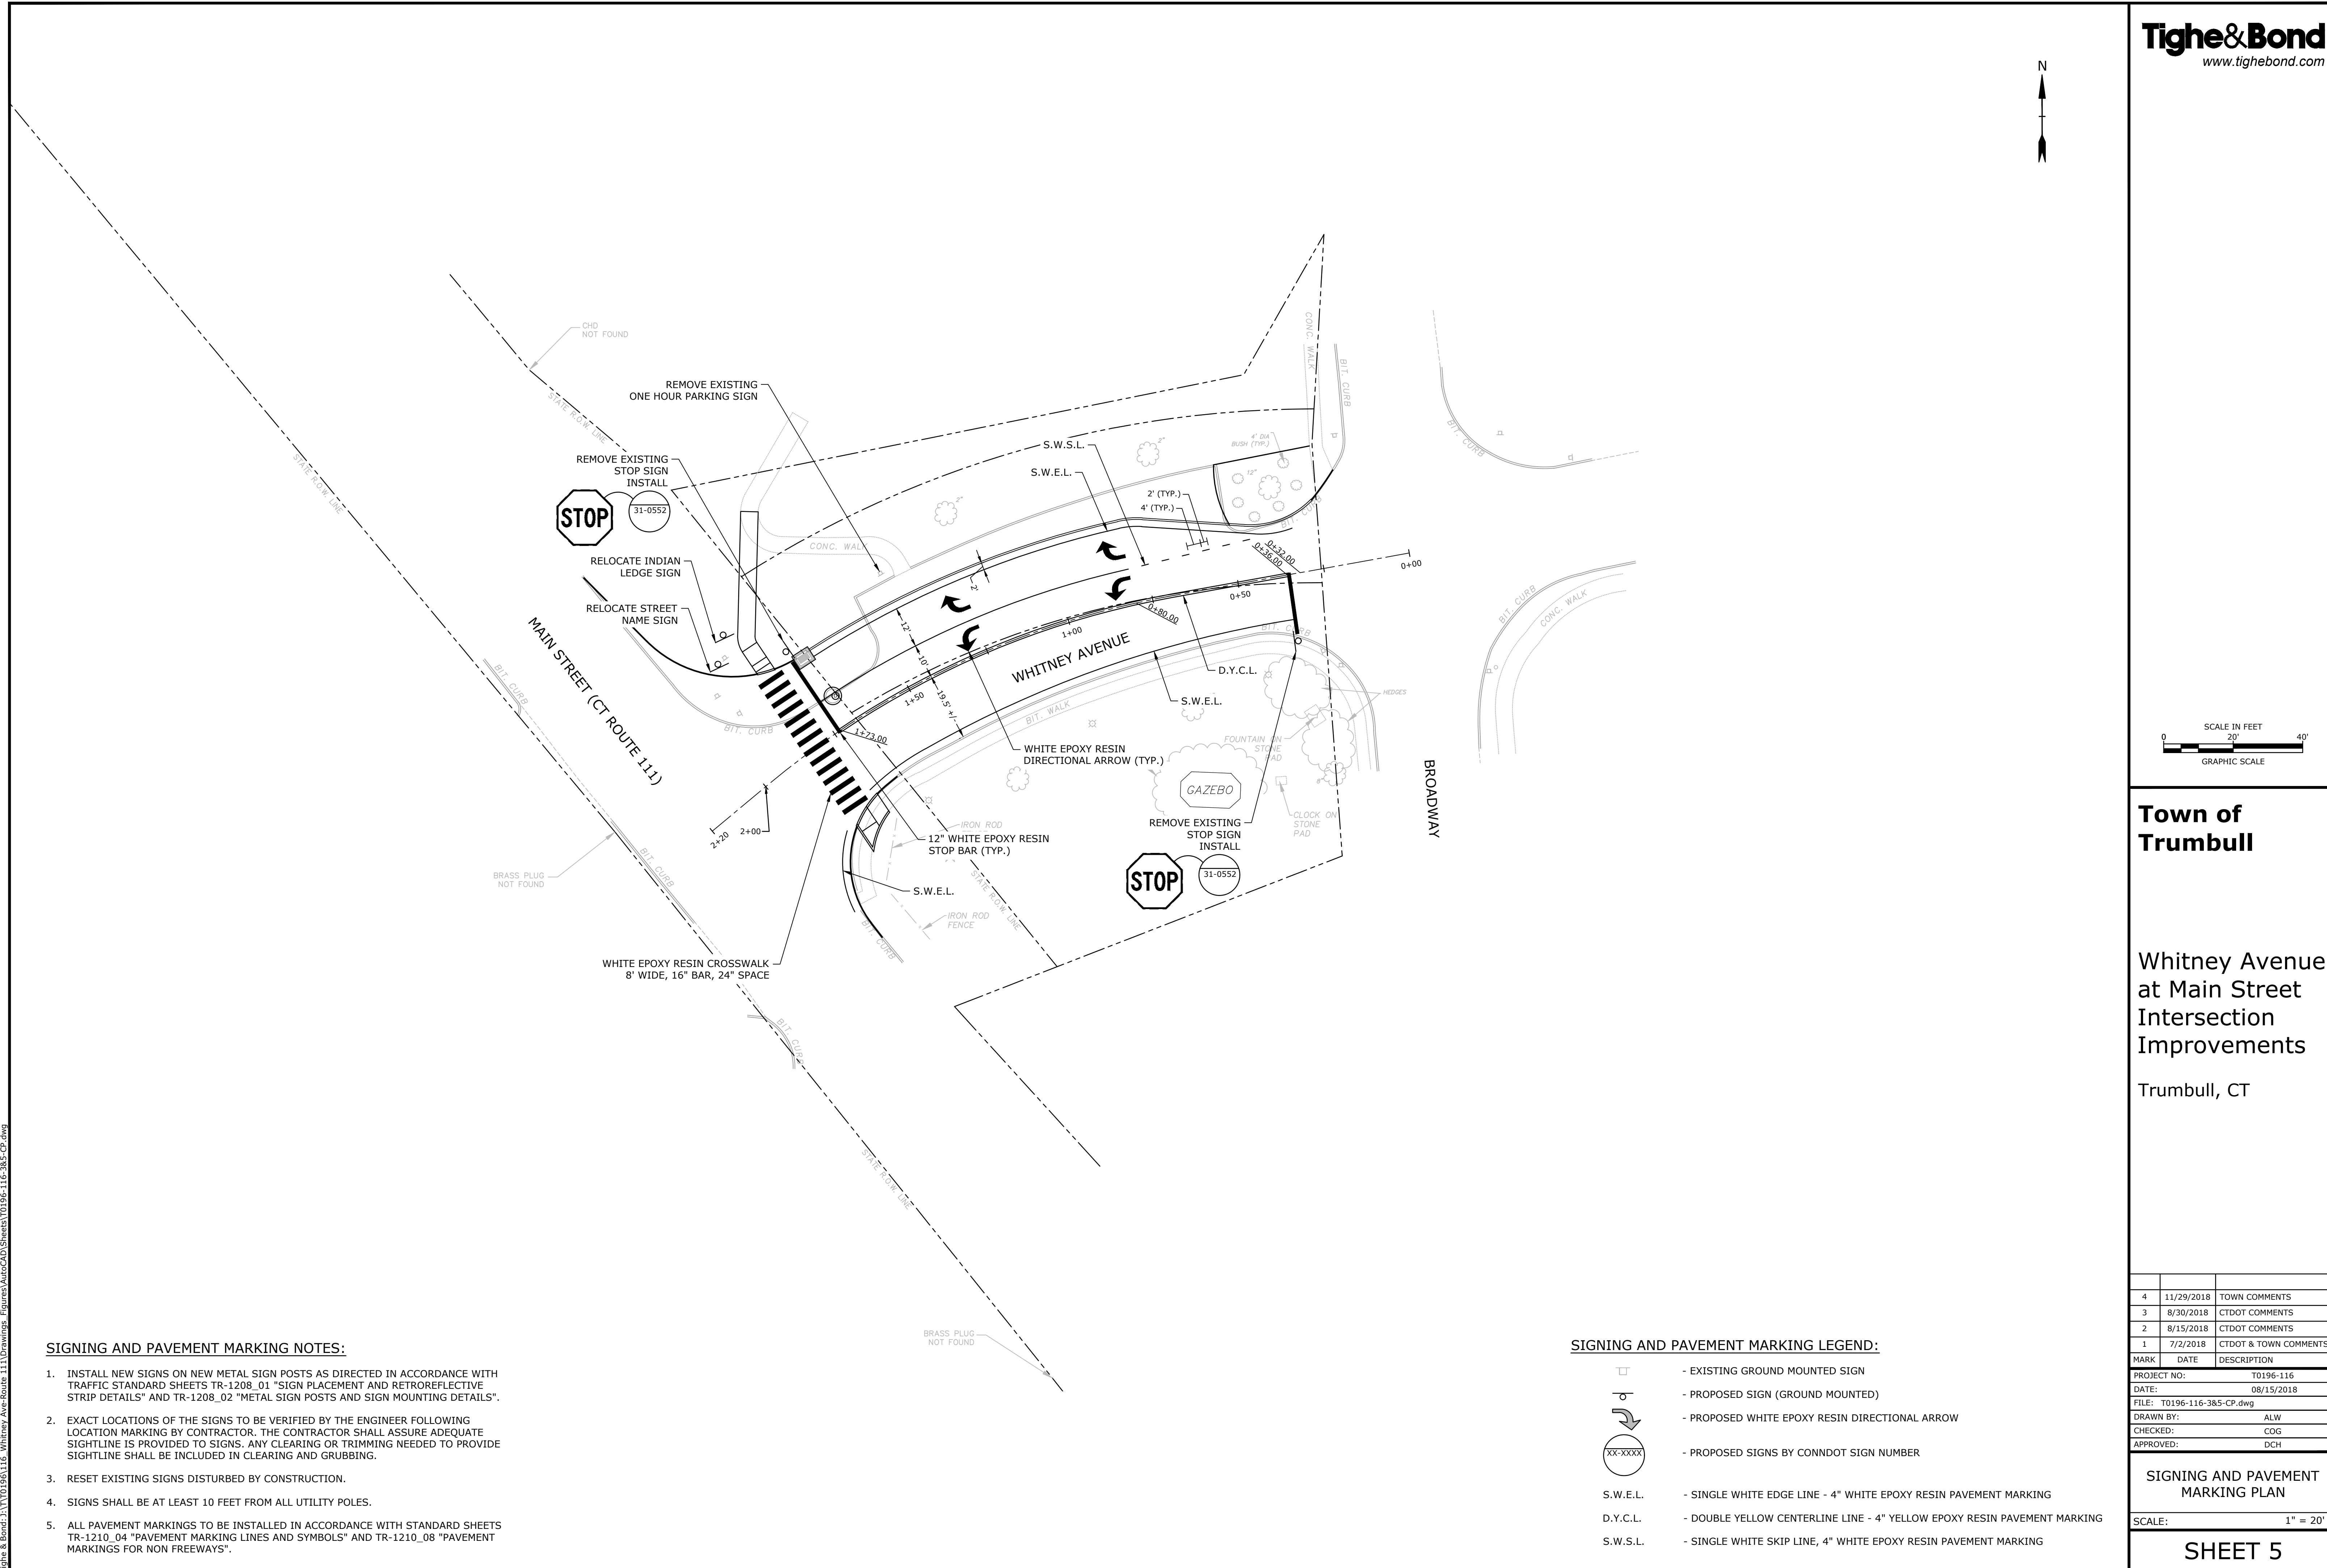

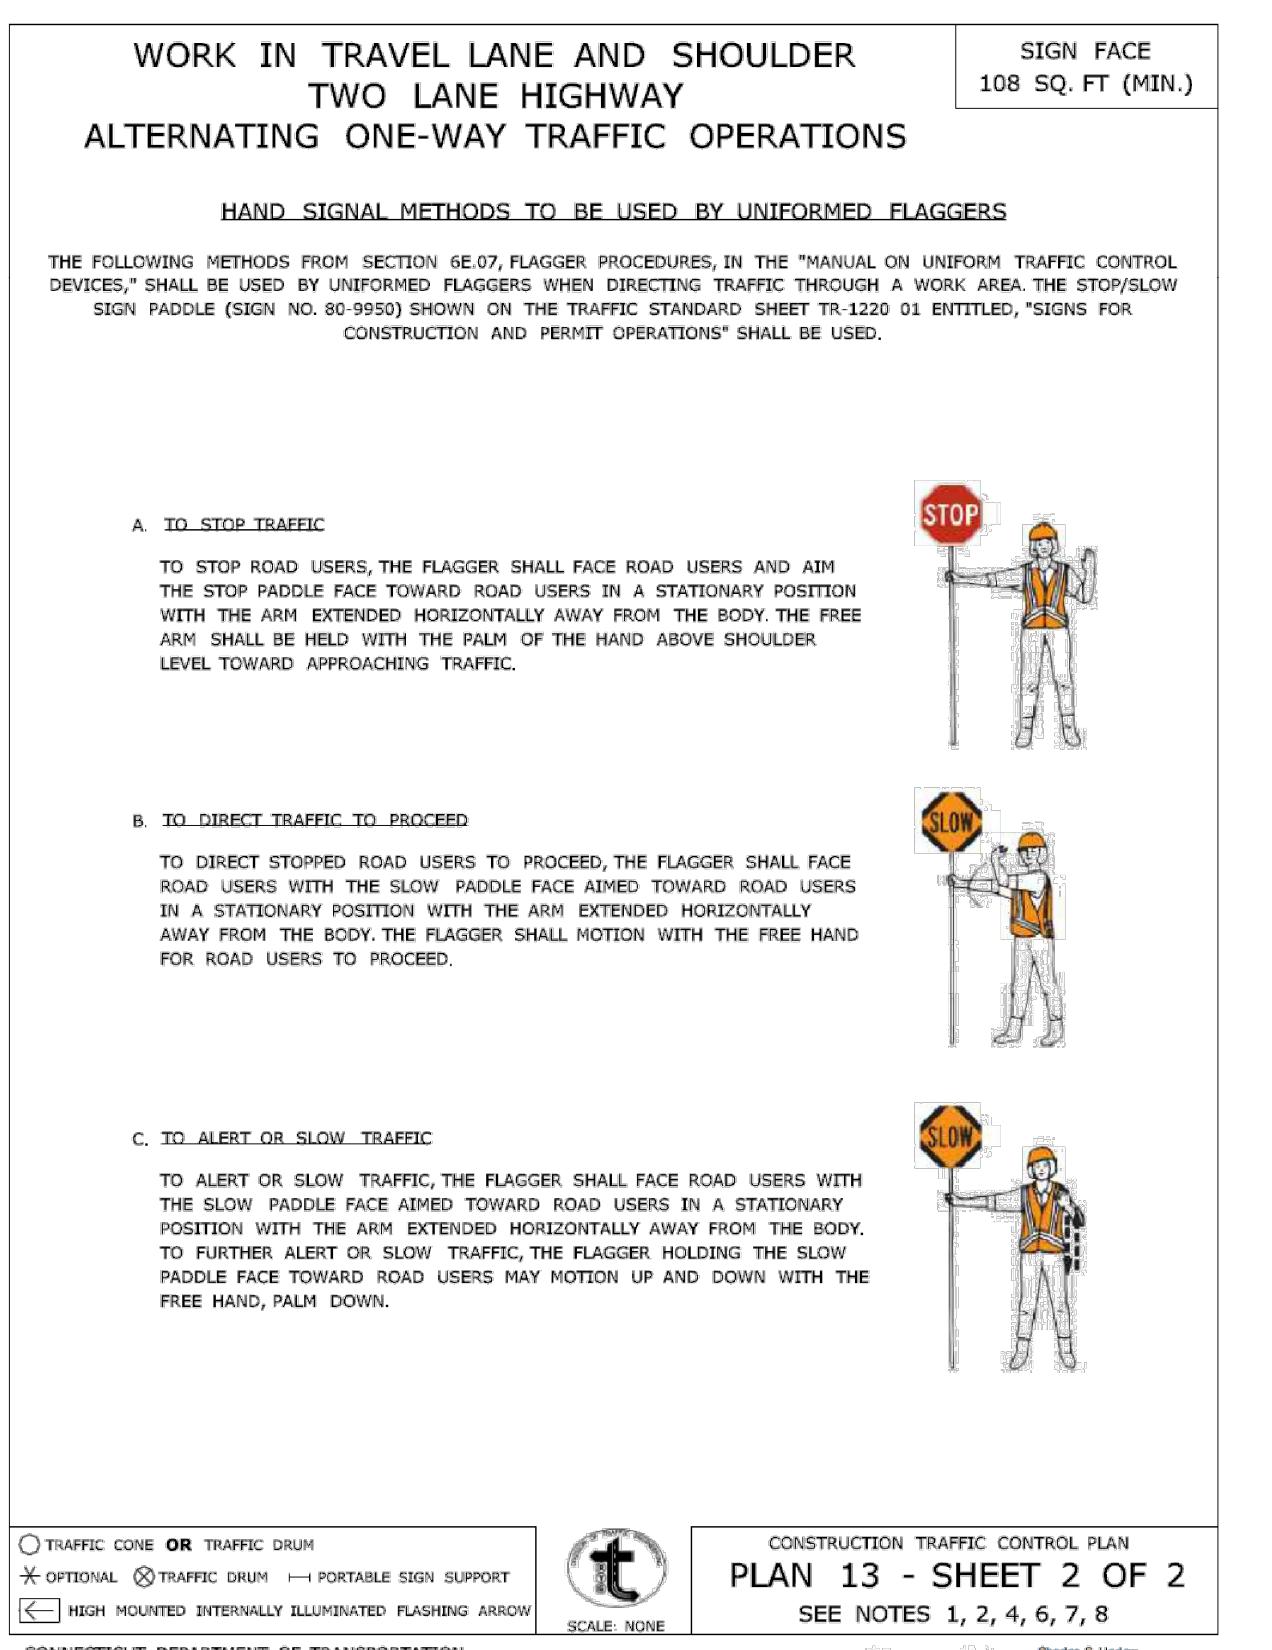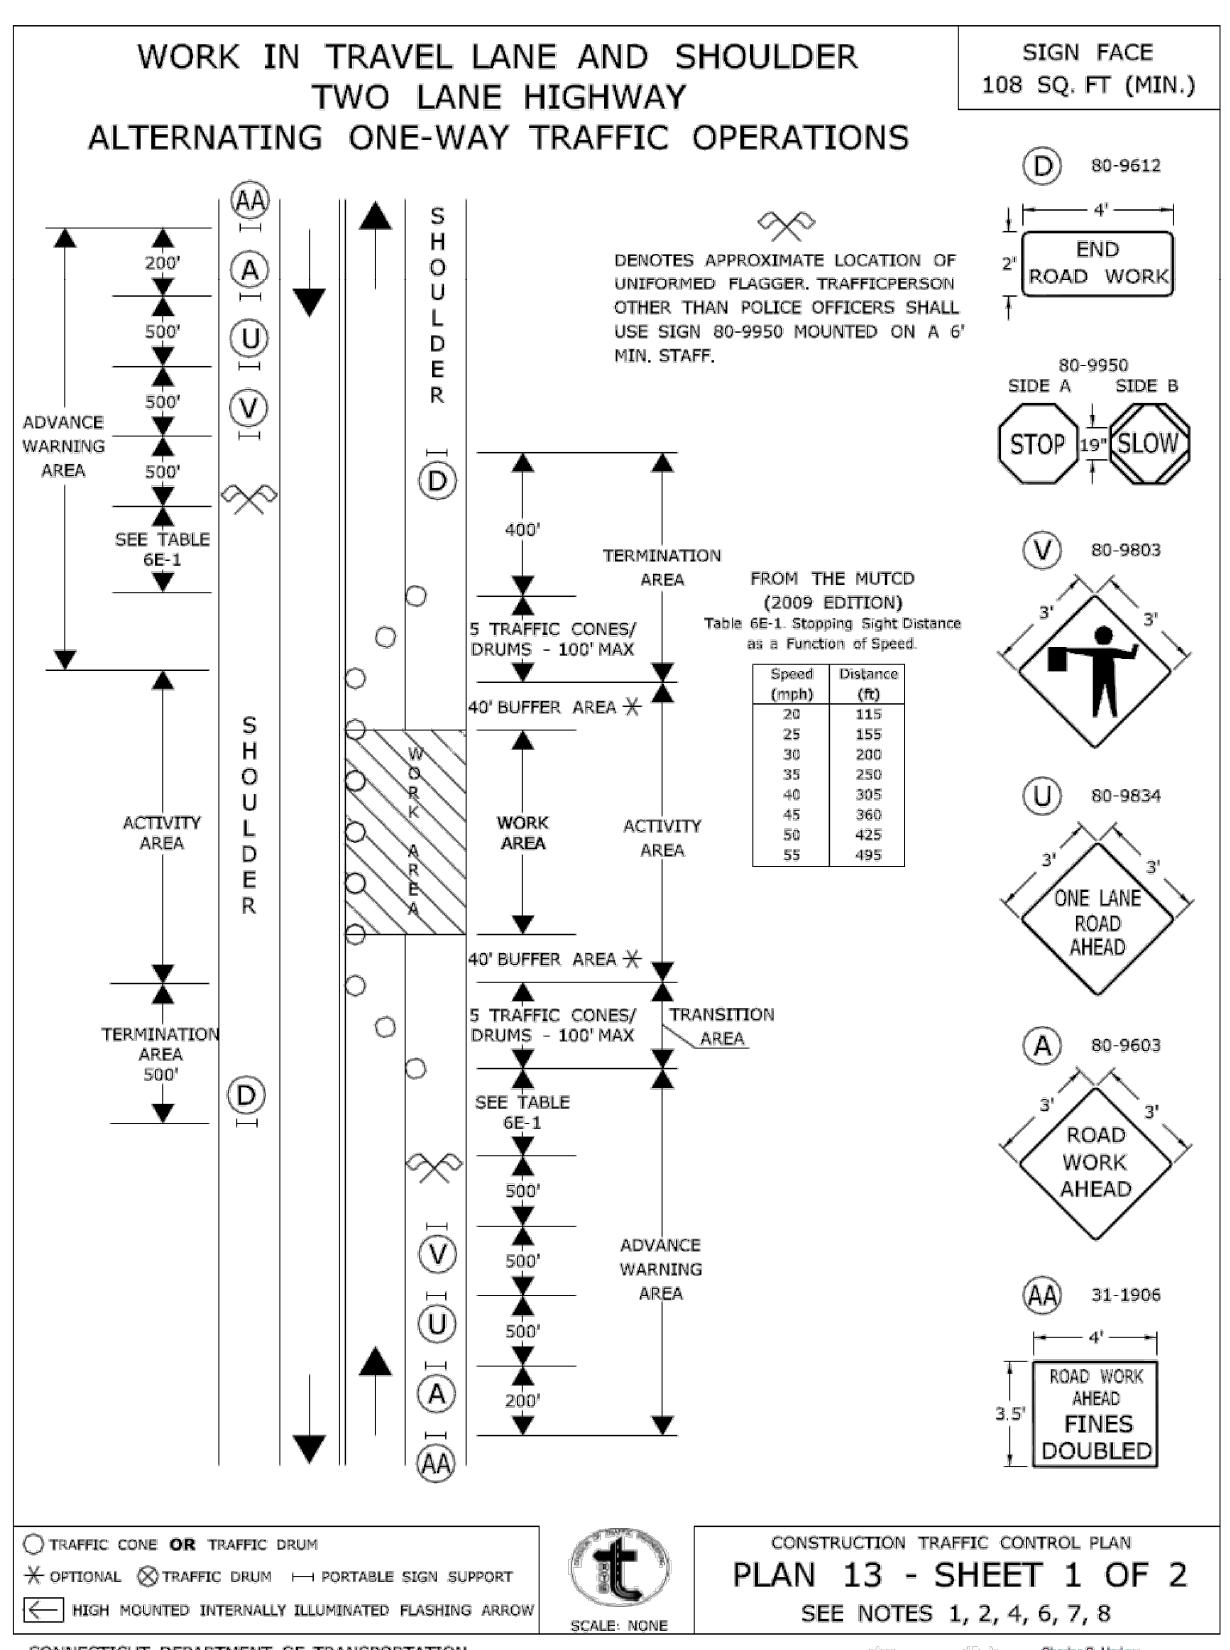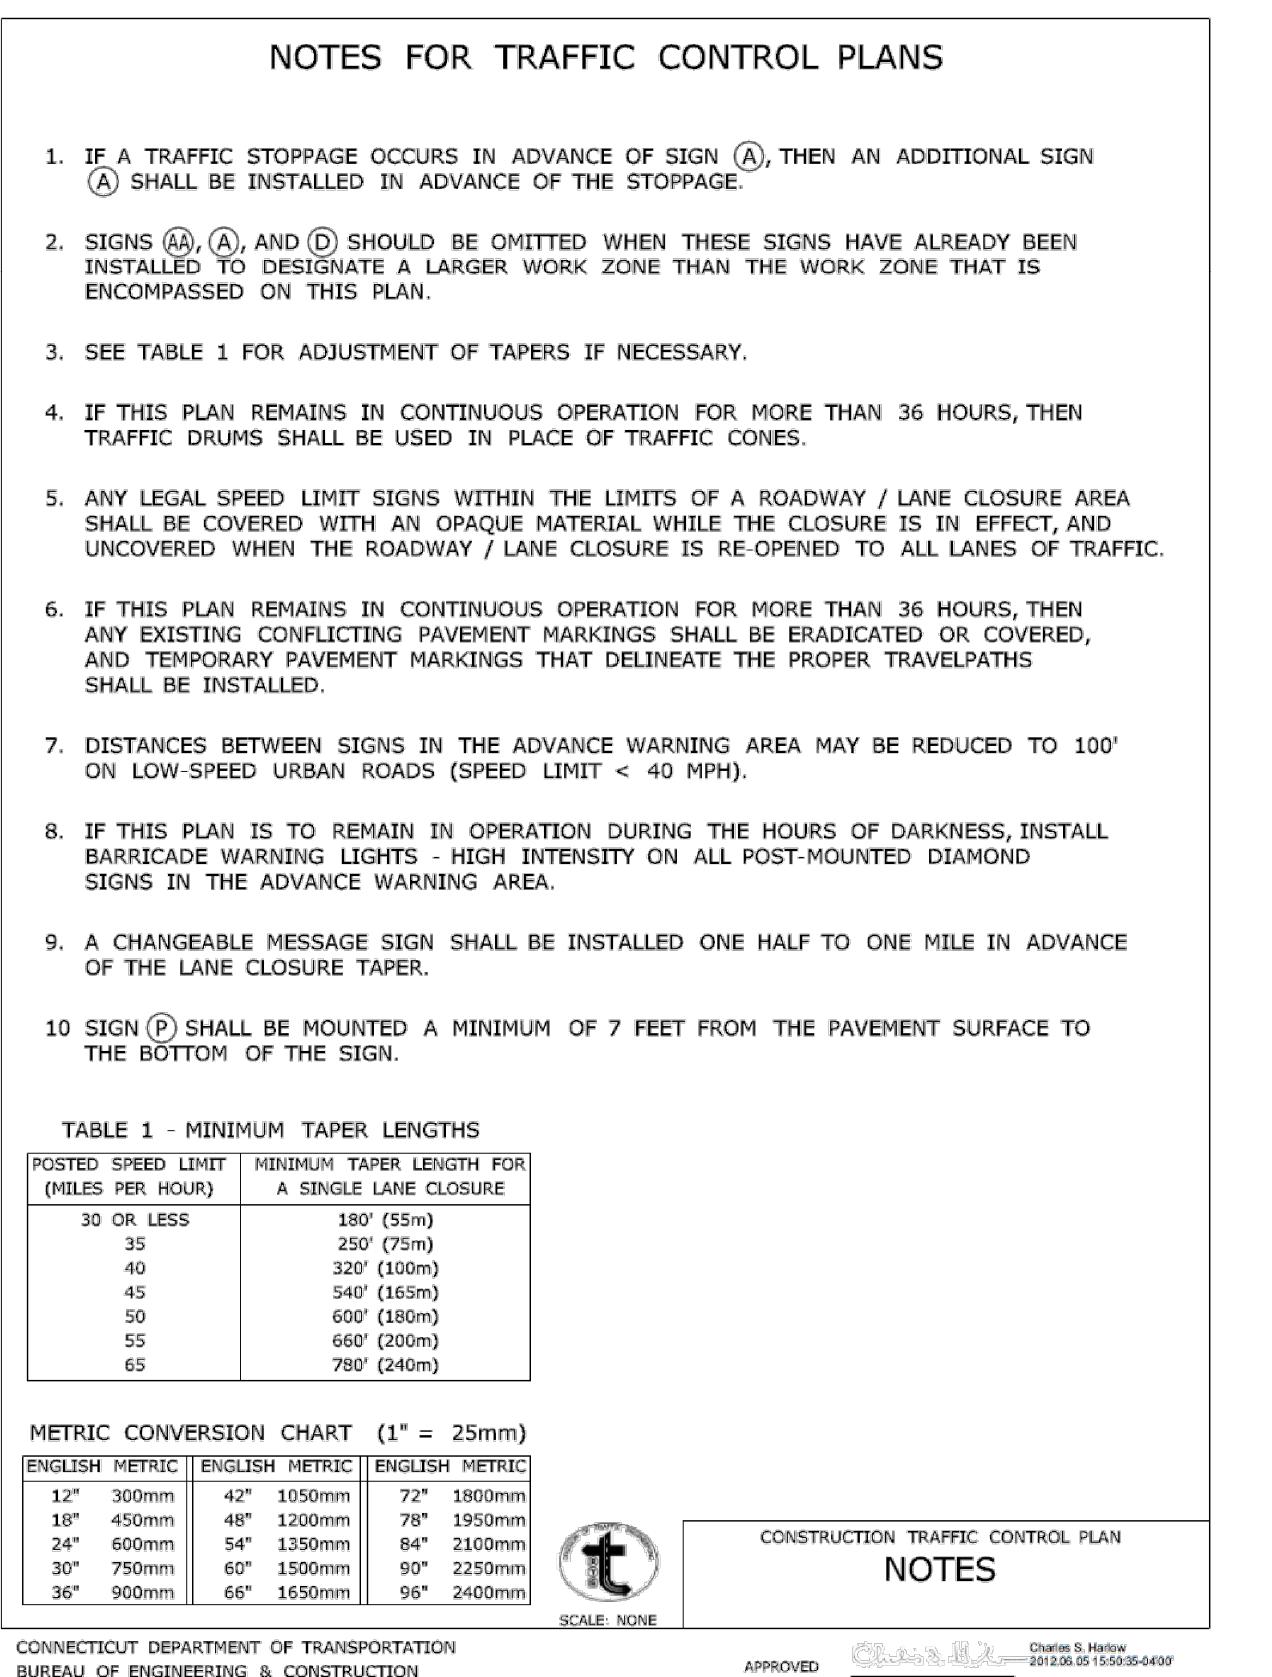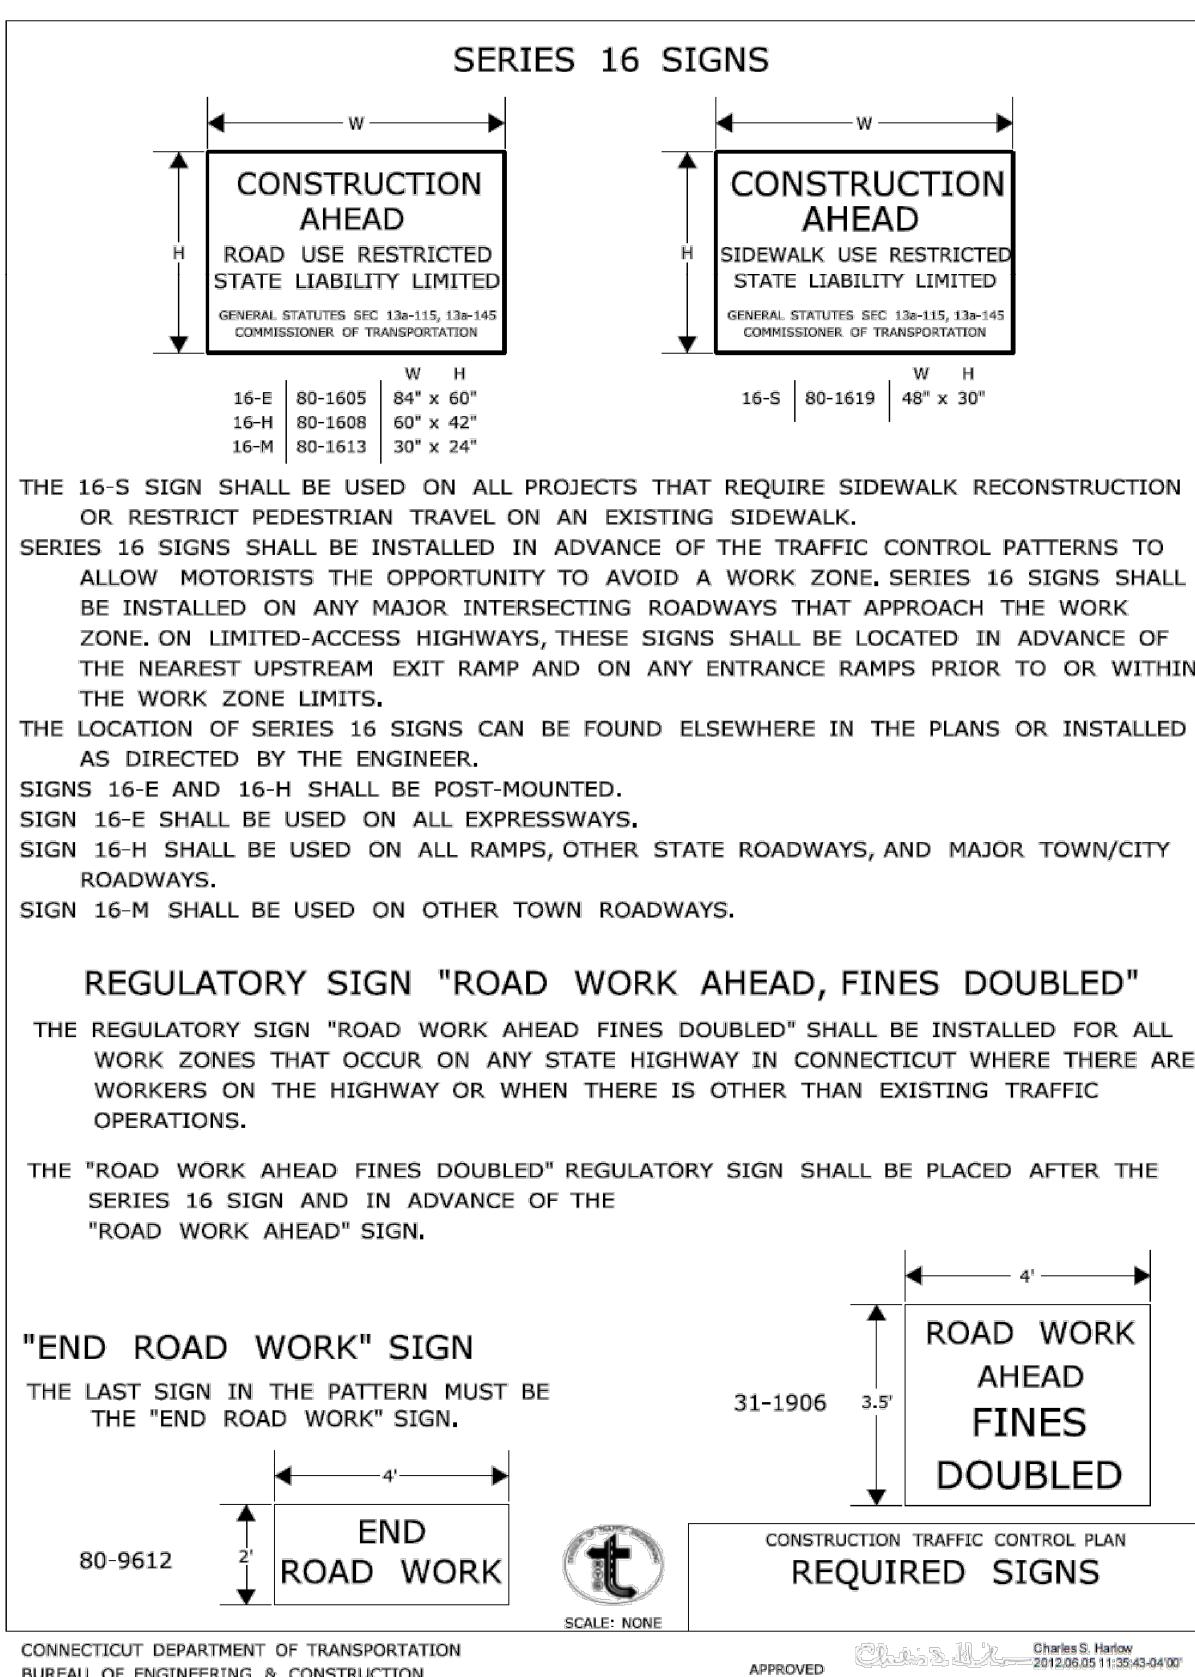

Town of Trumbull

Whitney Avenue at Main Street Intersection Improvements


Trumbull, CT

MARK	DATE	DESCRIPTION
4	11/29/2018	TOWN COMMENTS
3	8/30/2018	CTDOT COMMENTS
2	8/15/2018	CTDOT COMMENTS
1	7/2/2018	CTDOT & TOWN COMMENTS
MARK	DATE	DESCRIPTION
PROJECT NO:	T0196-116	
DATE:	08/15/2018	
FILE:	T0196-116-6-MPT.dwg	
DRAWN BY:	ALW	
CHECKED:	COG	
APPROVED:	DCH	


Maintenance and Protection of Traffic Details

SCALE: NO SCALE


SHEET 6

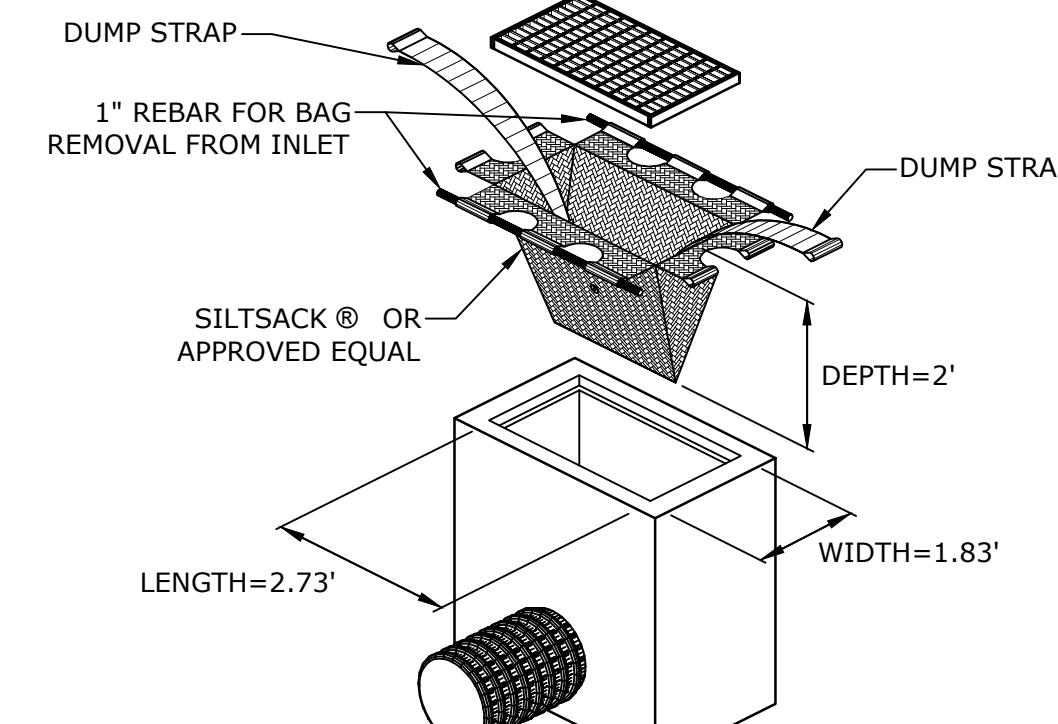


SILTSACK®
NO SCALE

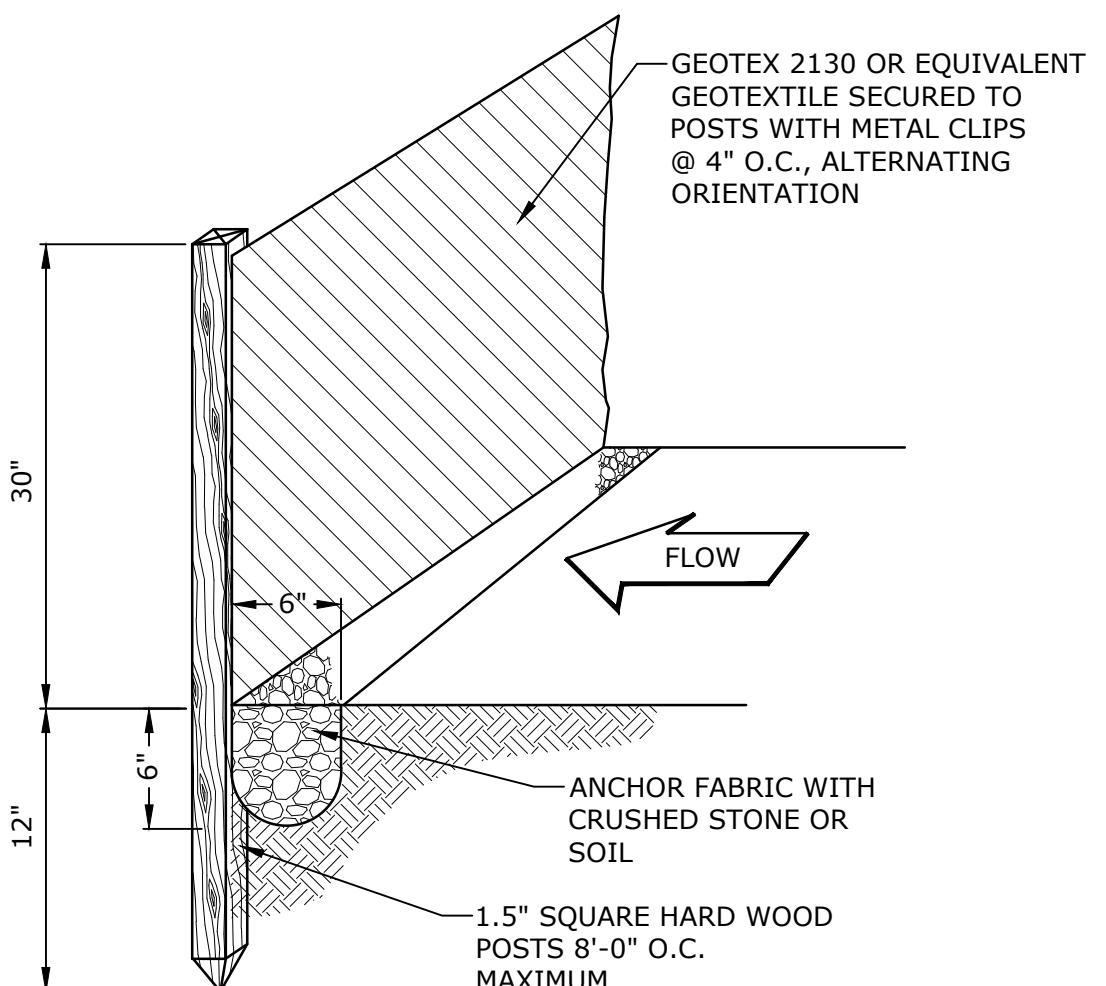

SILT FENCE
NO SCALE

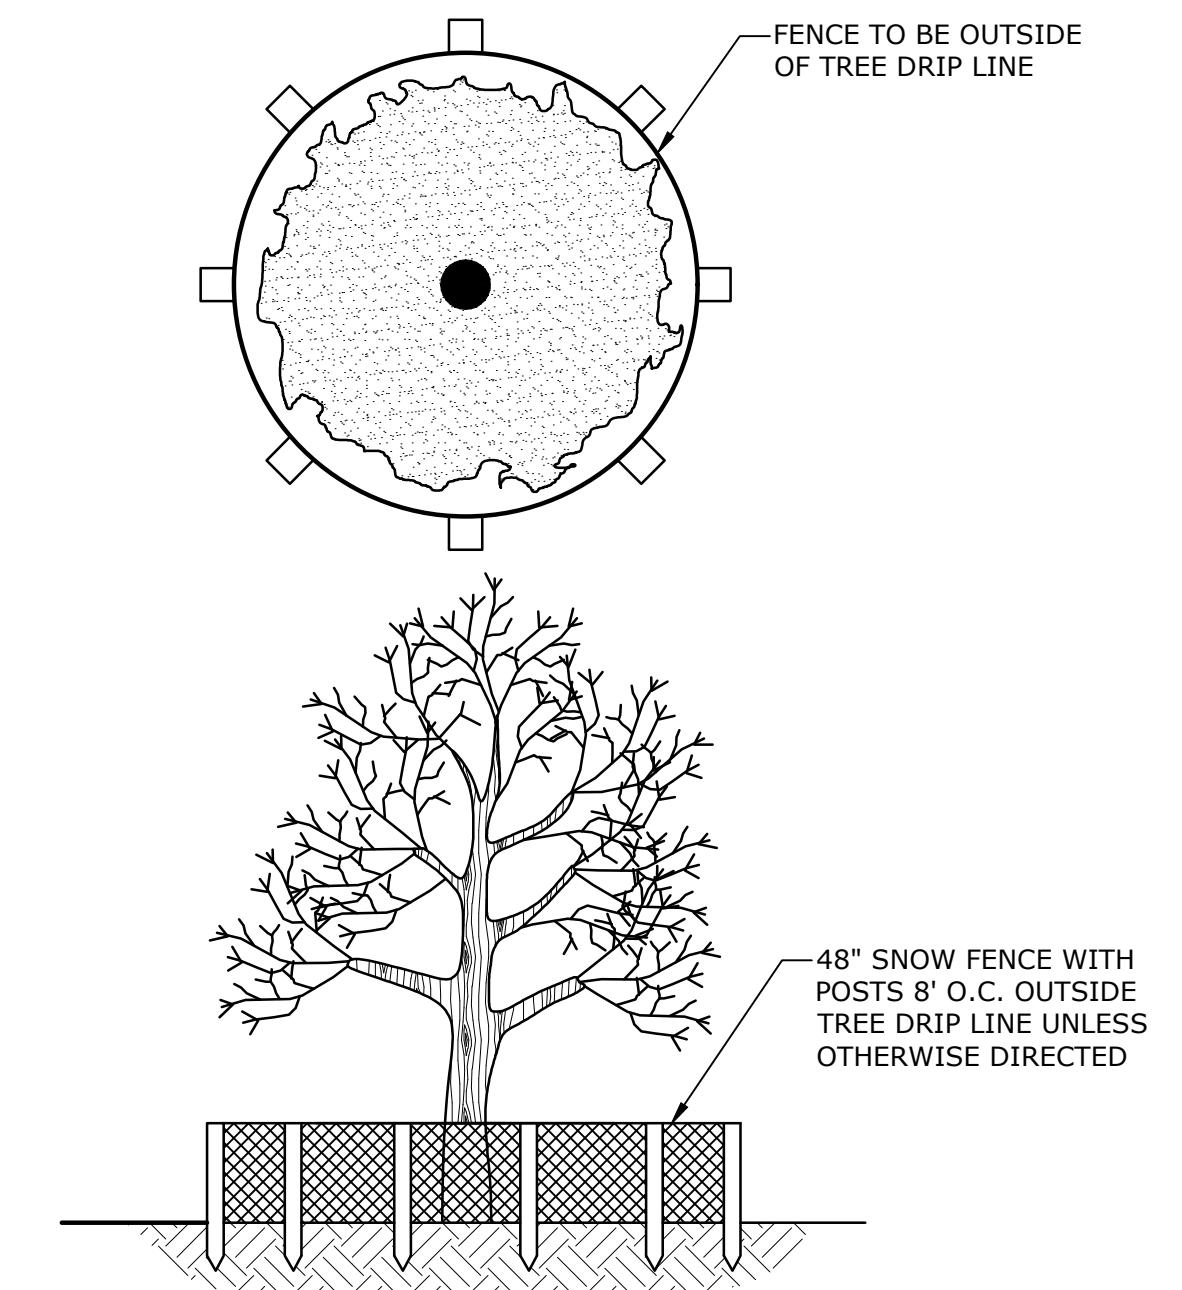


TREE PROTECTION
NO SCALE

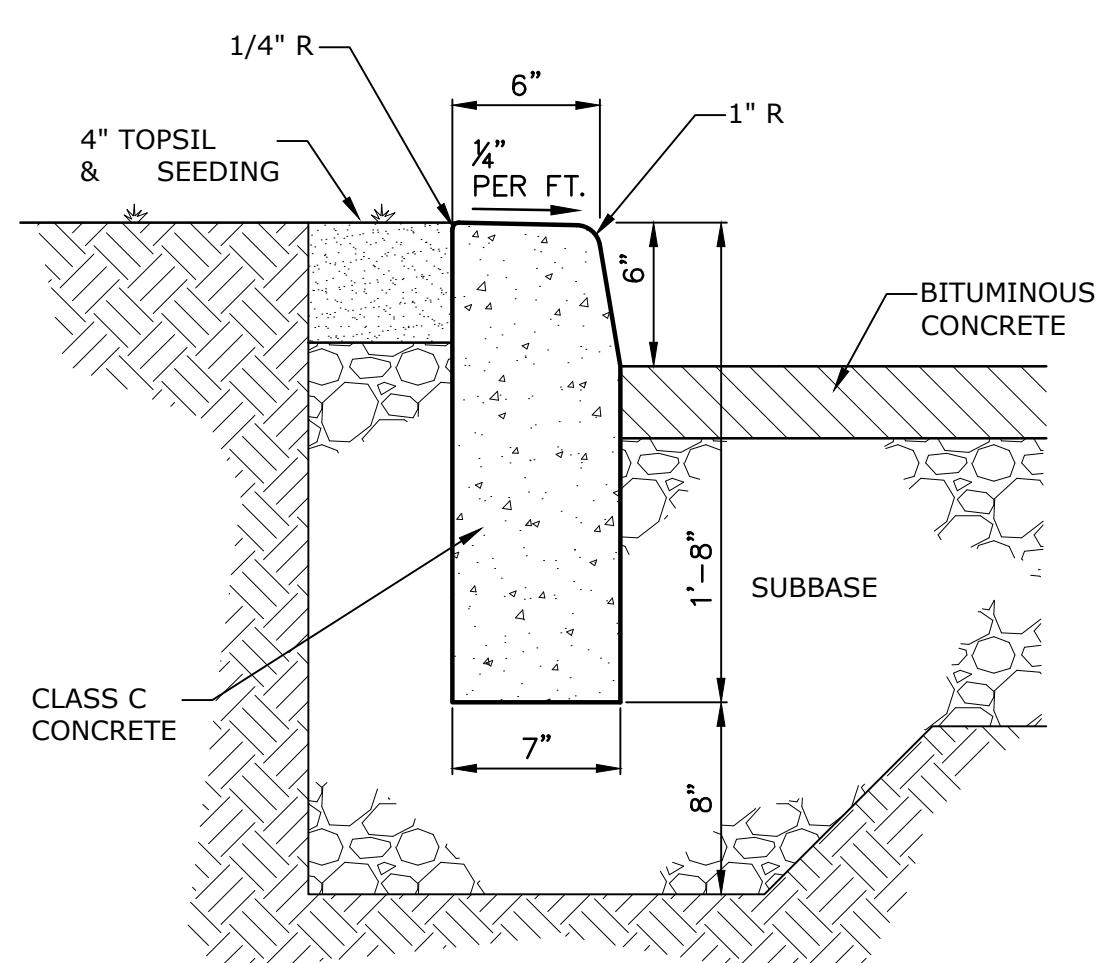


NOTES:
1. CONSTRUCT CURBING IN SECTIONS NOT TO EXCEED 10 FEET IN LENGTH, SUCH THAT THE CURBING JOINTS ALIGN WITH JOINTS IN THE CONCRETE PAVEMENT SLAB. NO SECTION SHALL BE LESS THAN 6 FEET IN LENGTH.

CONCRETE CURB ADJACENT TO GRASS
NO SCALE

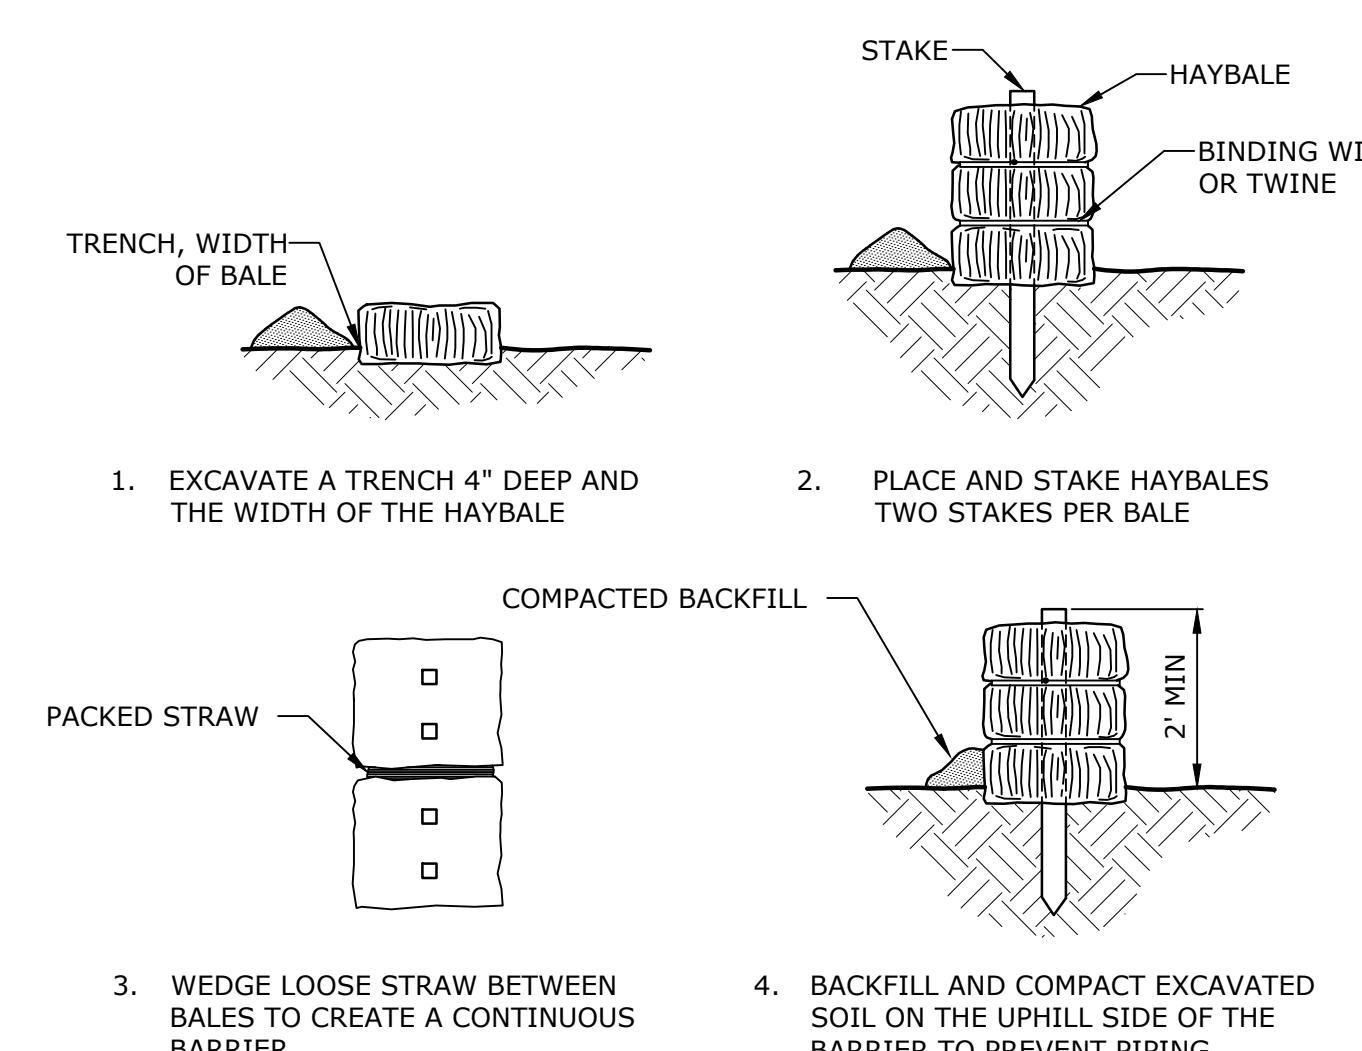

PLACEMENT AND CONSTRUCTION
OF HAYBALE BARRIER
NO SCALE

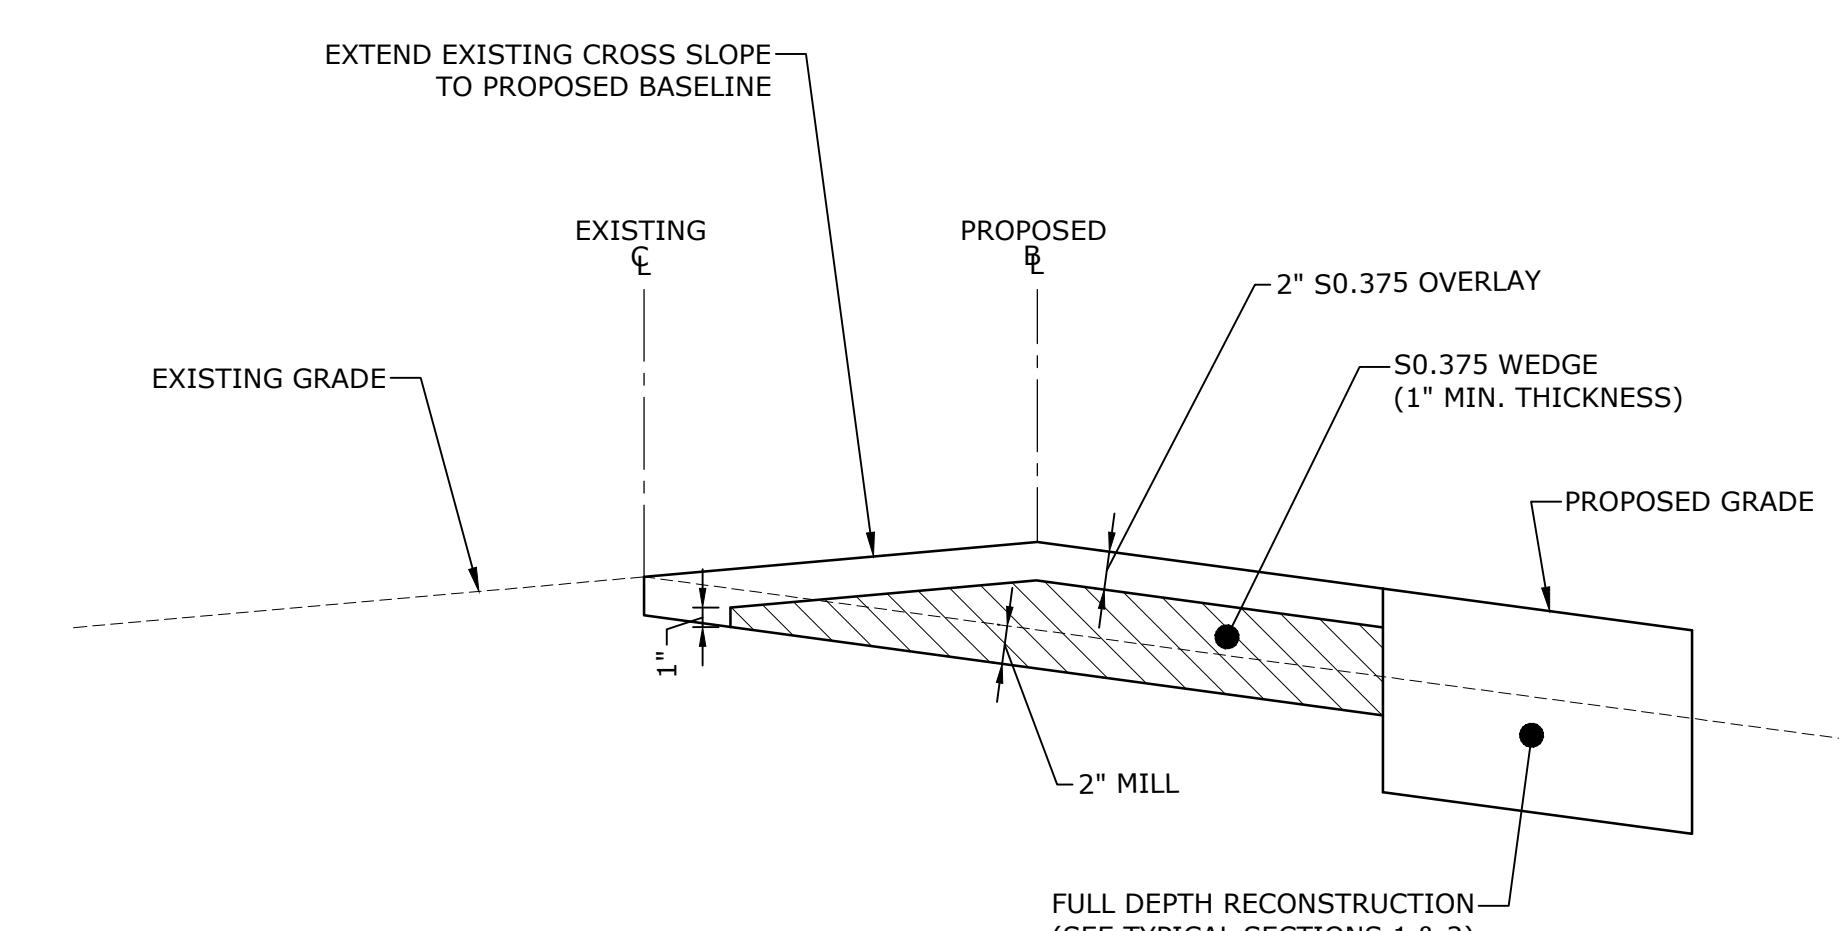

PAVEMENT WEDGE
NO SCALE

Town of Trumbull

Whitney Avenue at Main Street Intersection Improvements Trumbull, CT




MARK	DATE	DESCRIPTION
4	11/29/2018	TOWN COMMENTS
3	8/30/2018	CTDOT COMMENTS
2	8/15/2018	CTDOT COMMENTS
1	7/2/2018	CTDOT & TOWN COMMENTS

PROJECT NO:	T0196-116
DATE:	08/15/2018
FILE:	T0196-116-7-DS.dwg
DRAWN BY:	ALW
CHECKED:	COG
APPROVED:	DCH

DETAIL SHEET

SCALE: NO SCALE

SHEET 7

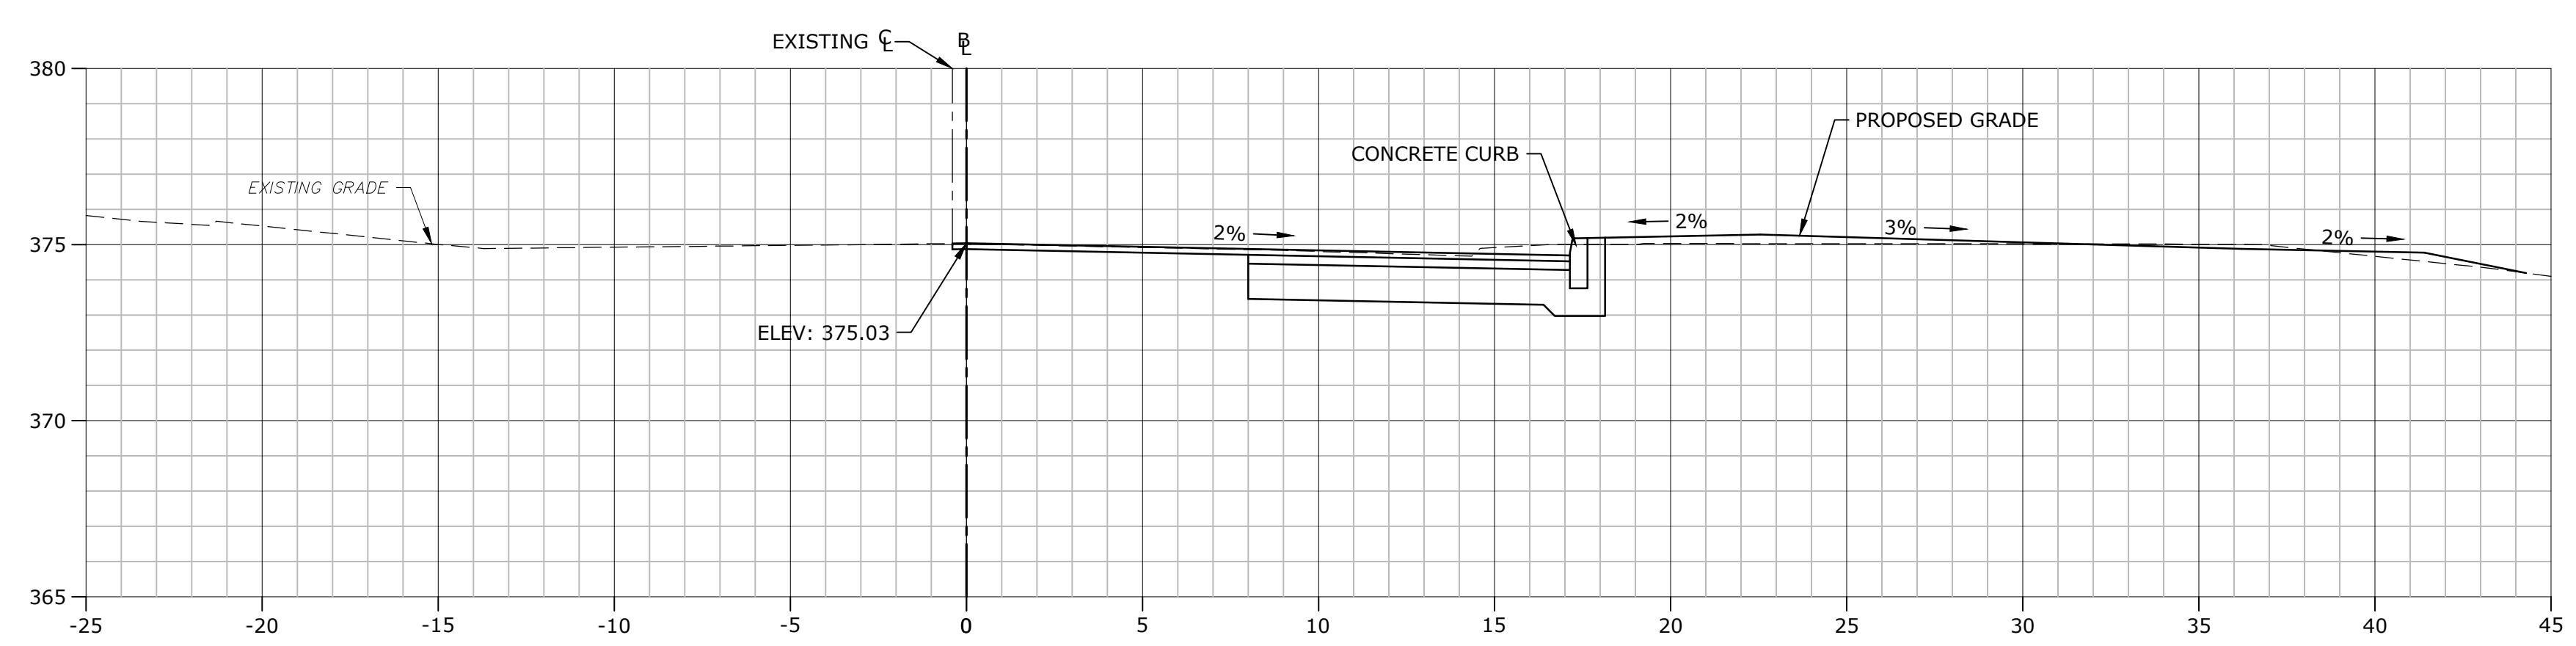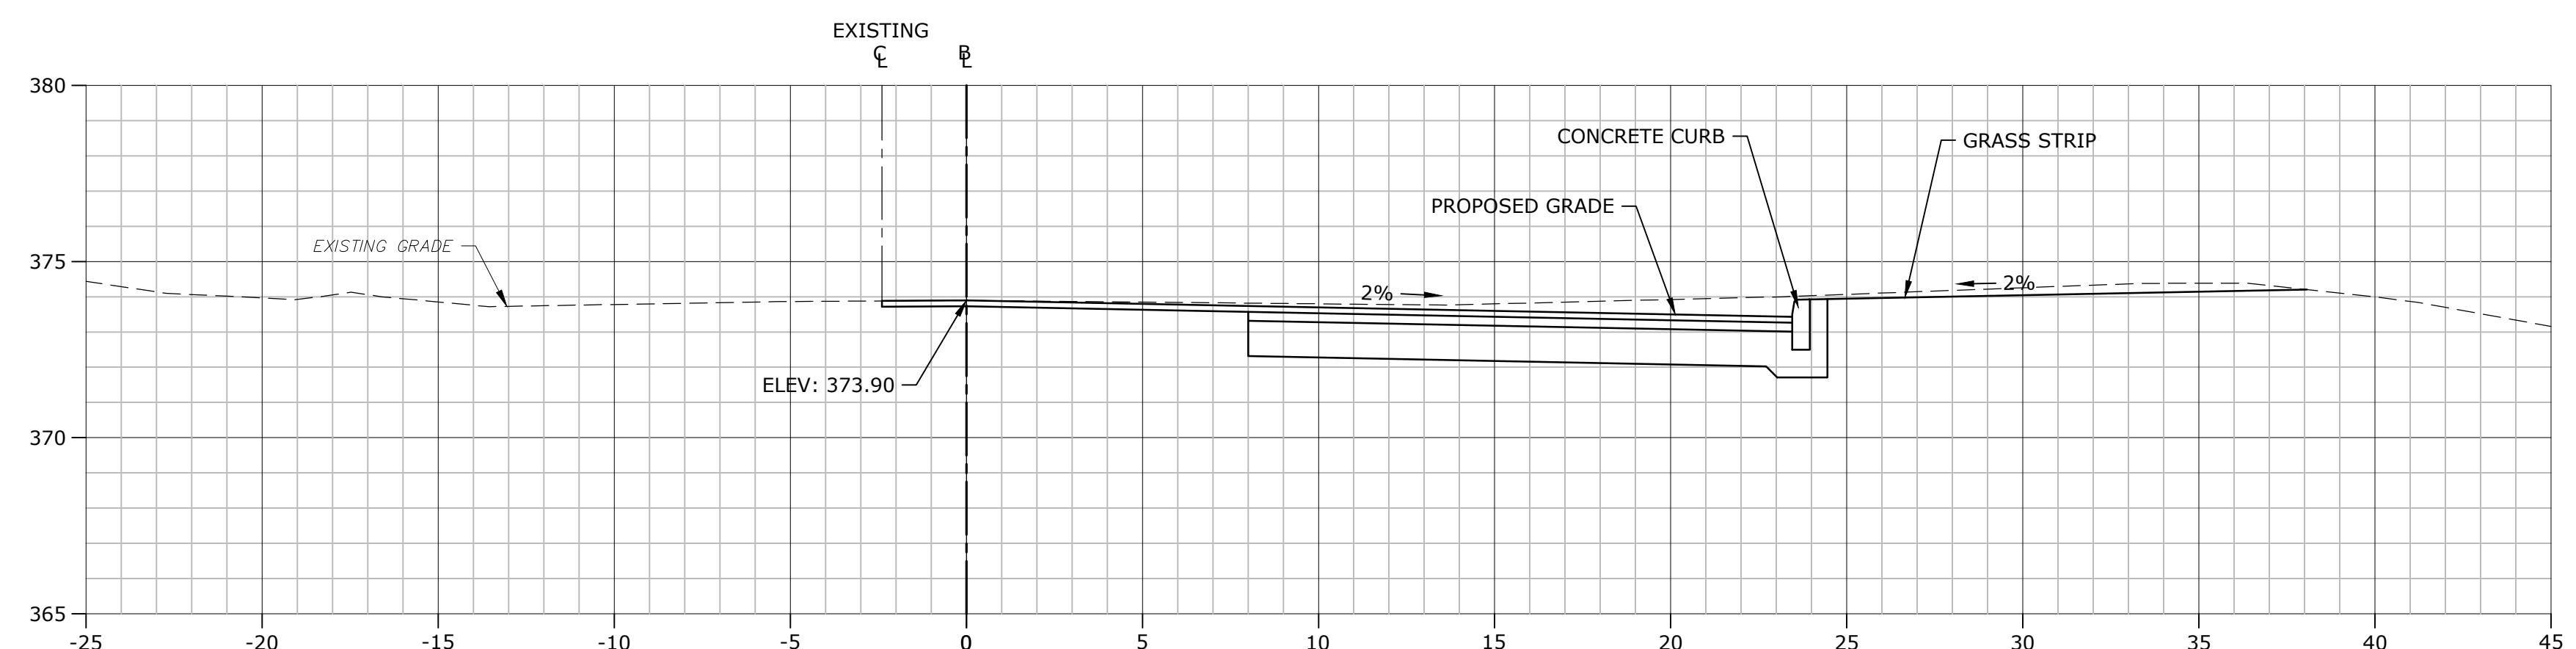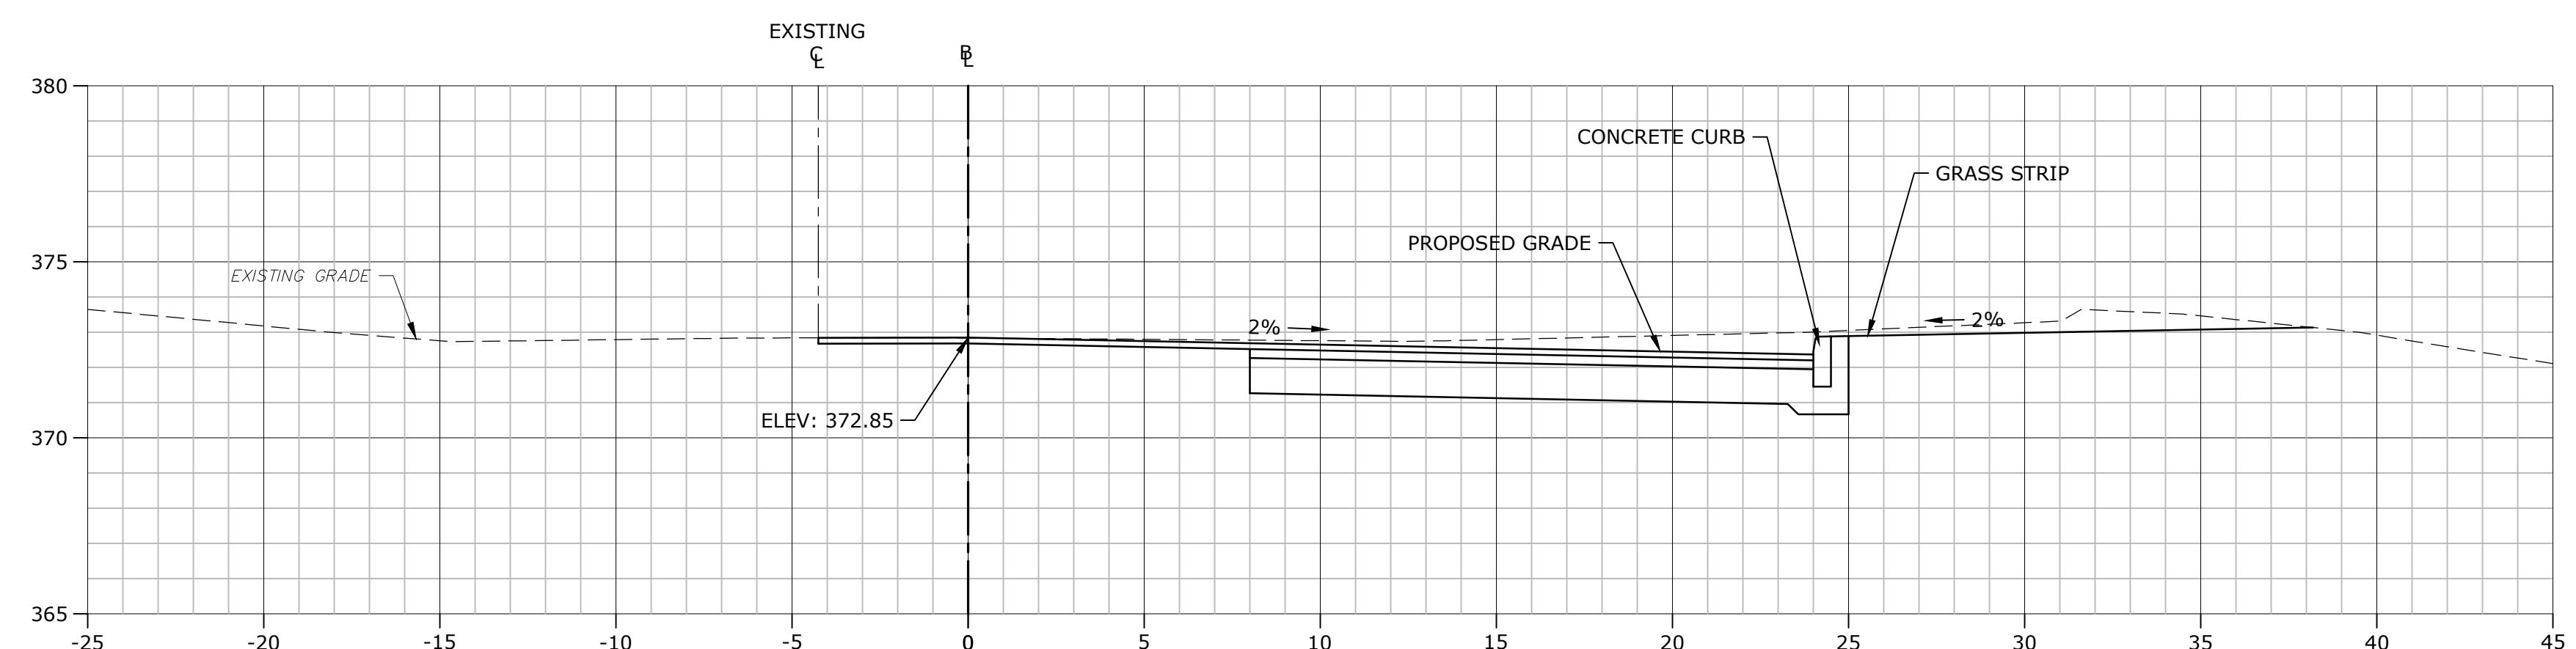

**Town of
Trumbull**

Whitney Avenue
at Main Street
Intersection
Improvements
Trumbull, CT


MARK	DATE	DESCRIPTION
4	11/29/2018	TOWN COMMENTS
3	8/30/2018	CTDOT COMMENTS
2	8/15/2018	CTDOT COMMENTS
1	7/2/2018	CTDOT & TOWN COMMENTS

PROJECT NO: T0196-116
DATE: 08/15/2018
FILE: T0196-116-889-YS.dwg
DRAWN BY: ALW
CHECKED: COG
APPROVED: DCH

CROSS SECTIONS
STA 0+50 TO 1+00

SCALE: 1" = 4'


SHEET 8

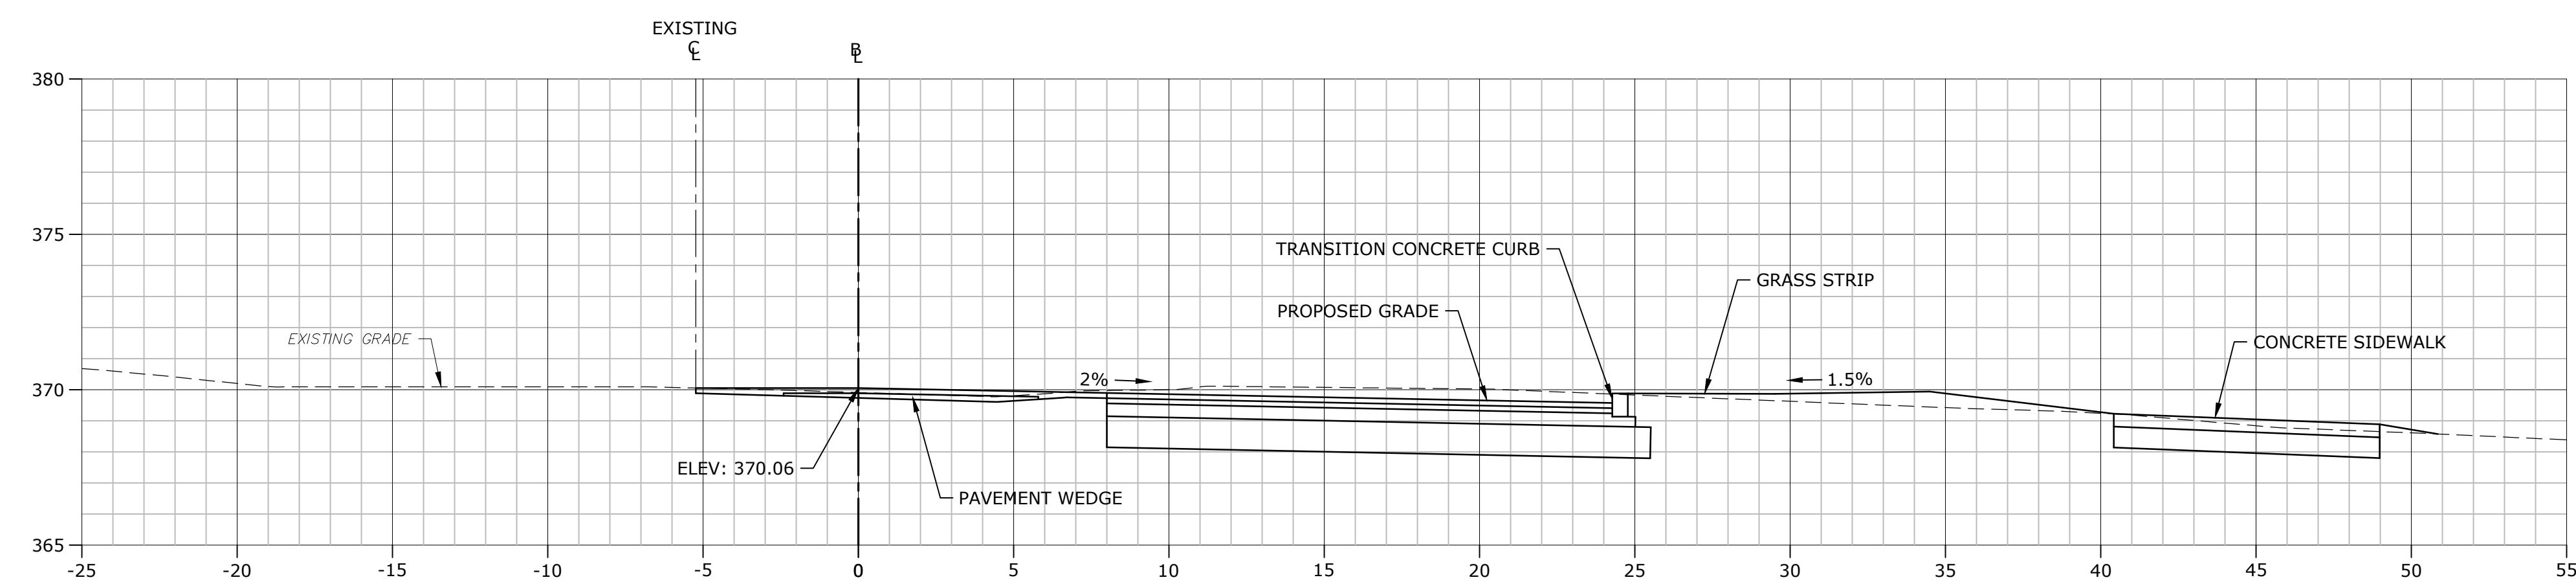

STATION: 1+75



STATION: 1+50

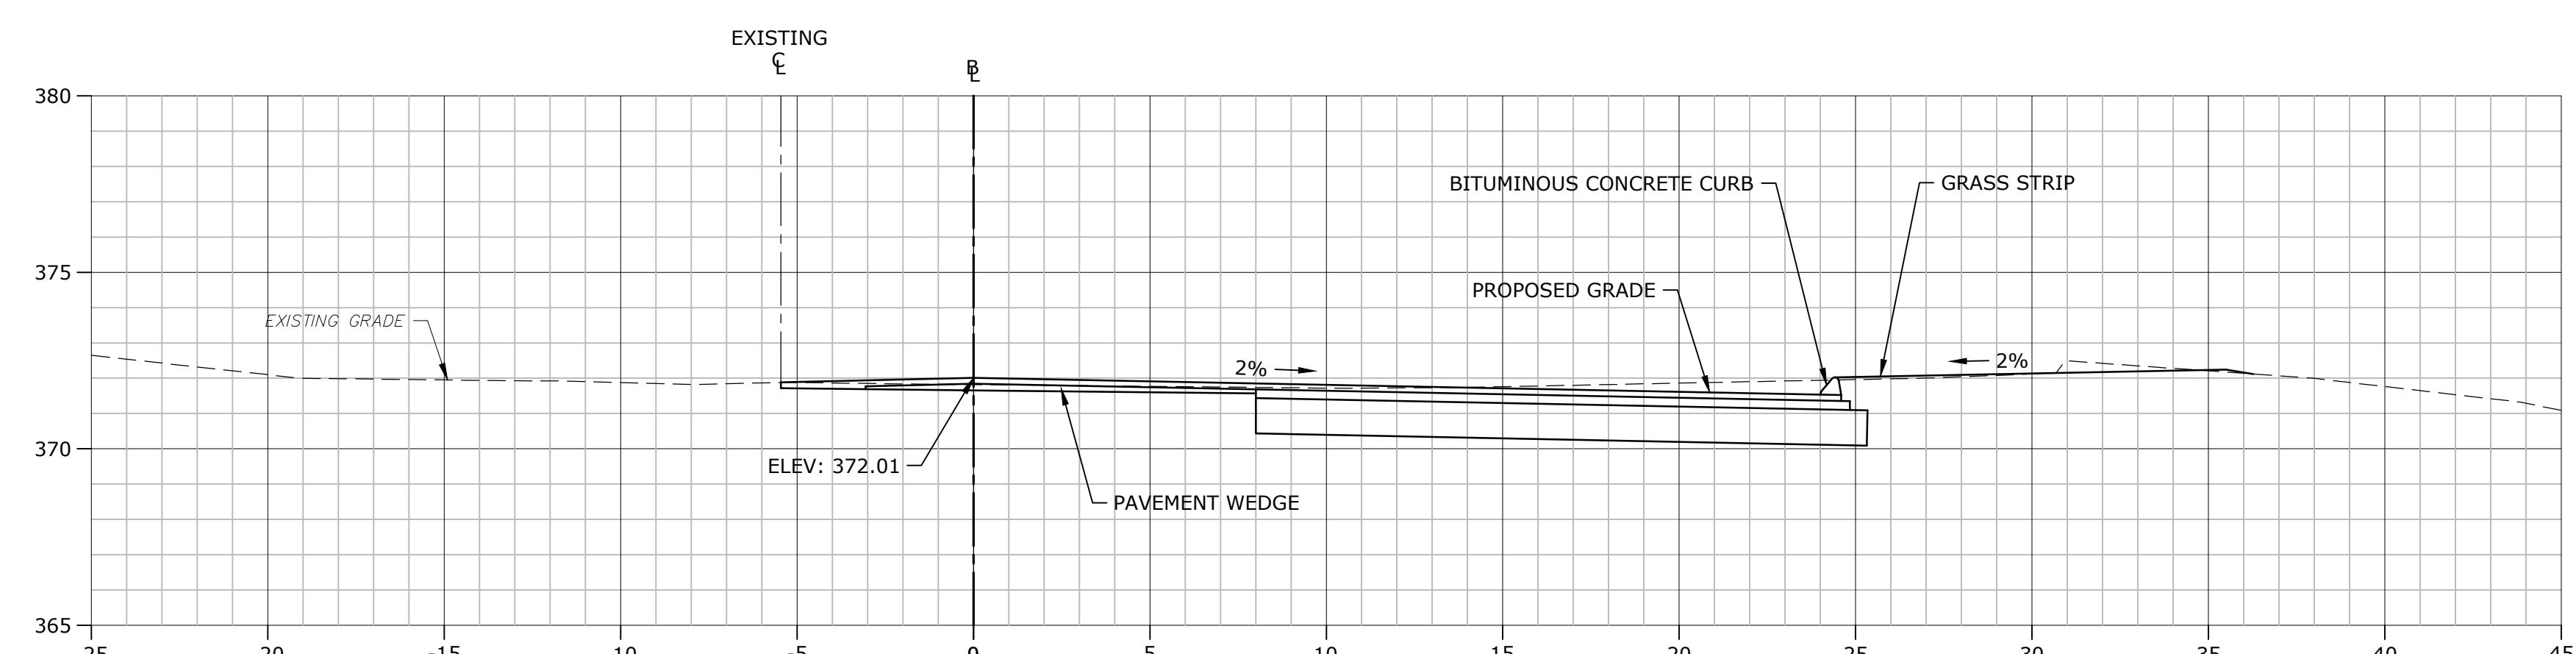

STATION: 1+25

**Town of
Trumbull**

Whitney Avenue
at Main Street
Intersection
Improvements
Trumbull, CT

MARK	DATE	DESCRIPTION
4	11/29/2018	TOWN COMMENTS
3	8/30/2018	CTDOT COMMENTS
2	8/15/2018	CTDOT COMMENTS
1	7/2/2018	CTDOT & TOWN COMMENTS

PROJECT NO: T0196-116
DATE: 08/15/2018
FILE: T0196-116-889-YS.dwg
DRAWN BY: ALW
CHECKED: COG
APPROVED: DCH

CROSS SECTIONS
STA 1+25 TO 1+75

SCALE: 1" = 4'

SHEET 9



**Town of
Trumbull**

Whitney Avenue
at Main Street
Intersection
Improvements

Trumbull, CT


MARK	DATE	DESCRIPTION
4	11/29/2018	TOWN COMMENTS
3	8/30/2018	CTDOT COMMENTS
2	8/15/2018	CTDOT COMMENTS
1	7/2/2018	CTDOT & TOWN COMMENTS

PROJECT NO:	T0196-116
DATE:	08/15/2018
FILE:	T0196-116-10-TUR.dwg
DRAWN BY:	ALW
CHECKED:	COG
APPROVED:	DCH


TRUCK TURN MOVEMENTS

SCALE: 1" = 20'


SHEET 10

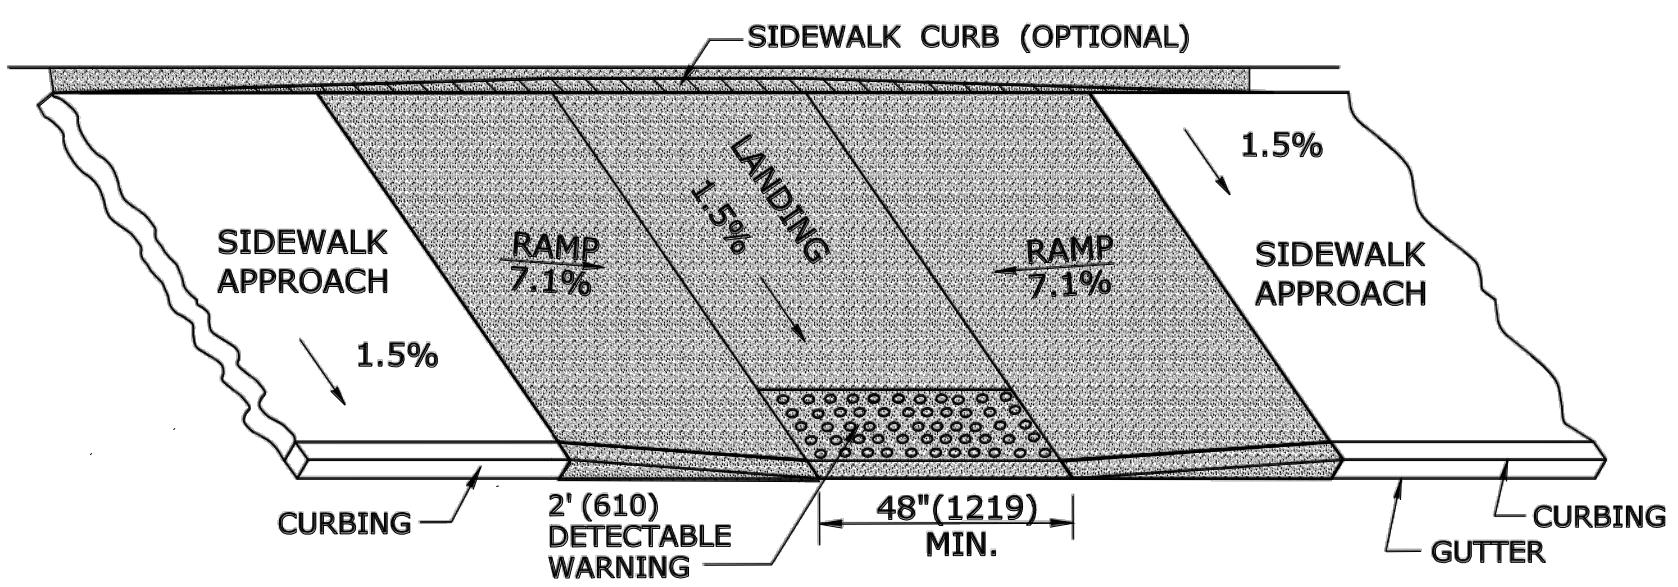


PARALLEL SIDEWALK RAMP (TYPE 1) NO UTILITY STRIP

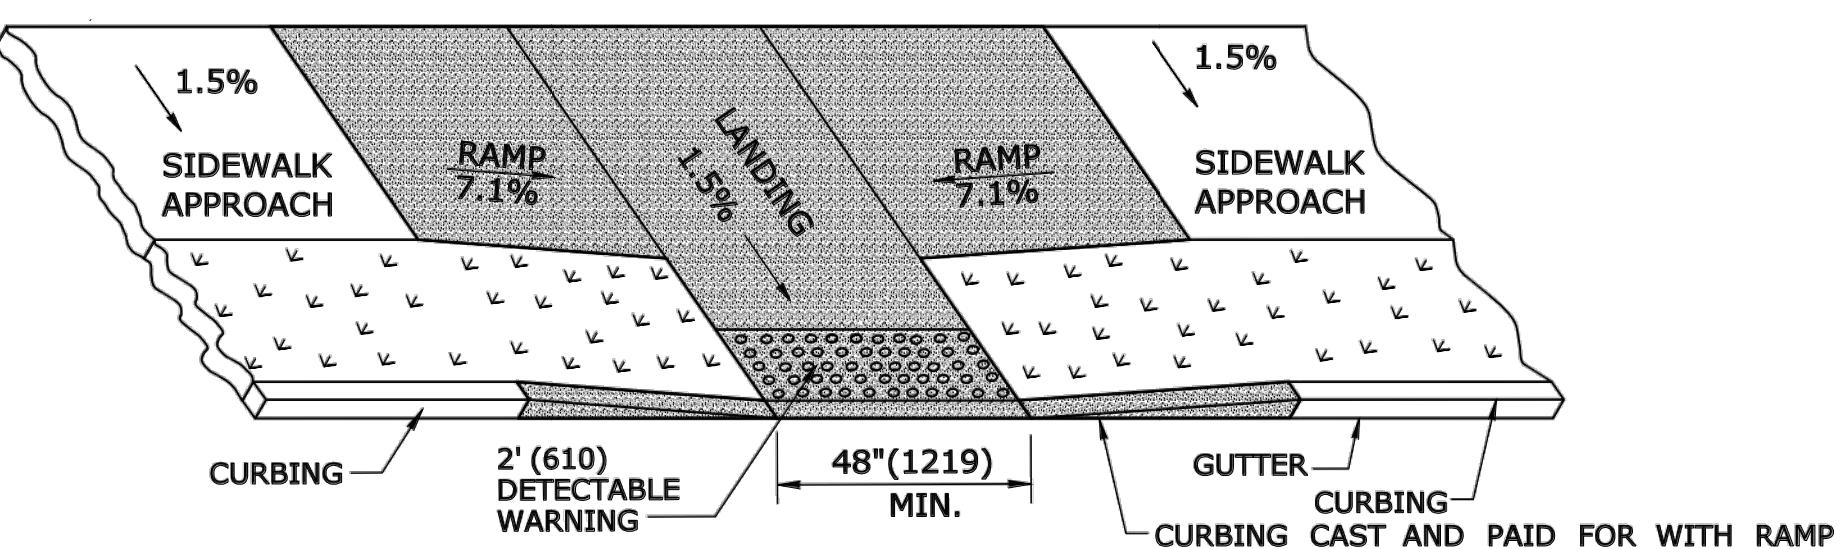


**PARALLEL SIDEWALK RAMP (TYPE 1a)
WITH UTILITY / GRASS STRIP**

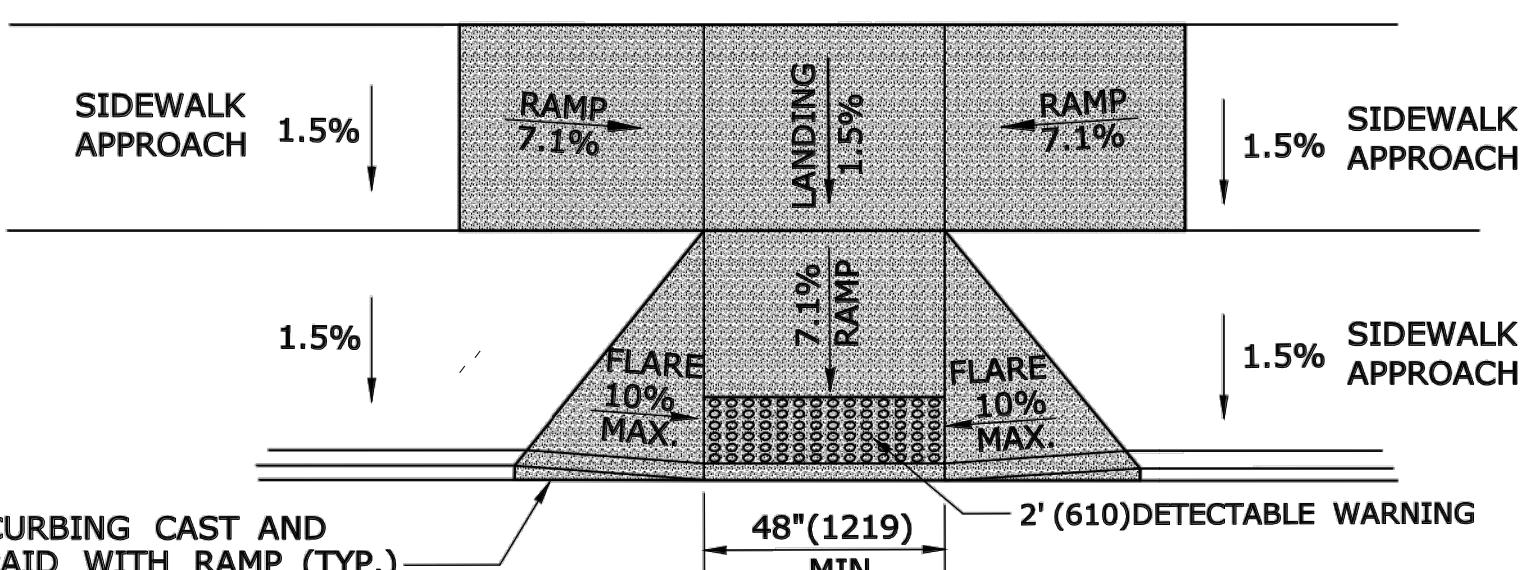


**PARALLEL/PERPENDICULAR SIDEWALK RAMP
NO UTILITY/GRASS STRIP (TYPE 1b)**

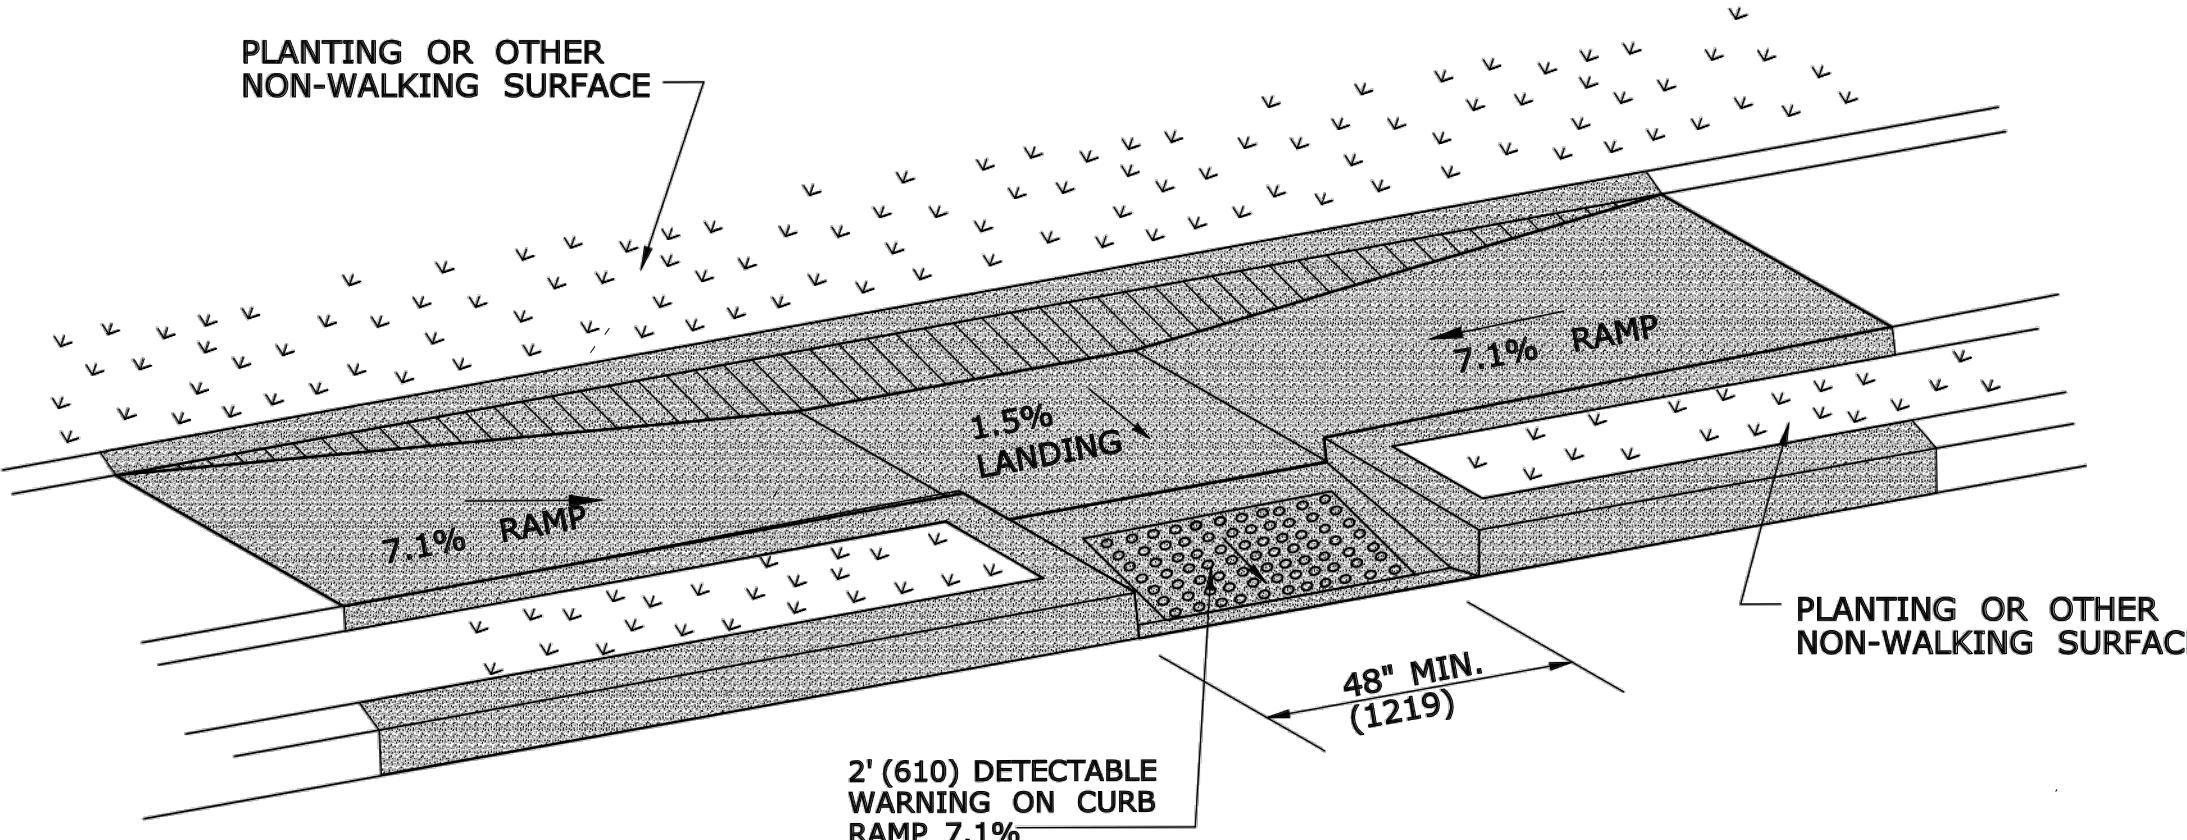

**PARALLEL SIDEWALK RAMP (TYPE 1c)
WITH UTILITY / GRASS STRIP**

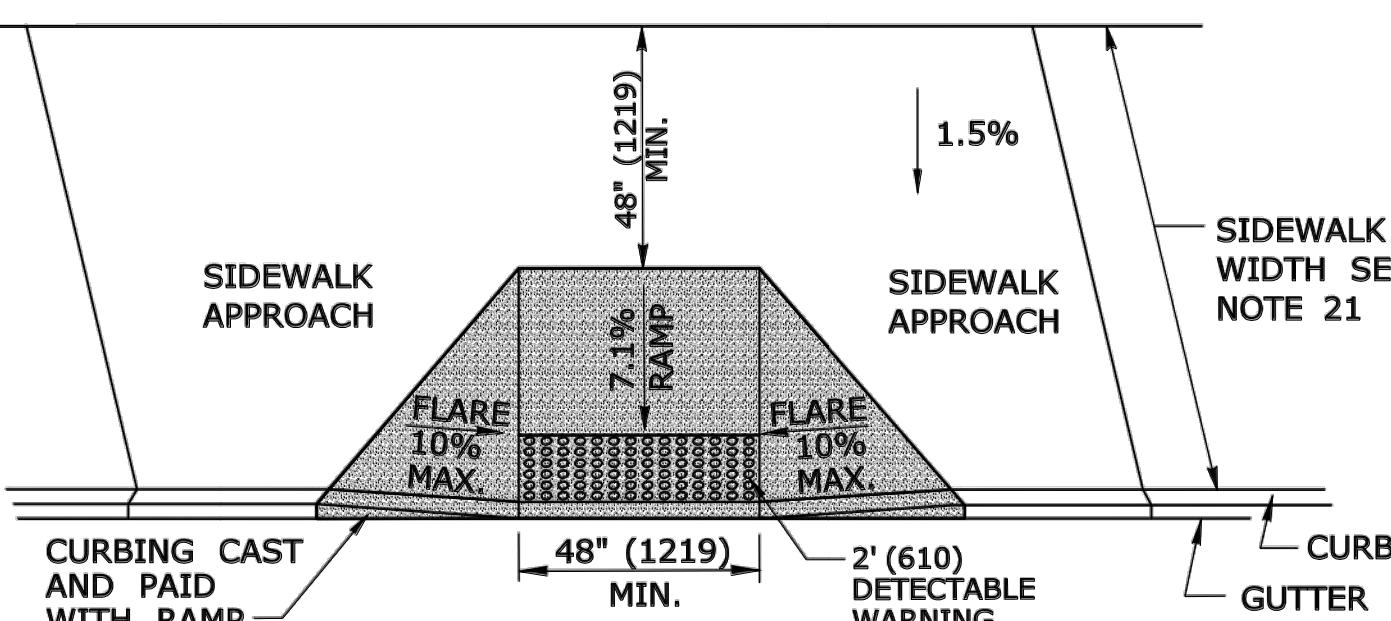


**PERPENDICULAR SIDEWALK RAMP
W/ 48" (1219) MIN. BY PASS LANDING (TYPE 2)**

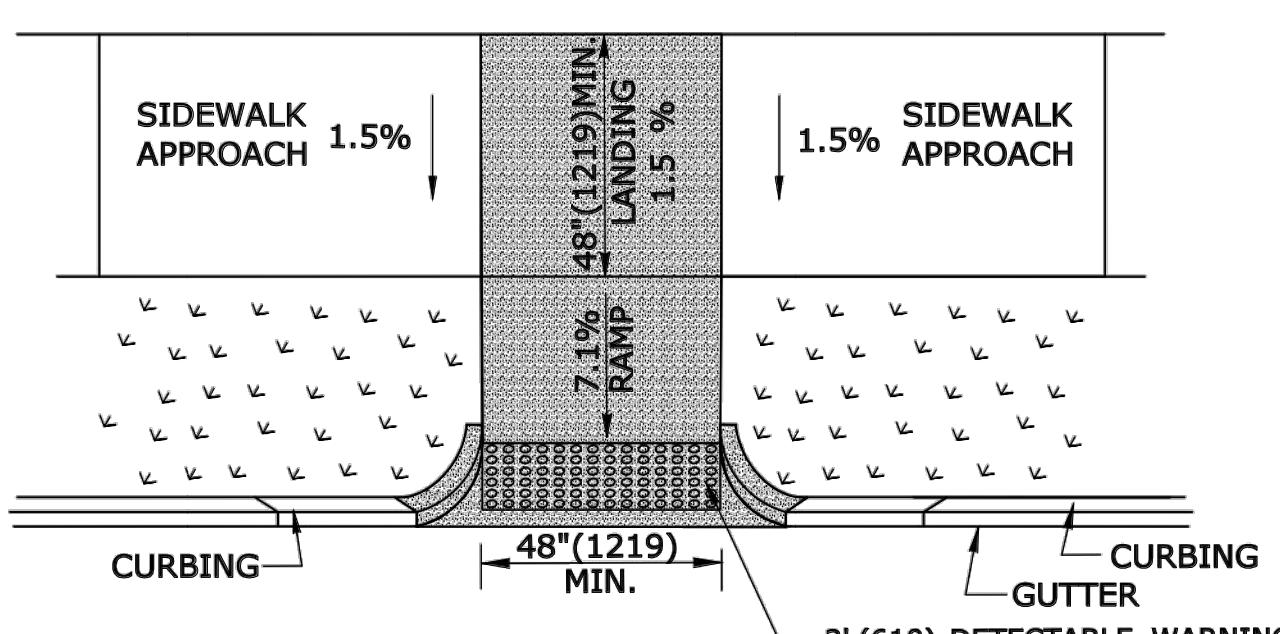

**PERPENDICULAR SIDEWALK RAMP
W/CURB RETURNS / UTILITY GRASS STRIP (TYPE 2a)**

* OPTIONAL FLARE ONE SIDE OF RAMP

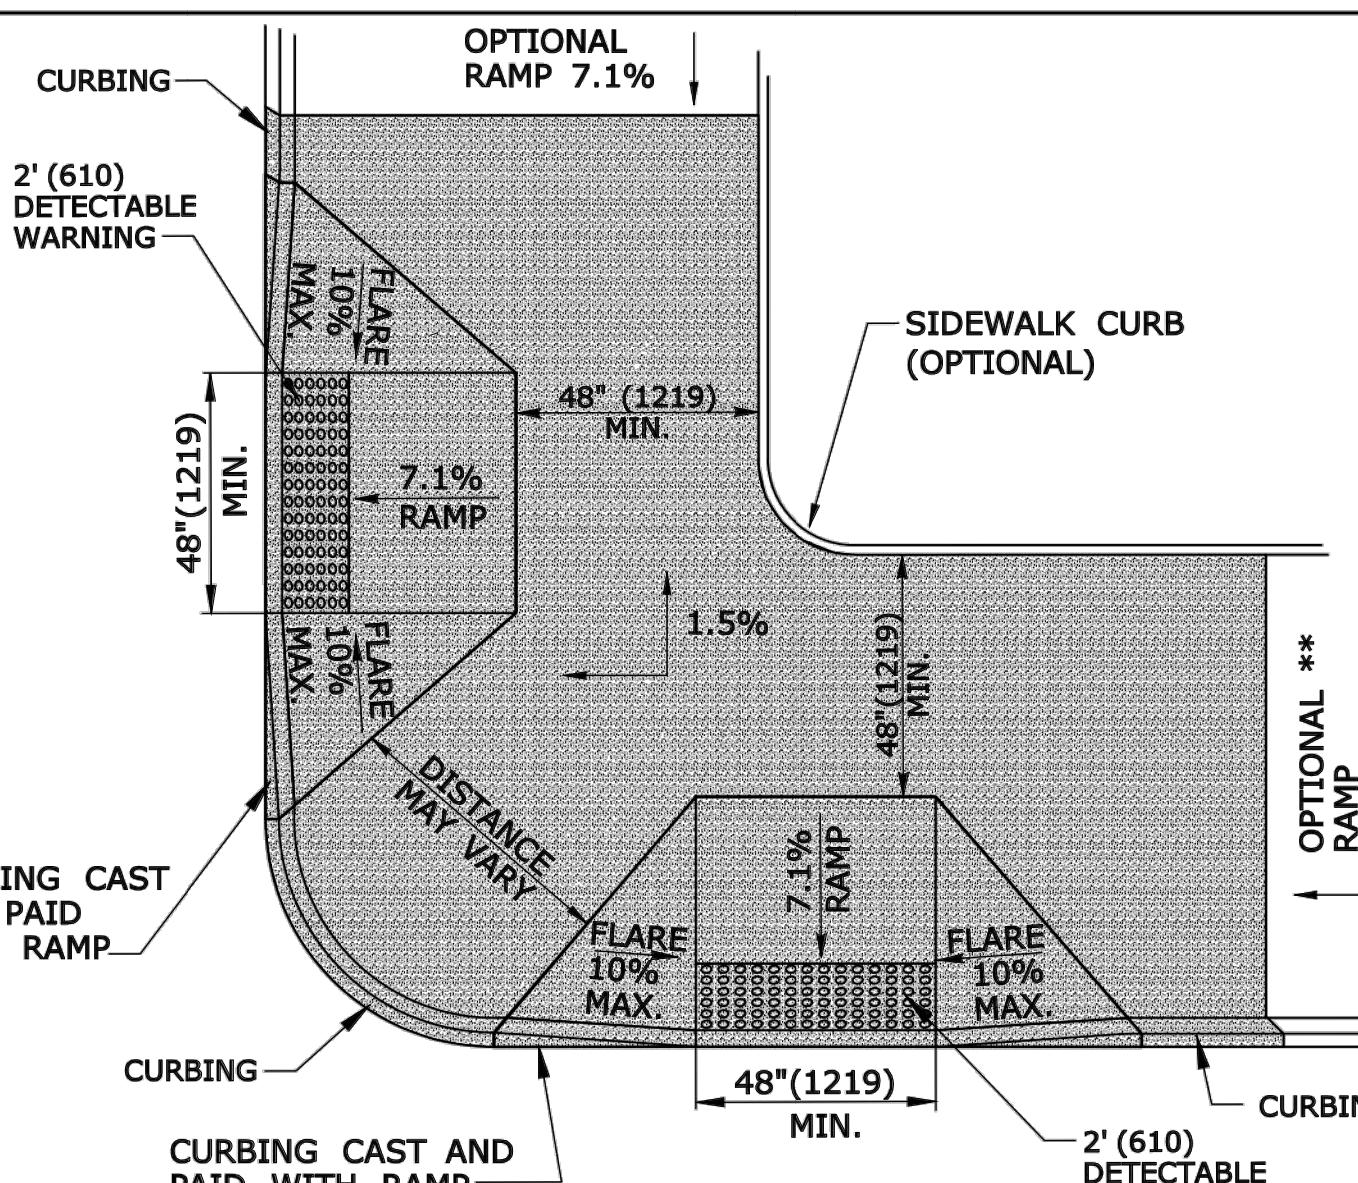


**DUAL PERPENDICULAR
SIDEWALK RAMPS (TYPE 3)**

SEE NOTES 19
** SEE NOTE 23

GENERAL NOTES:

- MAXIMUM SLOPES OF ADJOINING GUTTERS AND ROAD SURFACES IMMEDIATELY ADJACENT TO THE SIDEWALK RAMP SHOULD NOT EXCEED 5%. THE MAXIMUM GRADE DIFFERENCE BETWEEN THE GUTTER AND CURB RAMP SHALL NOT EXCEED 13%. SEE DETAIL 1 ON SHEET 4.
- RAMP GRADE SHALL BE UNIFORM, FREE OF SAGS AND ABRUPT GRADE CHANGES. RUNNING SLOPES OF RAMPS SHALL NOT EXCEED 8.33% AND SHALL NOT EXCEED 15' (4.5m) WITHOUT PROVIDING A LANDING.
- ALL RAMPS SHALL BE CONSTRUCTED OF CLASS "F" CONCRETE IN ACCORDANCE WITH CONNECTICUT STANDARD SPECIFICATIONS.
- SIDEWALK RAMPS SHALL HAVE A COARSE BROOM FINISH TRANSVERSE TO THE SLOPE OF THE RAMP. THE SURFACE OF ALL SIDEWALK RAMPS SHALL BE STABLE, FIRM AND SLIP RESISTANT. SURFACE DISCONTINUITIES SHALL NOT EXCEED $\frac{1}{2}$ " (13) MAX. VERTICAL DISCONTINUITIES BETWEEN $\frac{1}{4}$ " (6.4) AND $\frac{1}{2}$ " (13) MAX. SHALL BE BEVELED 1:2 MINIMUM APPLIED ACROSS THE ENTIRE LEVEL CHANGE.
- DIAGONAL SIDEWALK RAMPS AT MARKED CROSSINGS SHALL BE WHOLLY CONTAINED WITHIN THE MARKINGS, EXCLUDING ANY FLARED SIDES. DIAGONAL AND PERPENDICULAR RAMPS SHALL HAVE THE RAMP CUT PERPENDICULAR TO THE TANGENT OF THE CURB RADIUS FOR THE DESIGNATED ACCESSIBLE ROUTE. BOTH LONGITUDINAL SIDES OF THE RAMP SHOULD BE THE SAME LENGTH. SKEWED RAMPS SHOULD BE AVOIDED. FLARES ARE NOT CONSIDERED PART OF PEDESTRIAN ACCESS ROUTE. DIAGONAL RAMPS SHOULD NOT BE INSTALLED WHERE CURB RADII IS LESS THAN 20' (6096).
- REMOVAL OF EXISTING SIDEWALK FOR NEW RAMP INSTALLATIONS SHALL BE TO THE NEAREST EXPANSION OR CONTRACTION JOINT. 8.3% MAXIMUM SLOPE MAY NOT BE ACHIEVABLE DUE TO EXISTING SIDEWALK GRADE. IN RECOGNITION OF THIS, A LIMIT OF 15' (4572) FOR REMOVAL SHALL BE USED UNLESS OTHERWISE SHOWN ON THE PLANS OR DIRECTED BY THE ENGINEER. SAW CUT REQUIRED FOR DUMMY JOINTS SHALL BE INCLUDED IN THE COST OF "CONCRETE SIDEWALK RAMP" OR "CONCRETE SIDEWALK".
- EXPANSION JOINTS IN CONCRETE SHALL MATCH THOSE IN ADJACENT SIDEWALKS BUT IN NO CASE SHALL THE SPACING BETWEEN EXPANSION JOINTS EXCEED 12' (3658) UNLESS OTHERWISE NOTED.
- CONCRETE SIDEWALK RAMPS, SHALL BE PAID FOR UNDER THE ITEM "CONCRETE SIDEWALK RAMP", AS DEFINED BY THE CONSTRUCTION LIMITS ON THE PLANS AND SHALL BE FIELD VERIFIED.
- SIDEWALK RAMPS SHALL BE CONSTRUCTED WITH THE TOE AT THE GUTTER CAST INTEGRALLY WITH RAMP UNLESS DIRECTED OTHERWISE BY THE ENGINEER (SEE TYPICAL SECTION ON SHEET 3). CURB REMOVAL AND CAST IN PLACE CURBING REQUIRED FOR THE RAMP, SHALL BE INCLUDED WITH PAY ITEM "CONCRETE SIDEWALK RAMP". CURBING OUTSIDE LIMITS OF RAMP OR LANDING SHOWN ON SHEET 3 SHALL BE CONSTRUCTED AND PAID FOR IN ACCORDANCE WITH CONNECTICUT STANDARD SPECIFICATIONS.
- PREFERRED LOCATION TO INSTALL DETECTABLE WARNING STRIP SHALL BE 6" (152) FROM THE EDGE OF ROAD ALONG THE FULL WIDTH OF THE RAMP. FOR ALTERNATE LOCATIONS, REFER TO DETECTABLE WARNING PLACEMENT DETAILS ON SHEET 4.
- TO PERMIT WHEELCHAIR WHEELS TO ROLL BETWEEN DOMES, ALIGN DOMES ON A SQUARE GRID IN THE DIRECTION OF RUNNING SLOPE (PERPENDICULAR TO CURB OR SLOPE BREAK). THE TRANSITION FROM RAMP TO GUTTER SHALL BE FLUSH WITHOUT A LIP.
- WHERE COMMERCIAL DRIVEWAYS ARE PROVIDED WITH TRAFFIC SIGNALS AND THE SIDEWALK IS CONTINUOUS THROUGH DRIVEWAY, DETECTABLE WARNINGS ARE REQUIRED AT THE JUNCTION BETWEEN THE PEDESTRIAN ROUTE AND DRIVEWAY.
- CONSTRUCT A SIDEWALK CURB WHEN THERE IS INSUFFICIENT BUFFER AVAILABLE TO GRADE OR WHEN CALLED FOR IN PLANS. PAID FOR WITH SIDEWALK RAMP WHEN REQUIRED FOR RAMP.
- THE TOP AND BOTTOM OF RAMPS SHOULD BE PROVIDED WITH A 4' x 4' (1219 x 1219) MINIMUM LEVEL LANDING AREA WITH A CROSS SLOPE LESS THAN OR EQUAL TO 2% IN ANY DIRECTION.
- UTILITY POLES, LUMINAIRE, PEDESTRIAN OR SIGNAL POLES, GRATES, ACCESS COVERS, AND OTHER APPURTENANCES SHALL NOT BE LOCATED ON RAMPS, LANDINGS, BLENDED TRANSITIONS, AND @ GUTTERS WITHIN THE PEDESTRIAN ACCESS ROUTE.
- APPROACH SIDEWALK WIDTHS, GRASS STRIP OR UTILITY STRIP WIDTHS MAY VARY.
- APPROACH SIDEWALK AND LANDING CROSS SLOPE SHALL NOT EXCEED 2%.
- THE RUNNING OR CROSS SLOPES ON LANDINGS AT MID BLOCK CROSSING MAY BE warped TO MEET STREET OR HIGHWAY GRADE.
- FOR PERPENDICULAR CURB RAMPS A MIN. 4'(1.2m) x 4'(1.2m) LEVEL LANDING SHALL BE PROVIDED AT THE TOP OF CURB RAMP. WHERE THE LEVEL LANDING IS RESTRICTED AT THE BACK OF SIDEWALK THE LEVEL LANDING SHALL BE 4'(1.2m) x 5'(1.5m) WITH THE 5'(1.5m) DIMENSION PROVIDED IN THE DIRECTION OF THE RAMP RUN.
- FOR PARALLEL CURB RAMPS, A MIN. 4'(1.2m) x 4'(1.2m) LEVEL LANDING SHALL BE PROVIDED AT THE BOTTOM OF CURB RAMP. IF THE LEVEL LANDING IS RESTRICTED ON 2 OR MORE SIDES, THE LEVEL LANDING SHALL BE 4'(1.2m) x 5'(1.5m) WITH THE 5'(1.5m) DIMENSION PROVIDED IN THE DIRECTION OF THE PEDESTRIAN STREET CROSSING.
- WHEN WIDTH OF SIDEWALK IS \geq 48" AND A PERPENDICULAR SIDEWALK RAMP IS INSTALLED, THE FLARED SIDES SHALL BE 10% MAX. IF WIDTH OF SIDEWALK IS $<$ 48" THE FLARED SIDES MUST NOT EXCEED 8.33% (12:1).
- SHADED AREAS ARE TYPICAL PAY LIMITS FOR CONCRETE SIDEWALK RAMP BUT, MAY VARY AS DIRECTED BY THE ENGINEER.
- OPTIONAL RAMP, WHEN REQUIRED, SHALL BE PAID FOR AS PART OF CONCRETE SIDEWALK RAMP.

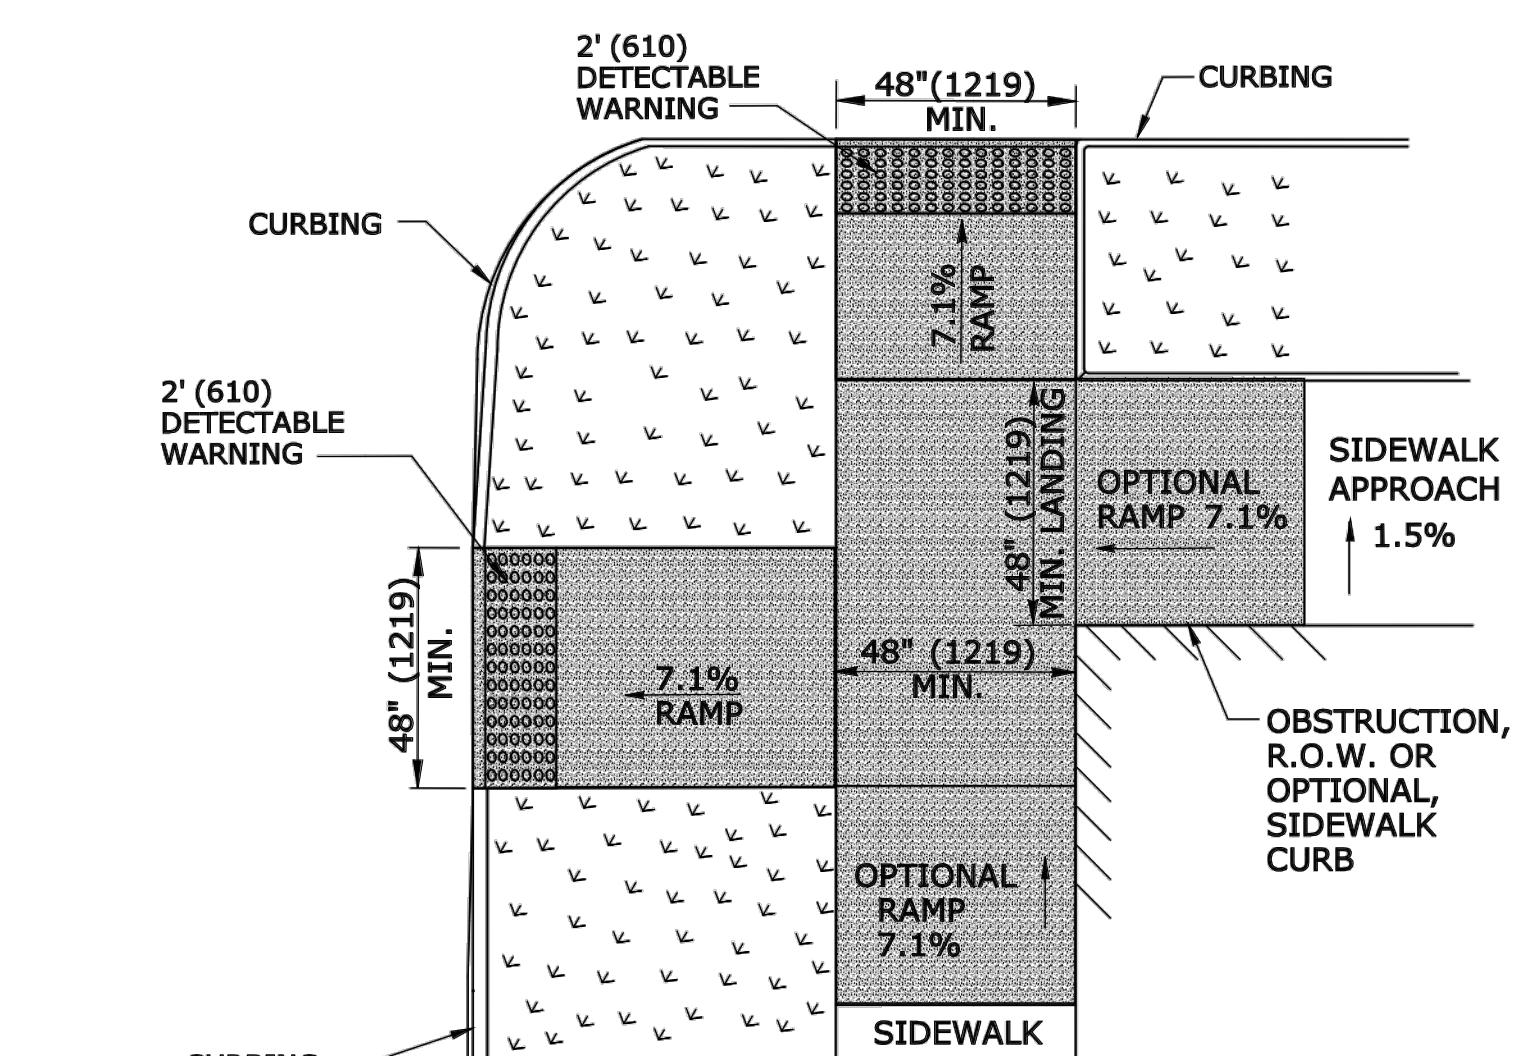

**DUAL PERPENDICULAR SIDEWALK RAMPS (TYPE 3a)
WITH UTILITY / GRASS STRIP**

SEE NOTE 20

ALL METRIC DIMENSIONS ARE IN MILLIMETERS (mm) UNLESS OTHERWISE NOTED.

-	-	-	-
-	-	-	-
-	-	-	-
-	-	-	-
-	-	-	-
1	7/13	Created new sheets (4 total).	-
REV. DATE	REVISION DESCRIPTION	SHEET NO.	Plotted Date: 6/17/2014

THE INFORMATION, INCLUDING ESTIMATED QUANTITIES OF WORK, SHOWN ON THESE SHEETS IS BASED ON LIMITED INVESTIGATIONS BY THE STATE, AND IS NOT TO BE CONSIDERED AS INDICATING THE CONDITIONS OF ACTUAL QUANTITIES OF WORK WHICH WILL BE REQUIRED.

DESIGNER/DRAFTER: **MGB/EMK**
CHECKED BY: **LLF**

STATE OF CONNECTICUT
DEPARTMENT OF TRANSPORTATION


Filename: ...\\SIDEWALK RAMP 1.GDN

SIGNATURE/ BLOCK:
OFFICE OF ENGINEERING
APPROVED BY:
Tighe&Bond
www.tighebond.com


PROJECT TITLE:
**WHITNEY AVENUE AT
MAIN STREET (ROUTE 111)
INTERSECTION IMPROVEMENTS**

TOWN: **TRUMBULL**
DRAWING TITLE: **SIDEWALK RAMPS SHEET 1**
SHEET NO. **SHEET 11**


PROJECT NO. **T0196-116**
DRAWING NO.
SHEET NO. **SHEET 11**

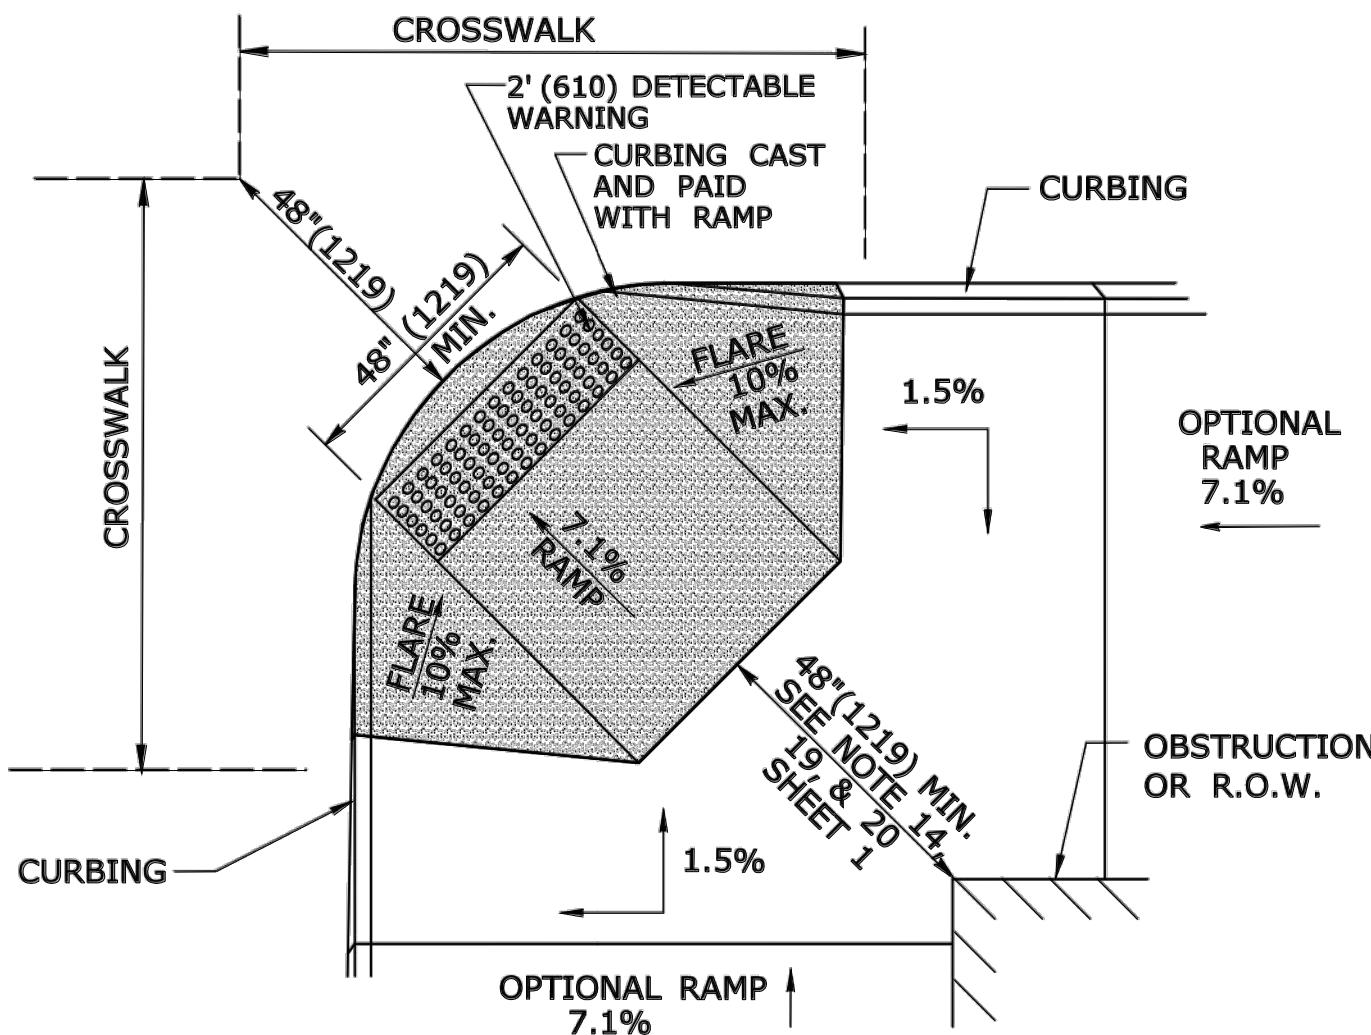

**DIAGONAL SIDEWALK RAMP (TYPE 4)
W/LANDING AT TOP**

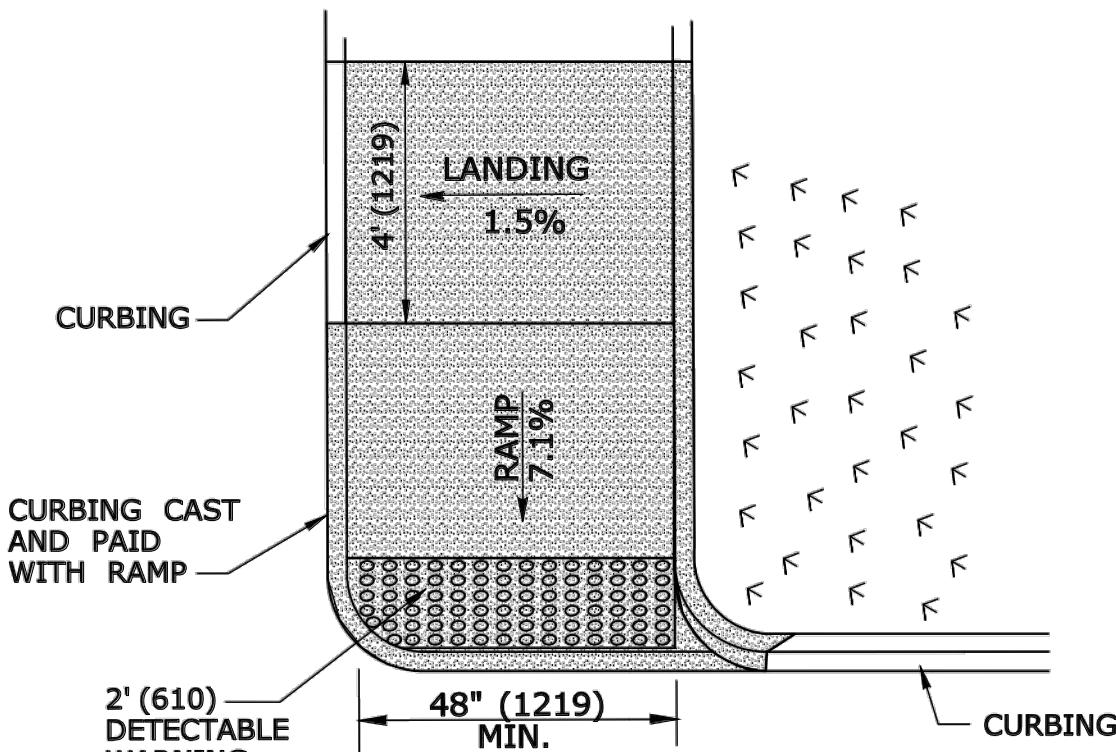


**SINGLE DIRECTION
PERPENDICULAR SIDEWALK RAMP
NO / UTILITY GRASS STRIP
(TYPE 4a)**

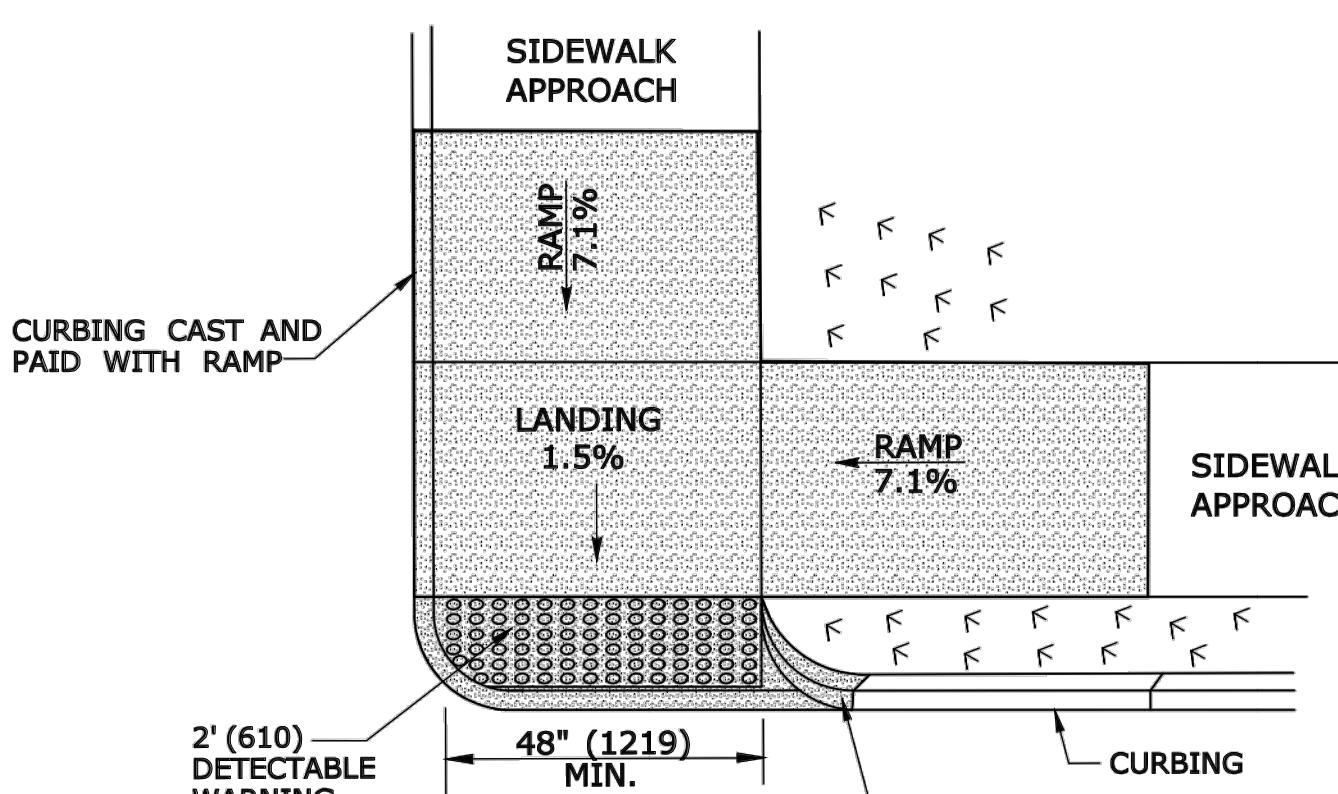


**DOUBLE DIRECTION
PARALLEL SIDEWALK RAMP
NO / UTILITY GRASS STRIP
(TYPE 4b)**

SEE NOTE 20 SHEET 1

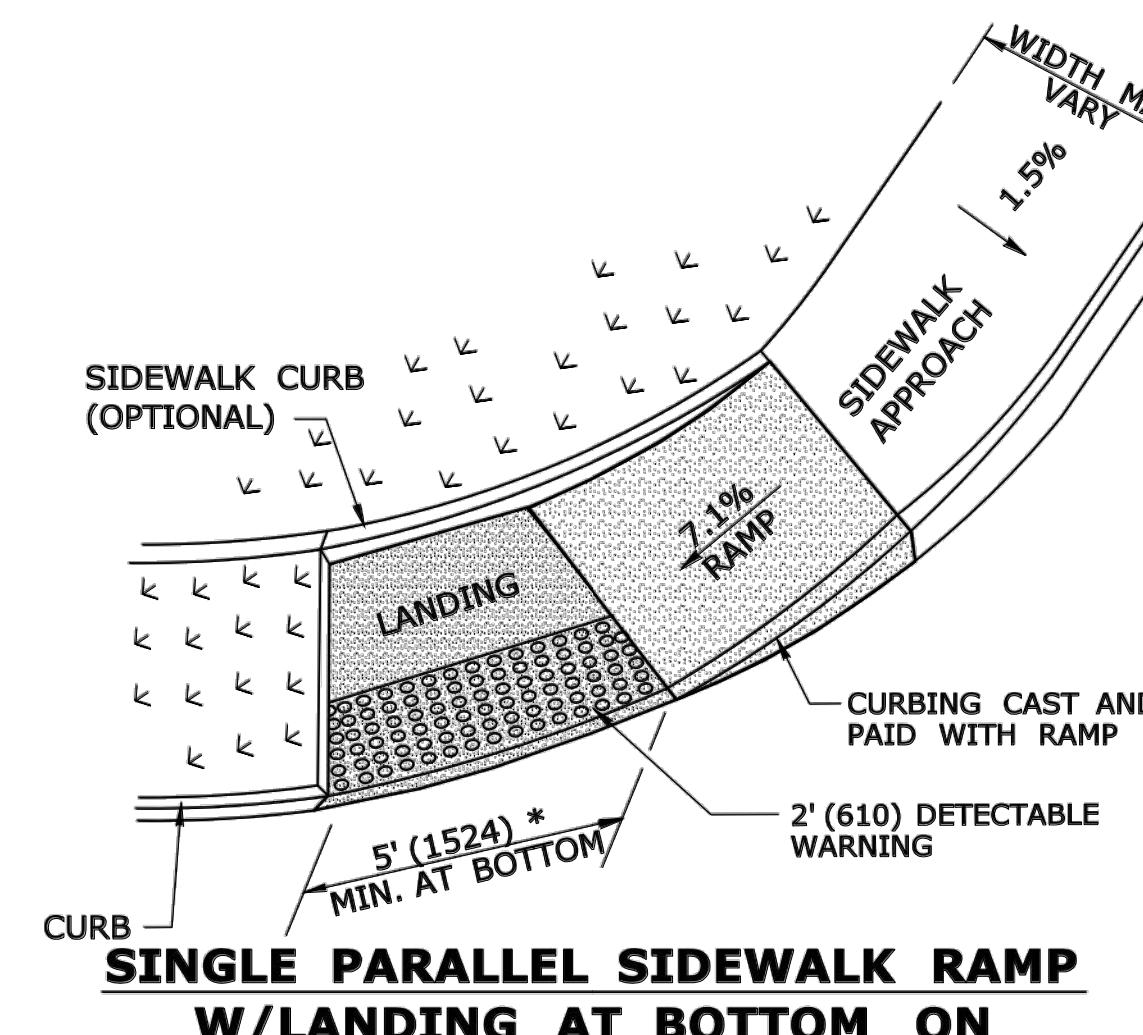


**SINGLE PARALLEL SIDEWALK RAMP
W/LANDING AT BOTTOM ON
CORNER (TYPE 4c)**

* SEE NOTE 20 SHEET 1

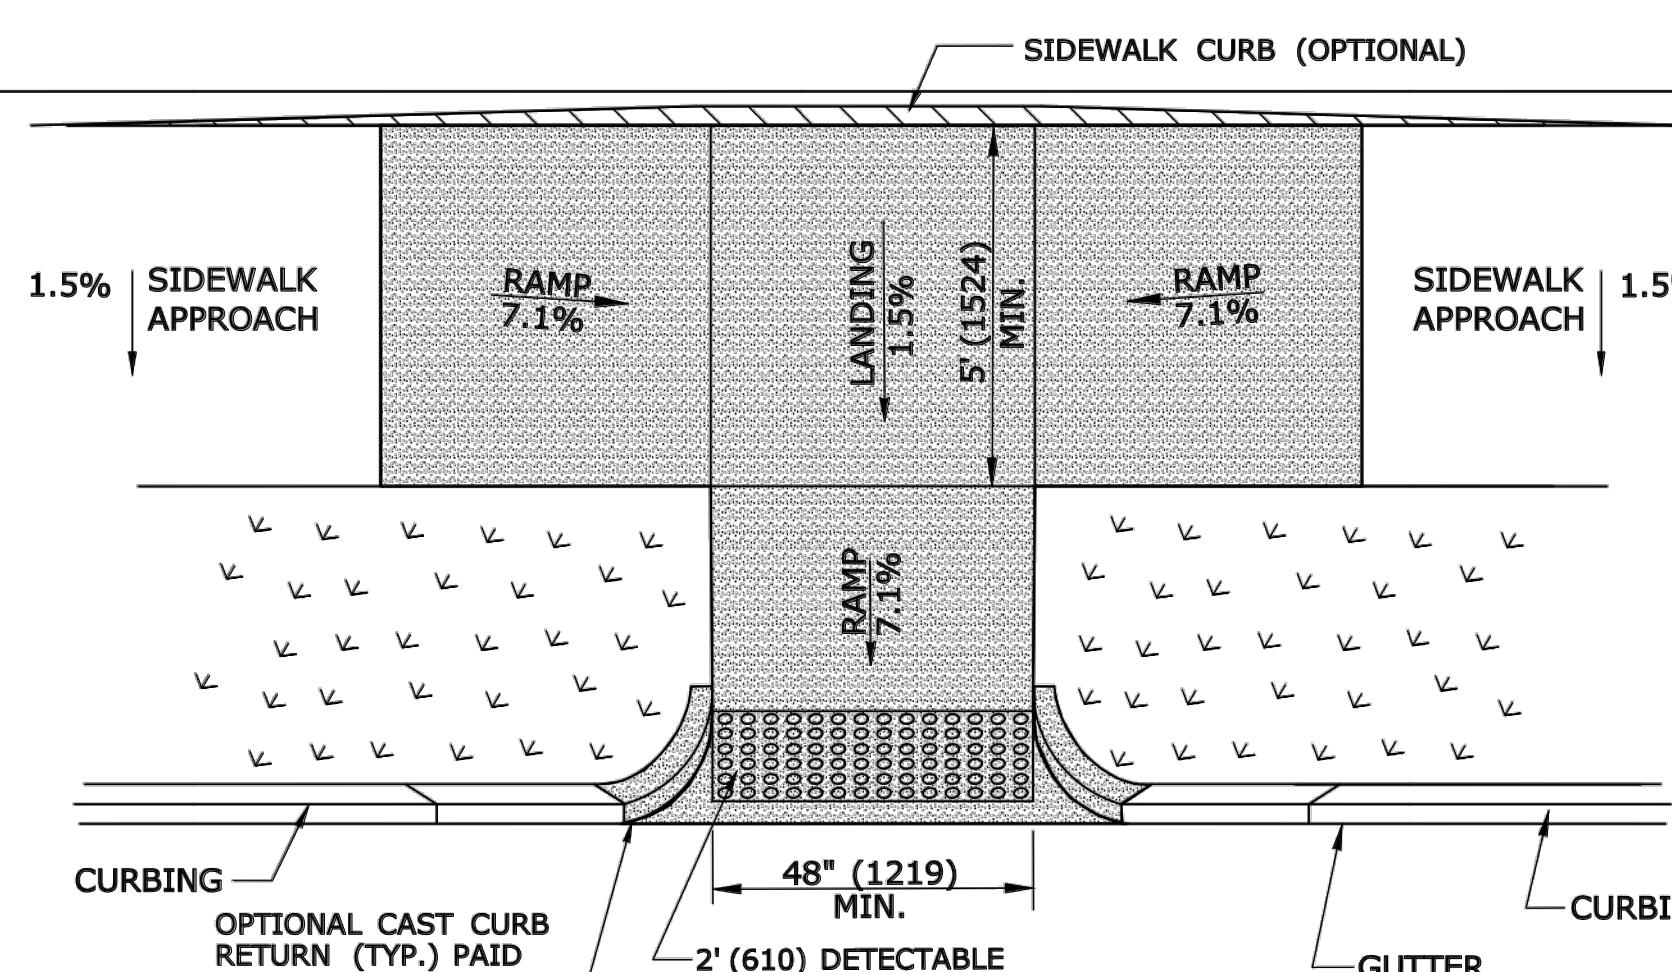


**PARALLEL/PERPENDICULAR SIDEWALK RAMP
COMBINATION W/ CURB RETURNS (TYPE 4d)**

* OPTIONAL FLARE ONE SIDE

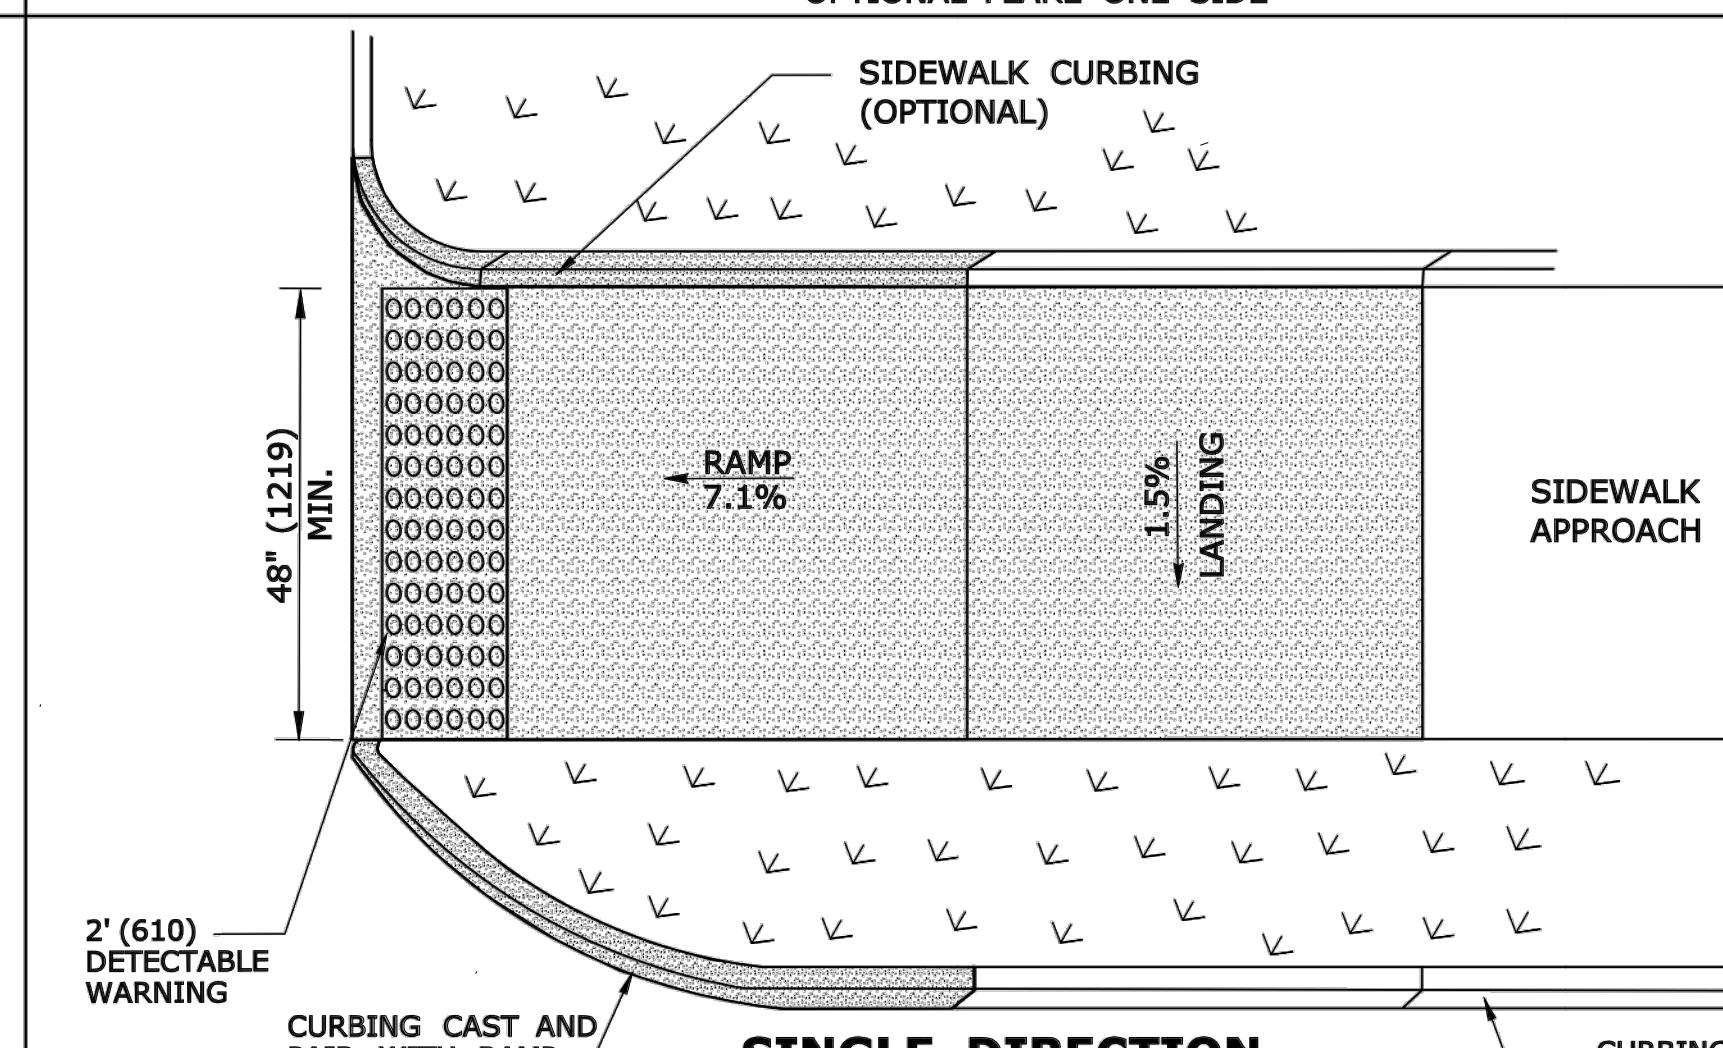


**SINGLE DIRECTION
PERPENDICULAR SIDEWALK RAMP
W/ UTILITY GRASS STRIP (TYPE 4e)**

REFER TO DETECTABLE WARNING PLACEMENT ON SHEET 4

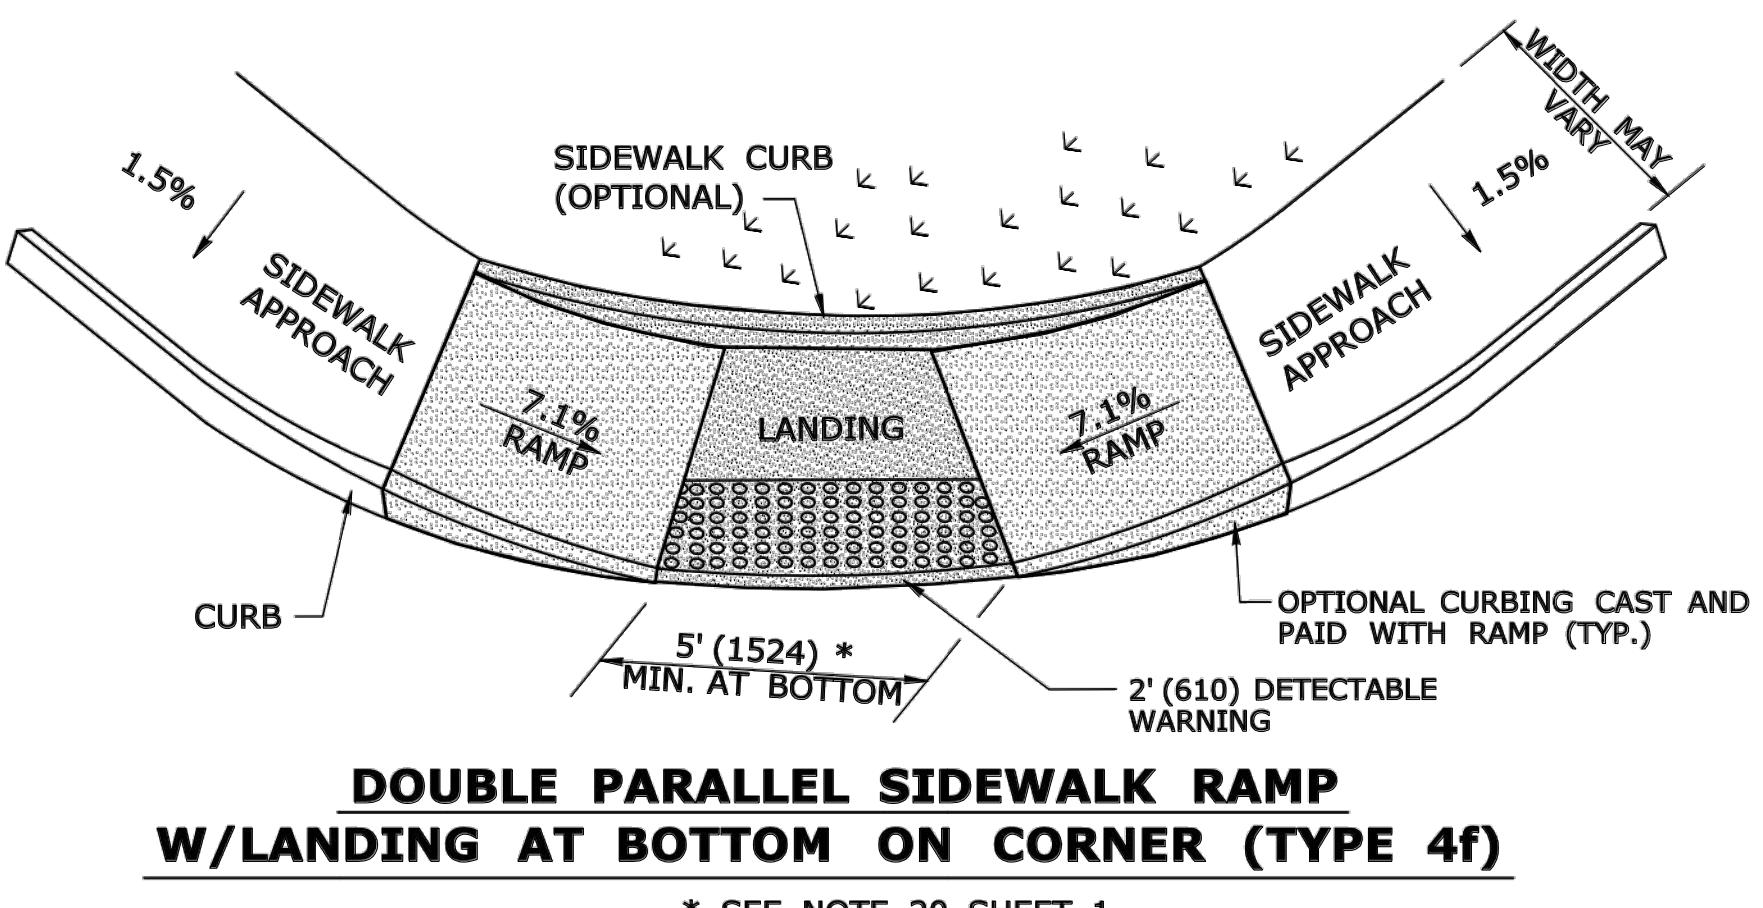

**DOUBLE PARALLEL SIDEWALK RAMP
W/LANDING AT BOTTOM ON CORNER (TYPE 4f)**

* SEE NOTE 20 SHEET 1

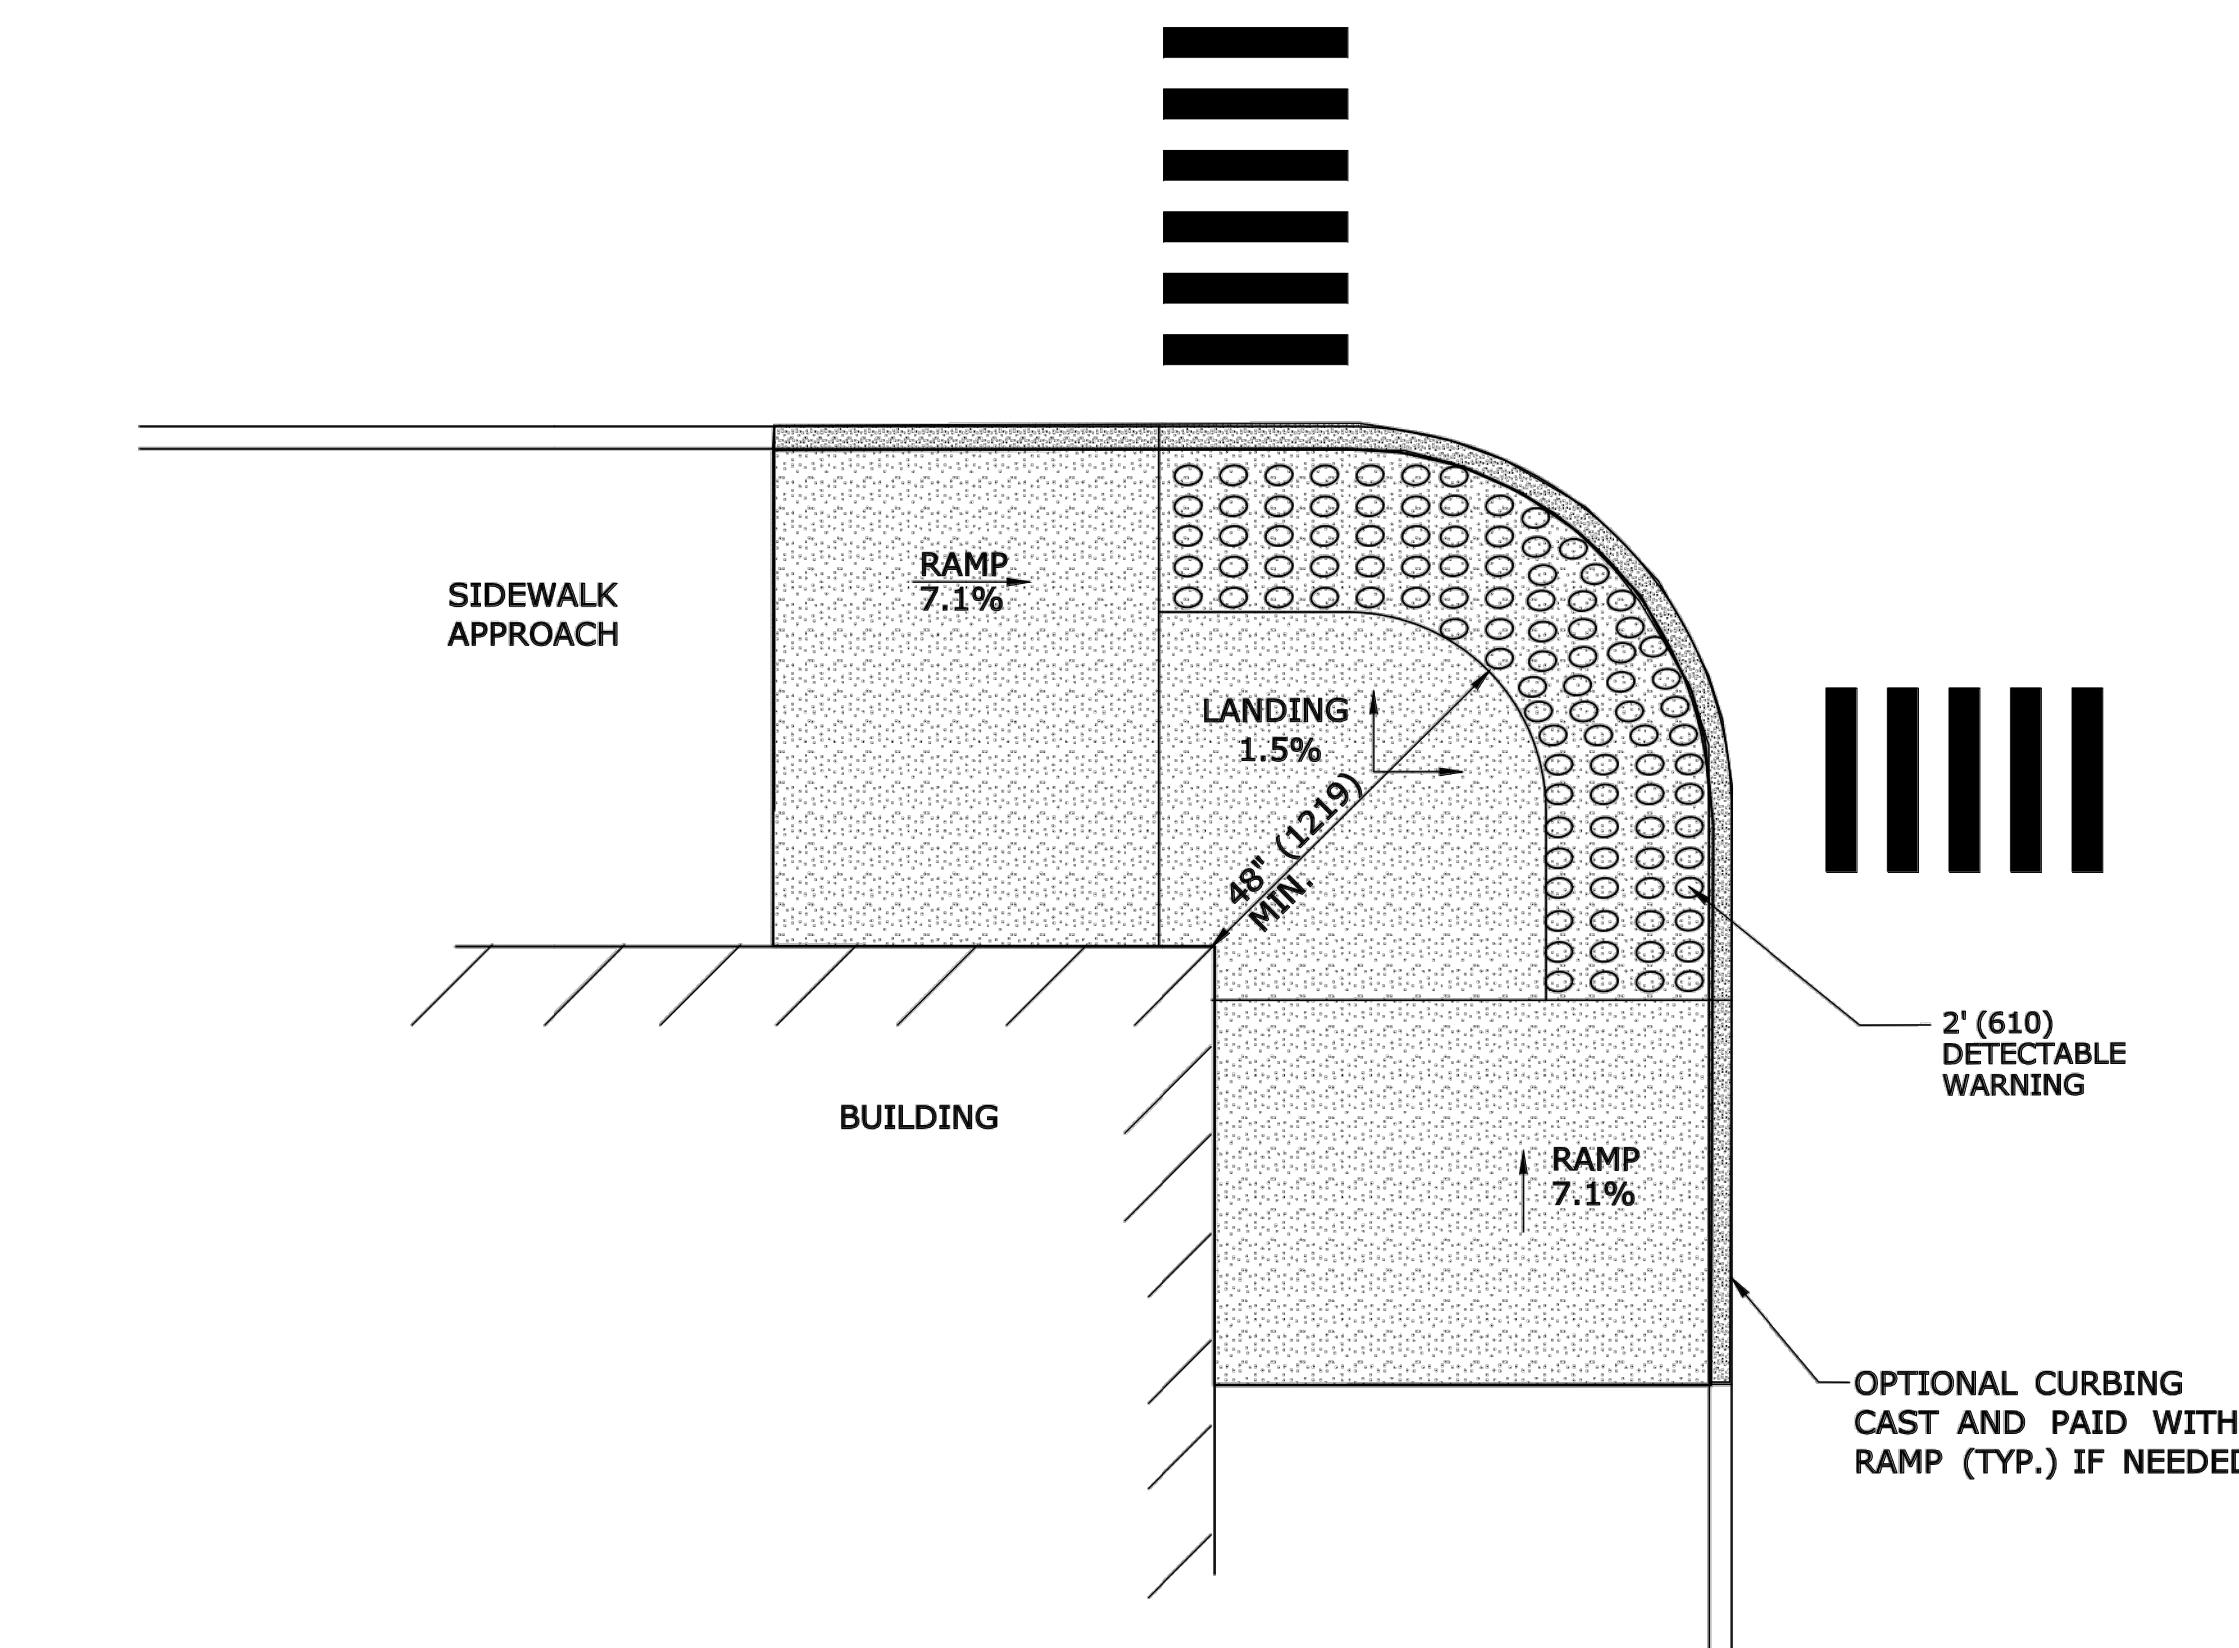

**RESTRICTED CONDITION
DIAGONAL SIDEWALK RAMP
(TYPE 4g)**

ALL METRIC DIMENSIONS ARE IN MILLIMETERS (mm) UNLESS OTHERWISE NOTED

REV.	DATE	REVISION DESCRIPTION	SHEET NO.
			Plotted Date: 5/27/2014

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DESIGNER/DRAFTER:
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LLF


STATE OF CONNECTICUT
DEPARTMENT OF TRANSPORTATION

SIGNATURE/BLOCK:
OFFICE OF ENGINEERING
APPROVED BY:
Tighe&Bond
www.tighebond.com


PROJECT TITLE:
**WHITNEY AVENUE AT
MAIN STREET (ROUTE 111)
INTERSECTION IMPROVEMENTS**

TOWN:
TRUMBULL
DRAWING TITLE:
**SIDEWALK RAMP
SHEET 2**

PROJECT NO.
T0196-116
DRAWING NO.
SHEET NO.
SHEET 12

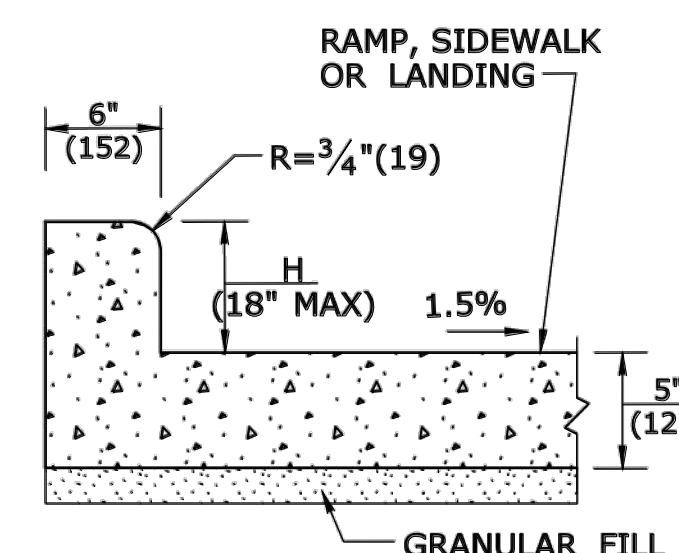


MONOLITHIC CAST CURB

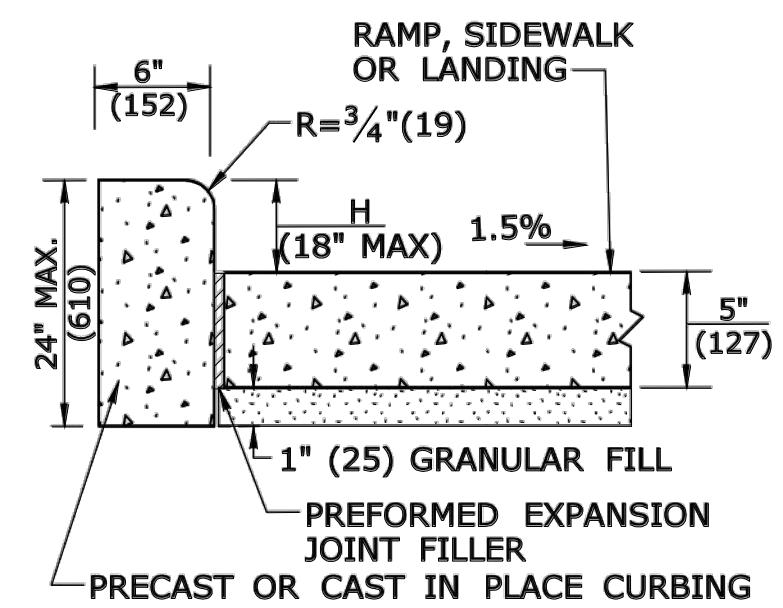


SEPARATELY CAST CURB

SIDEWALK CURB OPTIONS AT BACK OF SIDEWALK

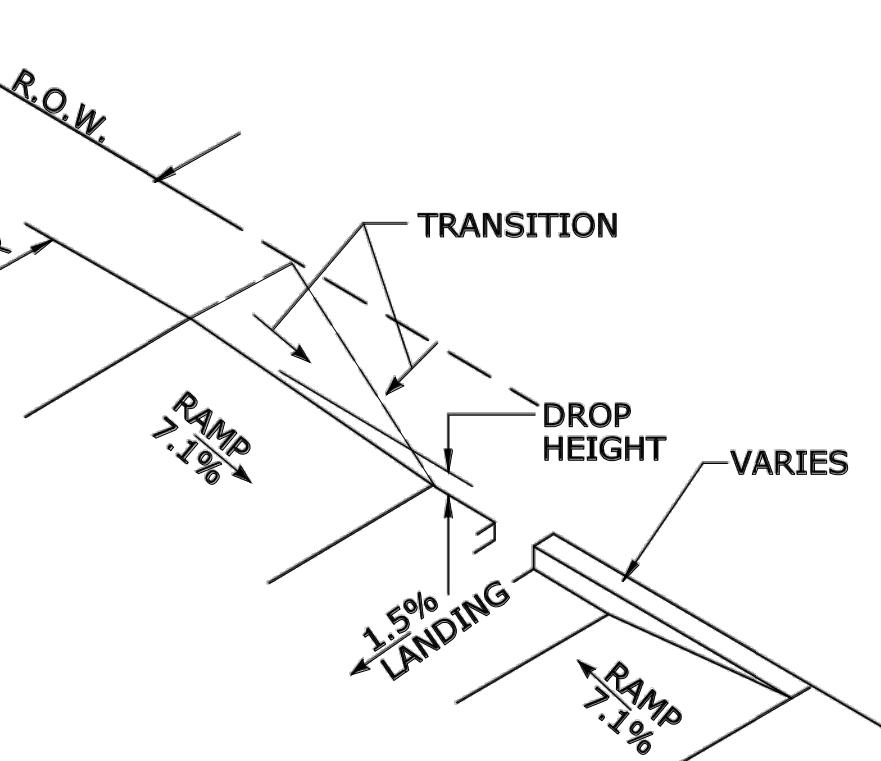

**BACK OF SIDEWALK CURB OR
BUFFER TRANSITION**

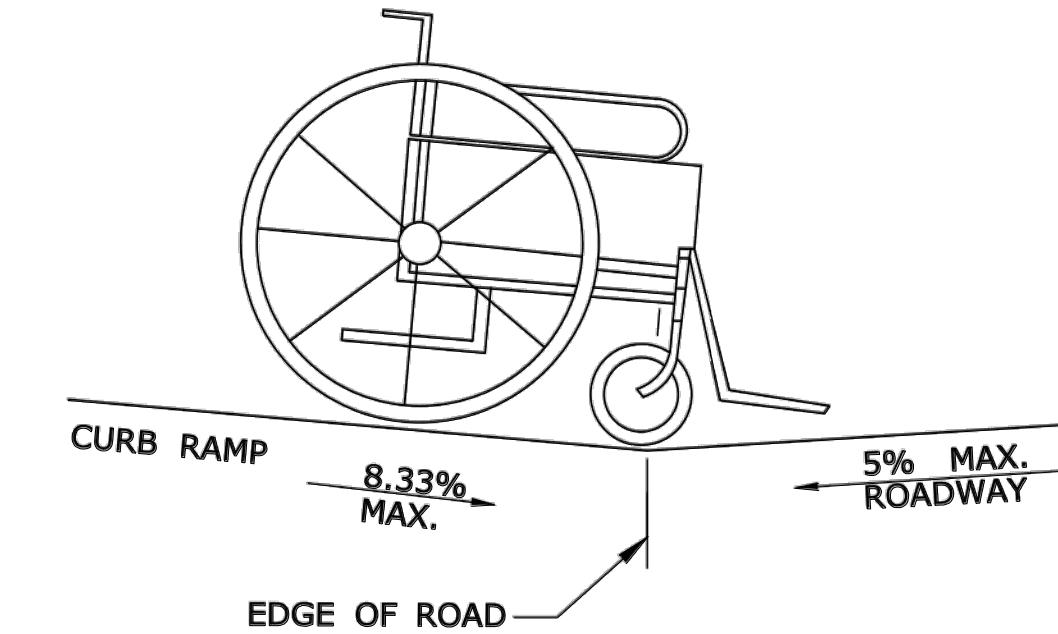


DETAIL 1
SEE GRADE CHANGE AT ROADWAY INTERFACE

SEE NOTE 1 SHEET HW-921 02a

GENERAL NOTES:


- RAMPED MEDIAN SHALL HAVE A CURB RAMP AT EITHER END AND LEVEL LANDING A MINIMUM OF 5' x 5' (1.5m x 1.5m) IN BETWEEN. CUT-THROUGH MEDIAN SHALL BE A MINIMUM OF 6' (1.8m) LONG AND 5' (1.5m) WIDE. FOR ALL MEDIAN, CUT-THROUGH OR RAMPED, A 2' (610) STRIP OF DETECTABLE WARNINGS SHALL BE INSTALLED AT THE ENTRANCE AND EXIT.
- SEE GENERAL NOTES ON SHEET 1.

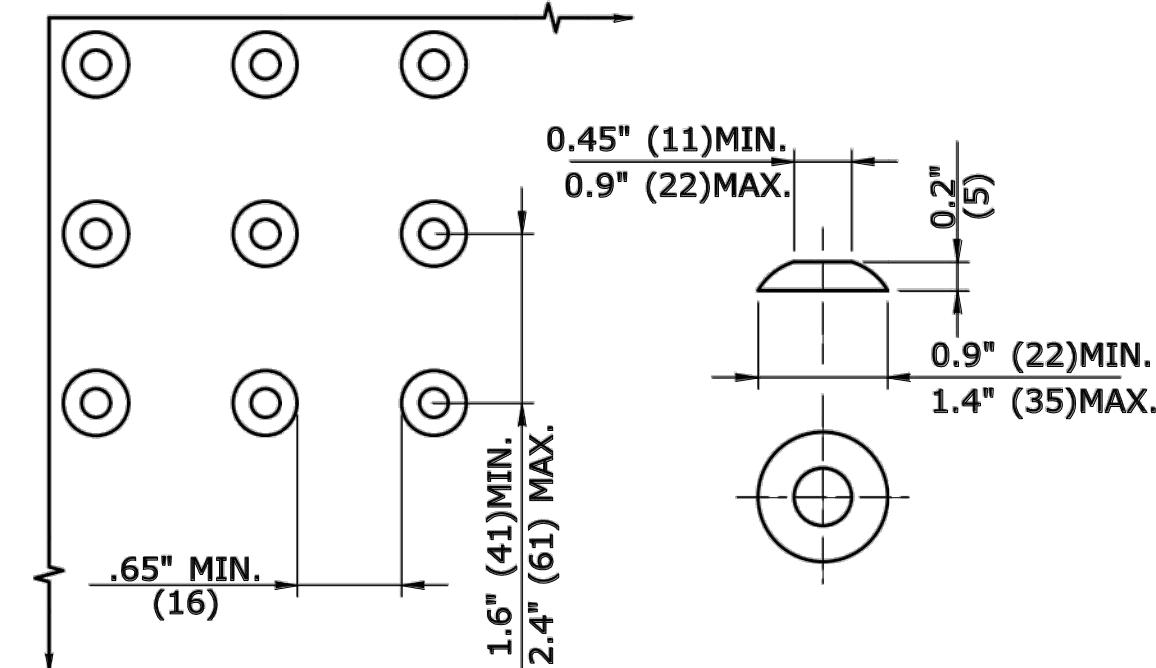


DOME SPACING

DOME SECTION

STANDARD DOME ON DETECTABLE WARNING TILES

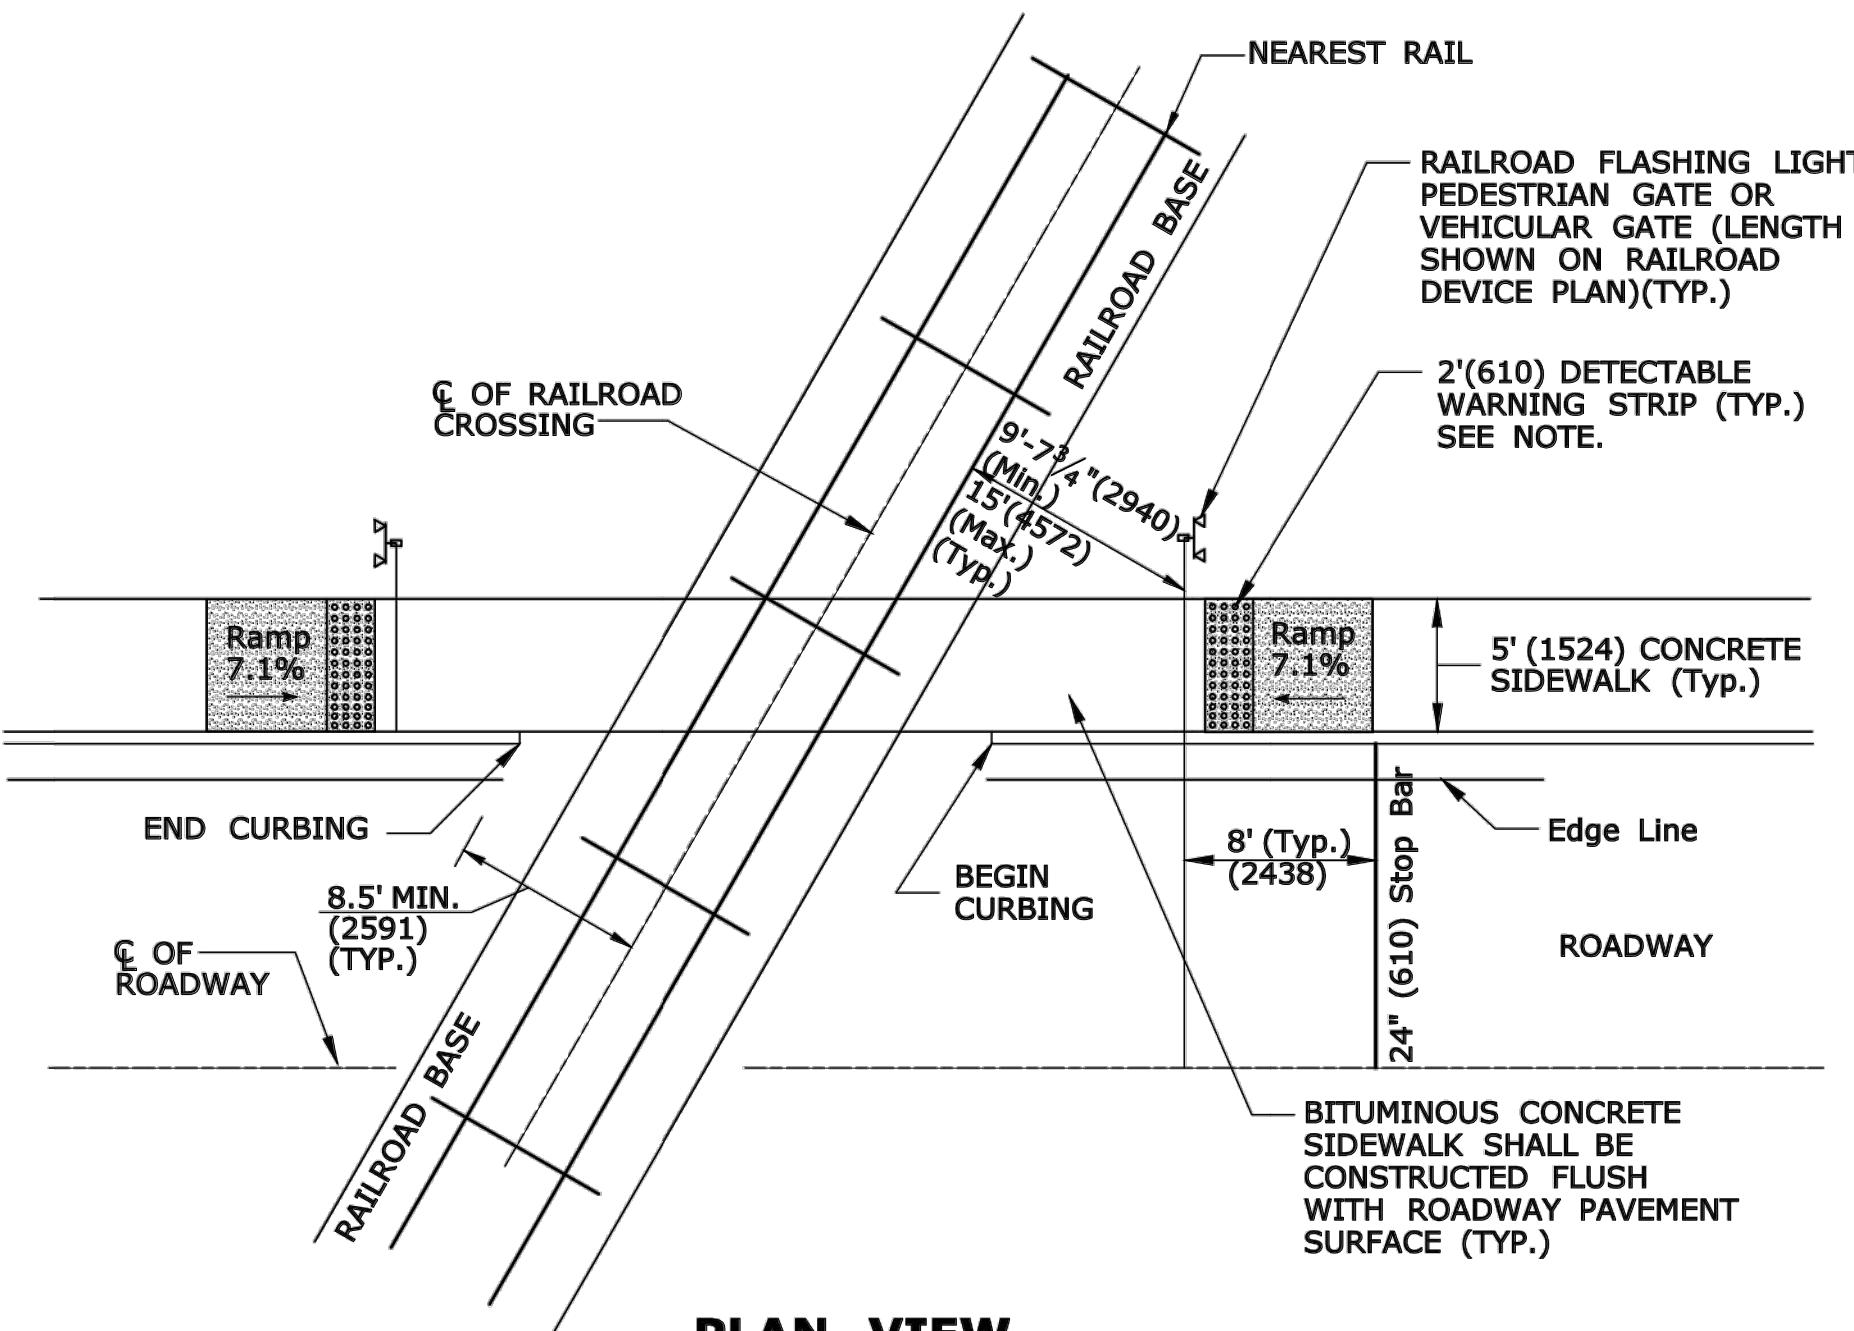


PLAN VIEW

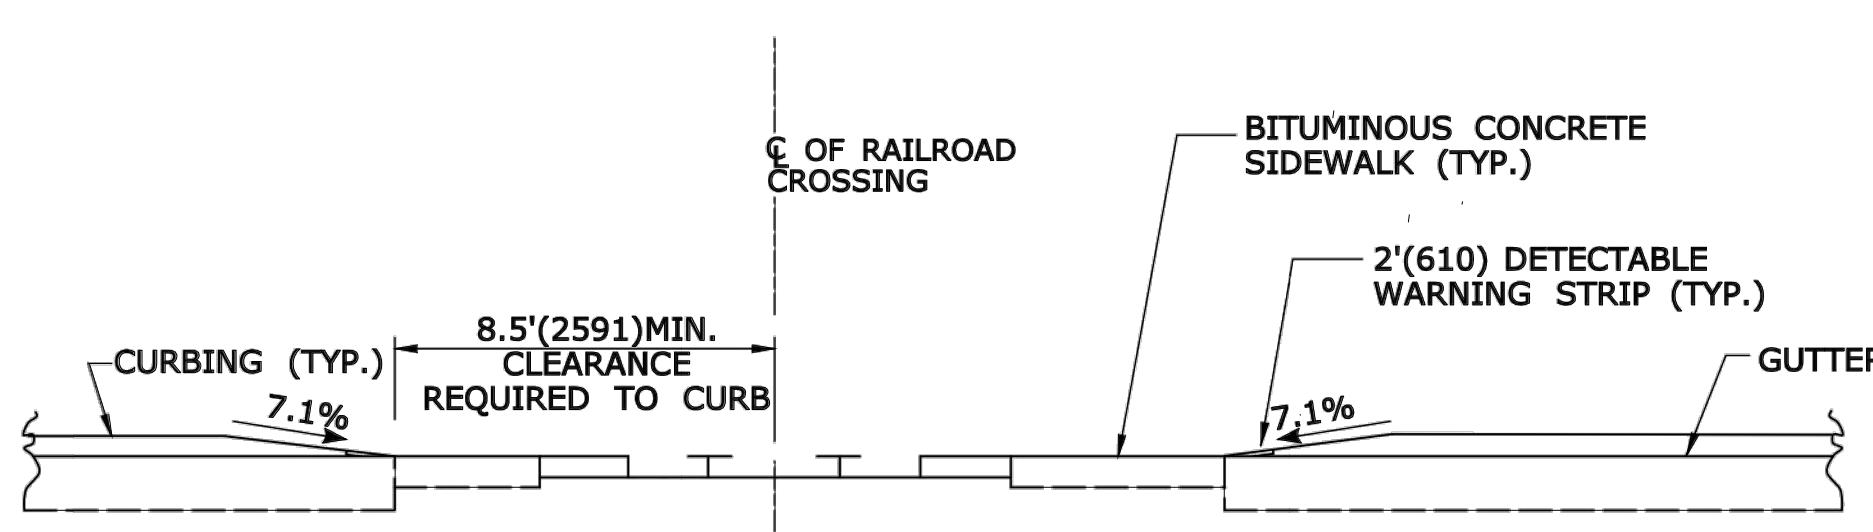


ELEVATION VIEW

DETECTABLE WARNINGS AT RAILROAD CROSSING


NOTE: WHEN NO GATE IS PRESENT, INSTALL DETECTABLE WARNING SURFACE 12' (3.6m) FROM THE NEAREST RAIL. IF GATE IS PRESENT, INSTALL DETECTABLE WARNING 2' (610) PRIOR TO GATE. THE ROWS OF TRUNCATED DOMES IN A DETECTABLE WARNING SURFACE SHALL BE INSTALLED PARALLEL WITH THE DIRECTION OF PEDESTRIAN TRAVEL.

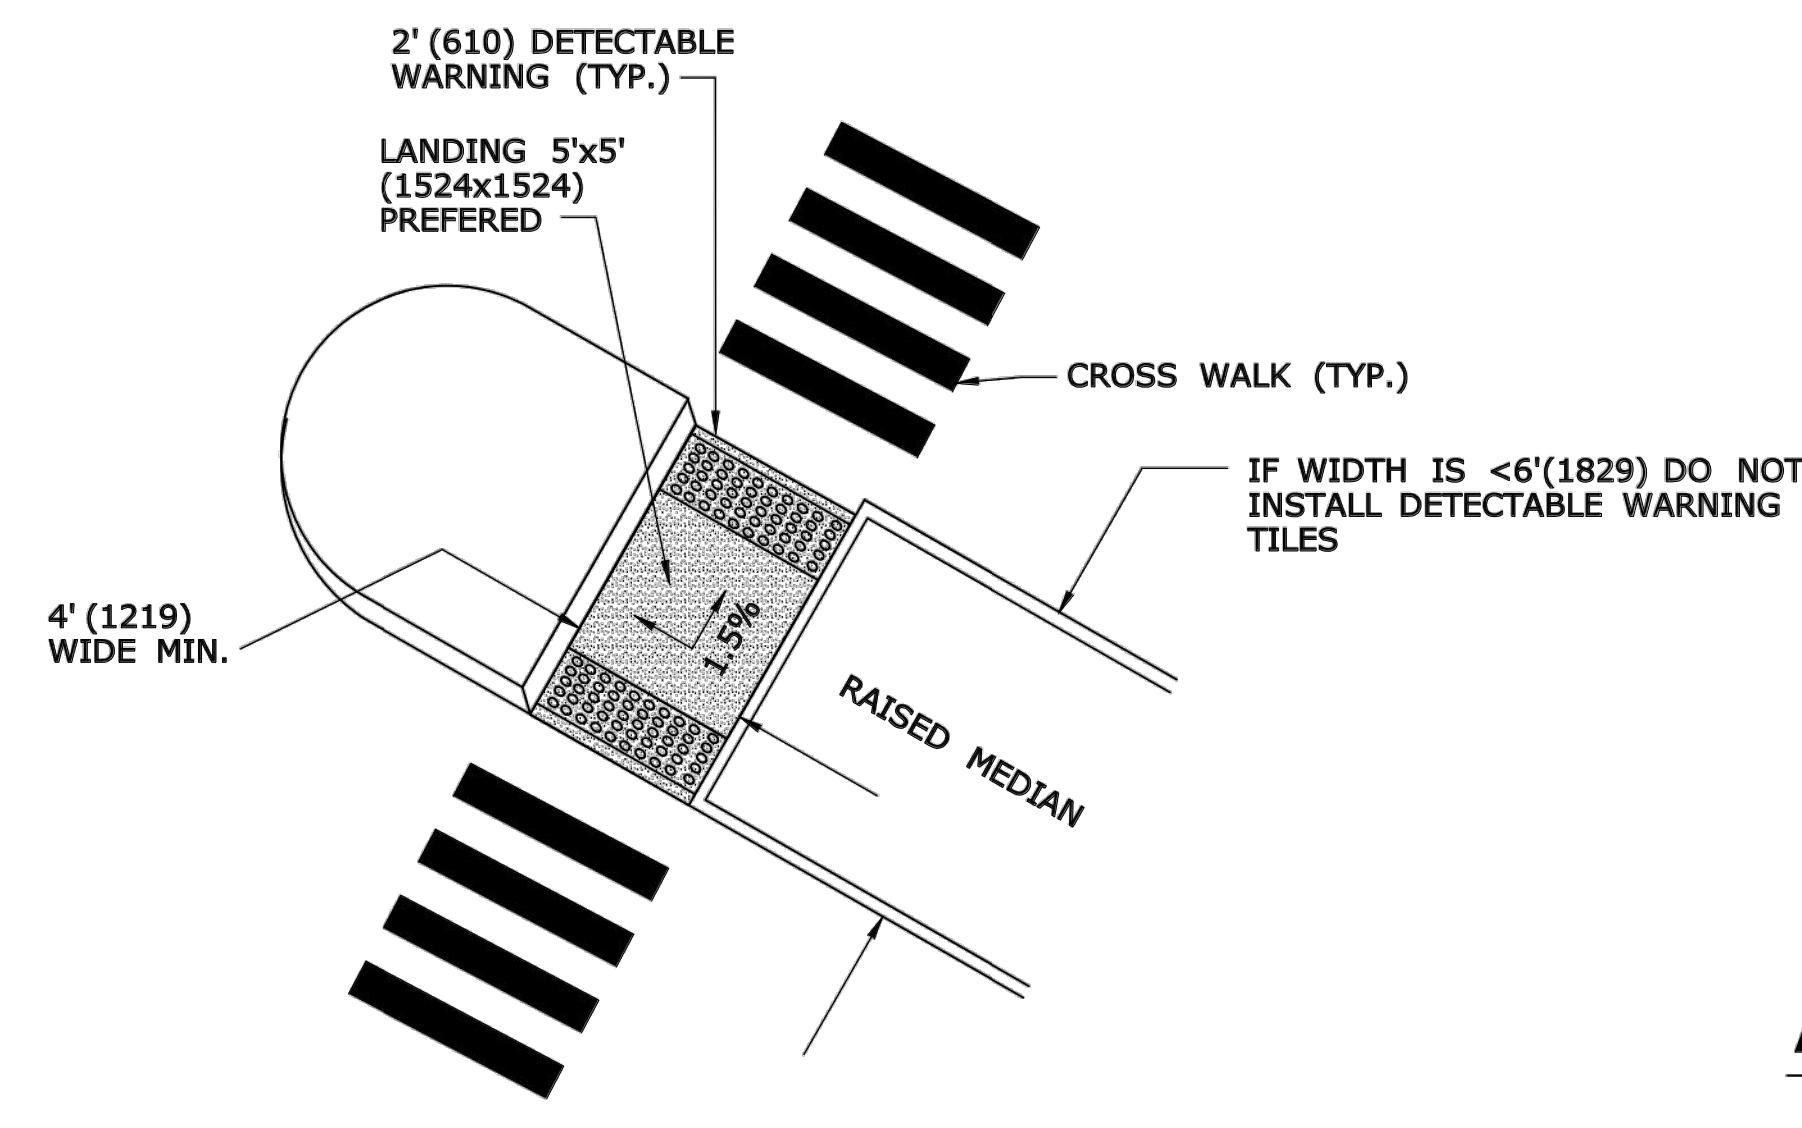


**CUT-THROUGH
MEDIAN ISLAND**

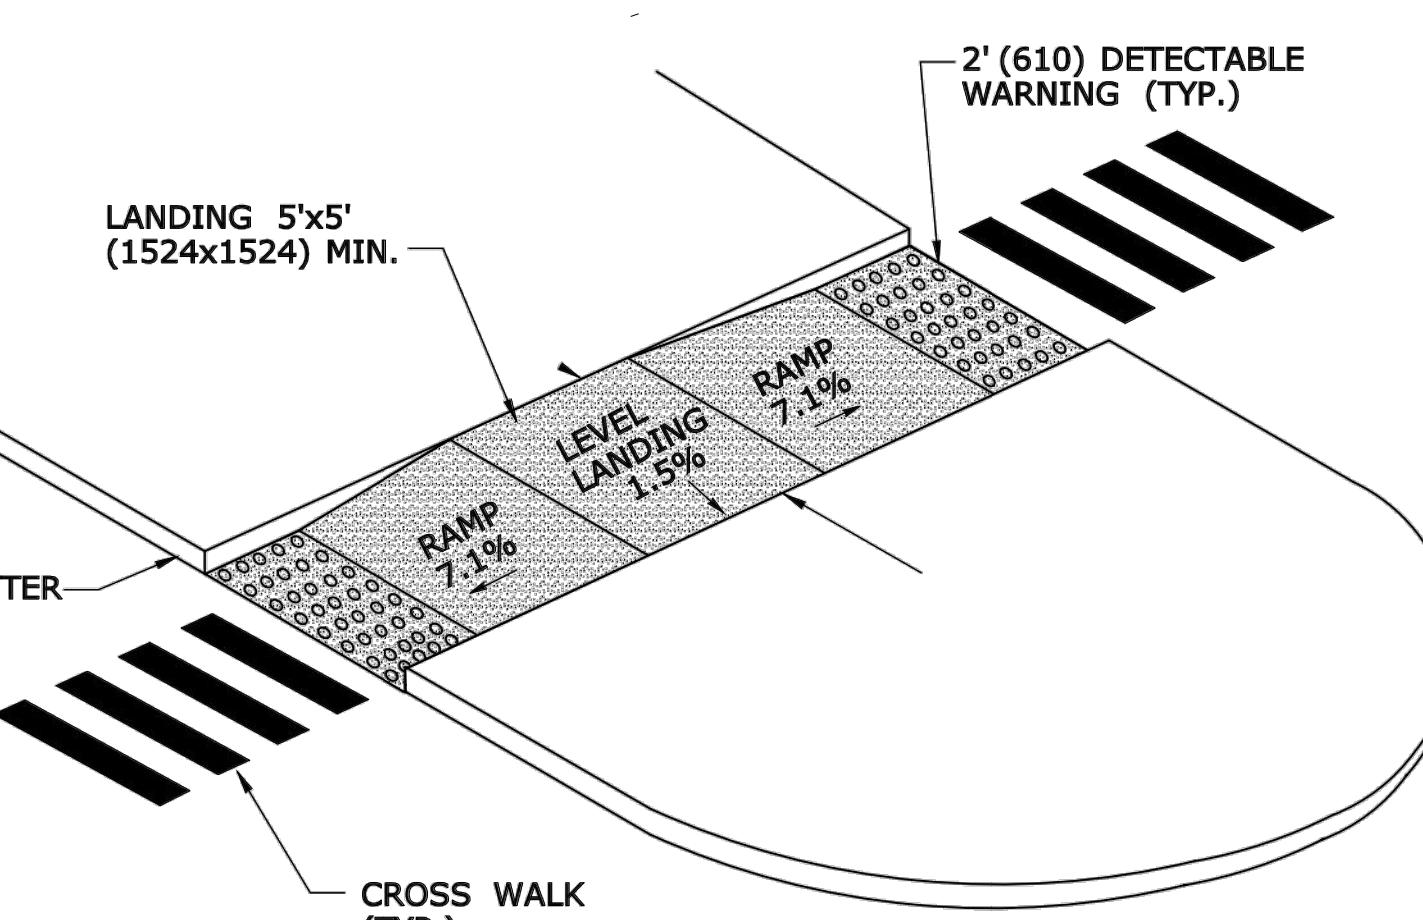


**RAISED MEDIAN ISLAND WITH
LANDING AND RAMPS**

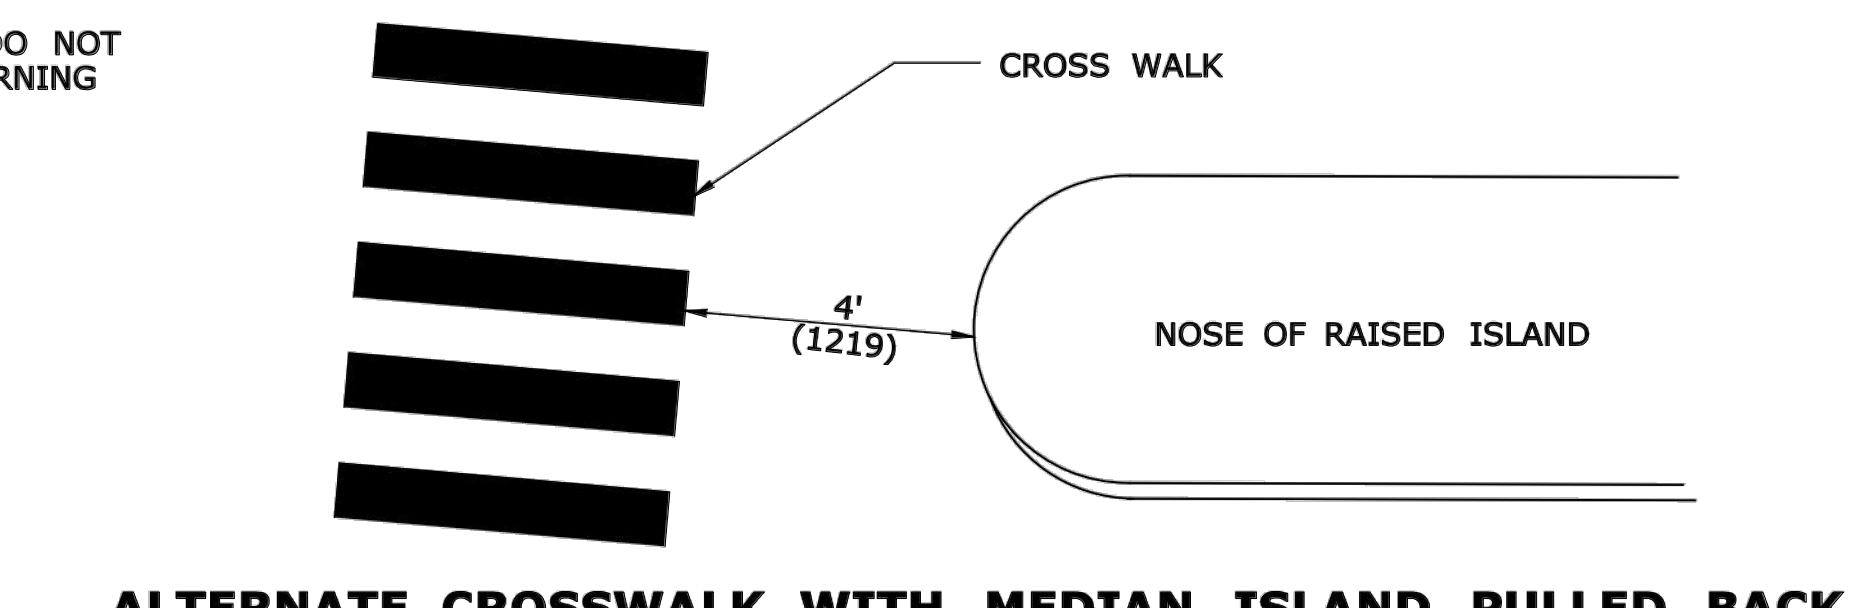

ALTERNATE CROSSWALK WITH MEDIAN ISLAND PULLED BACK

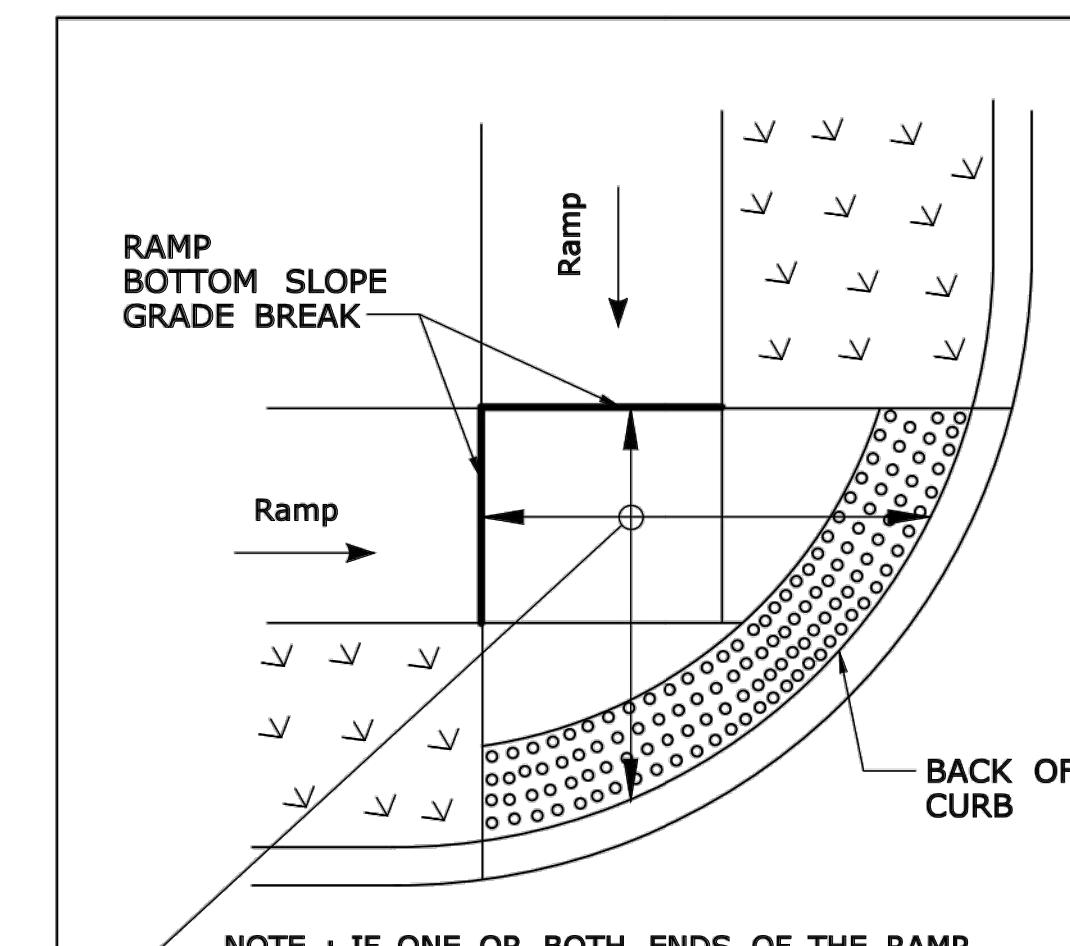

**DETECTABLE WARNING
PLACEMENT DETAIL 1**

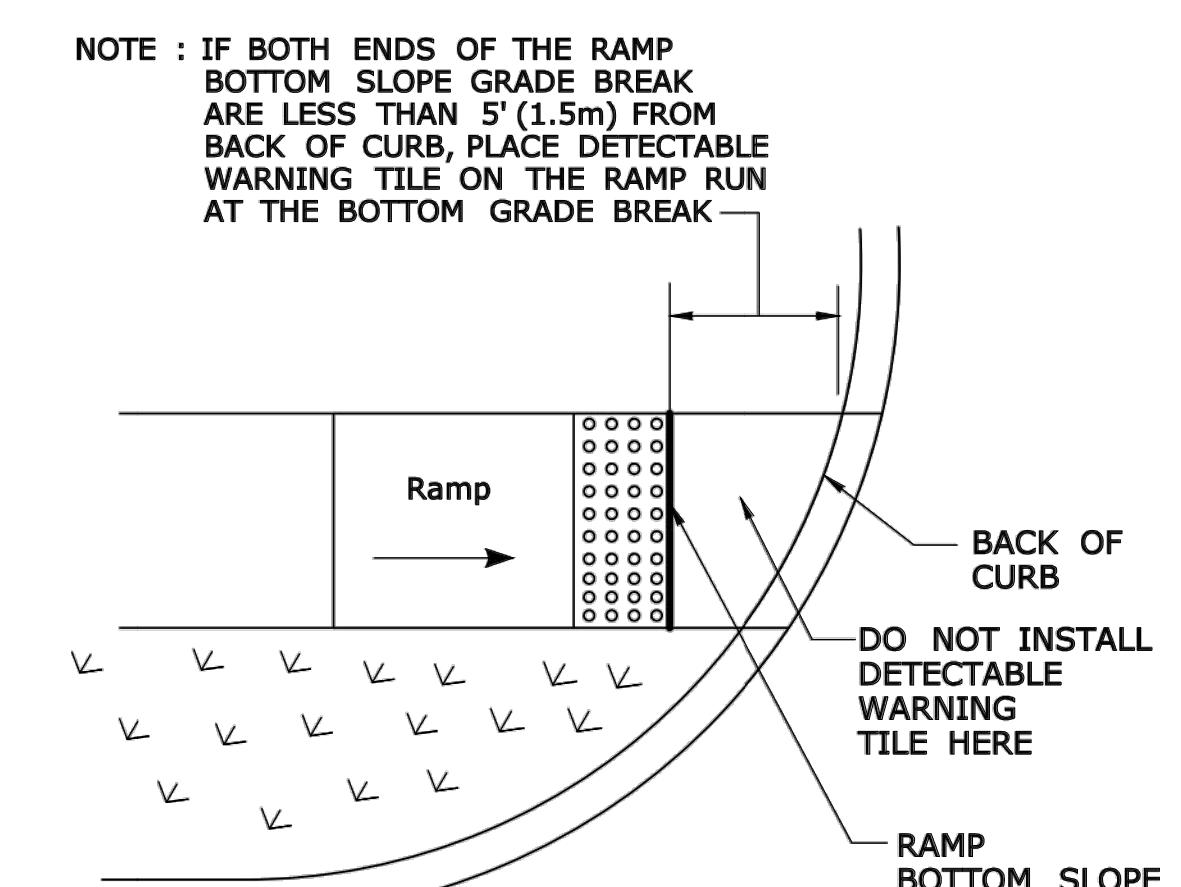

**DETECTABLE WARNING
PLACEMENT DETAIL 2**

ALL METRIC DIMENSIONS ARE IN MILLIMETERS (mm) UNLESS OTHERWISE NOTED

REV.	DATE	REVISION DESCRIPTION	SHEET NO.
			Plotted Date: 5/27/2014

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DESIGNER/DRAFTER: **MGB/EMK**
CHECKED BY: **LLF**

STATE OF CONNECTICUT
DEPARTMENT OF TRANSPORTATION


SIGNATURE/ BLOCK:
OFFICE OF ENGINEERING
APPROVED BY:
Tighe&Bond
www.tighebond.com

Filename: ...SIDEWALK RAMP 4.GD.dgn

PROJECT TITLE: **WHITNEY AVENUE AT
MAIN STREET (ROUTE 111)
INTERSECTION IMPROVEMENTS**





TOWN: **TRUMBULL**
DRAWING TITLE: **SIDEWALK RAMP
SHEET 4**

PROJECT NO. **T0196-116**
DRAWING NO.
SHEET NO. **SHEET 14**

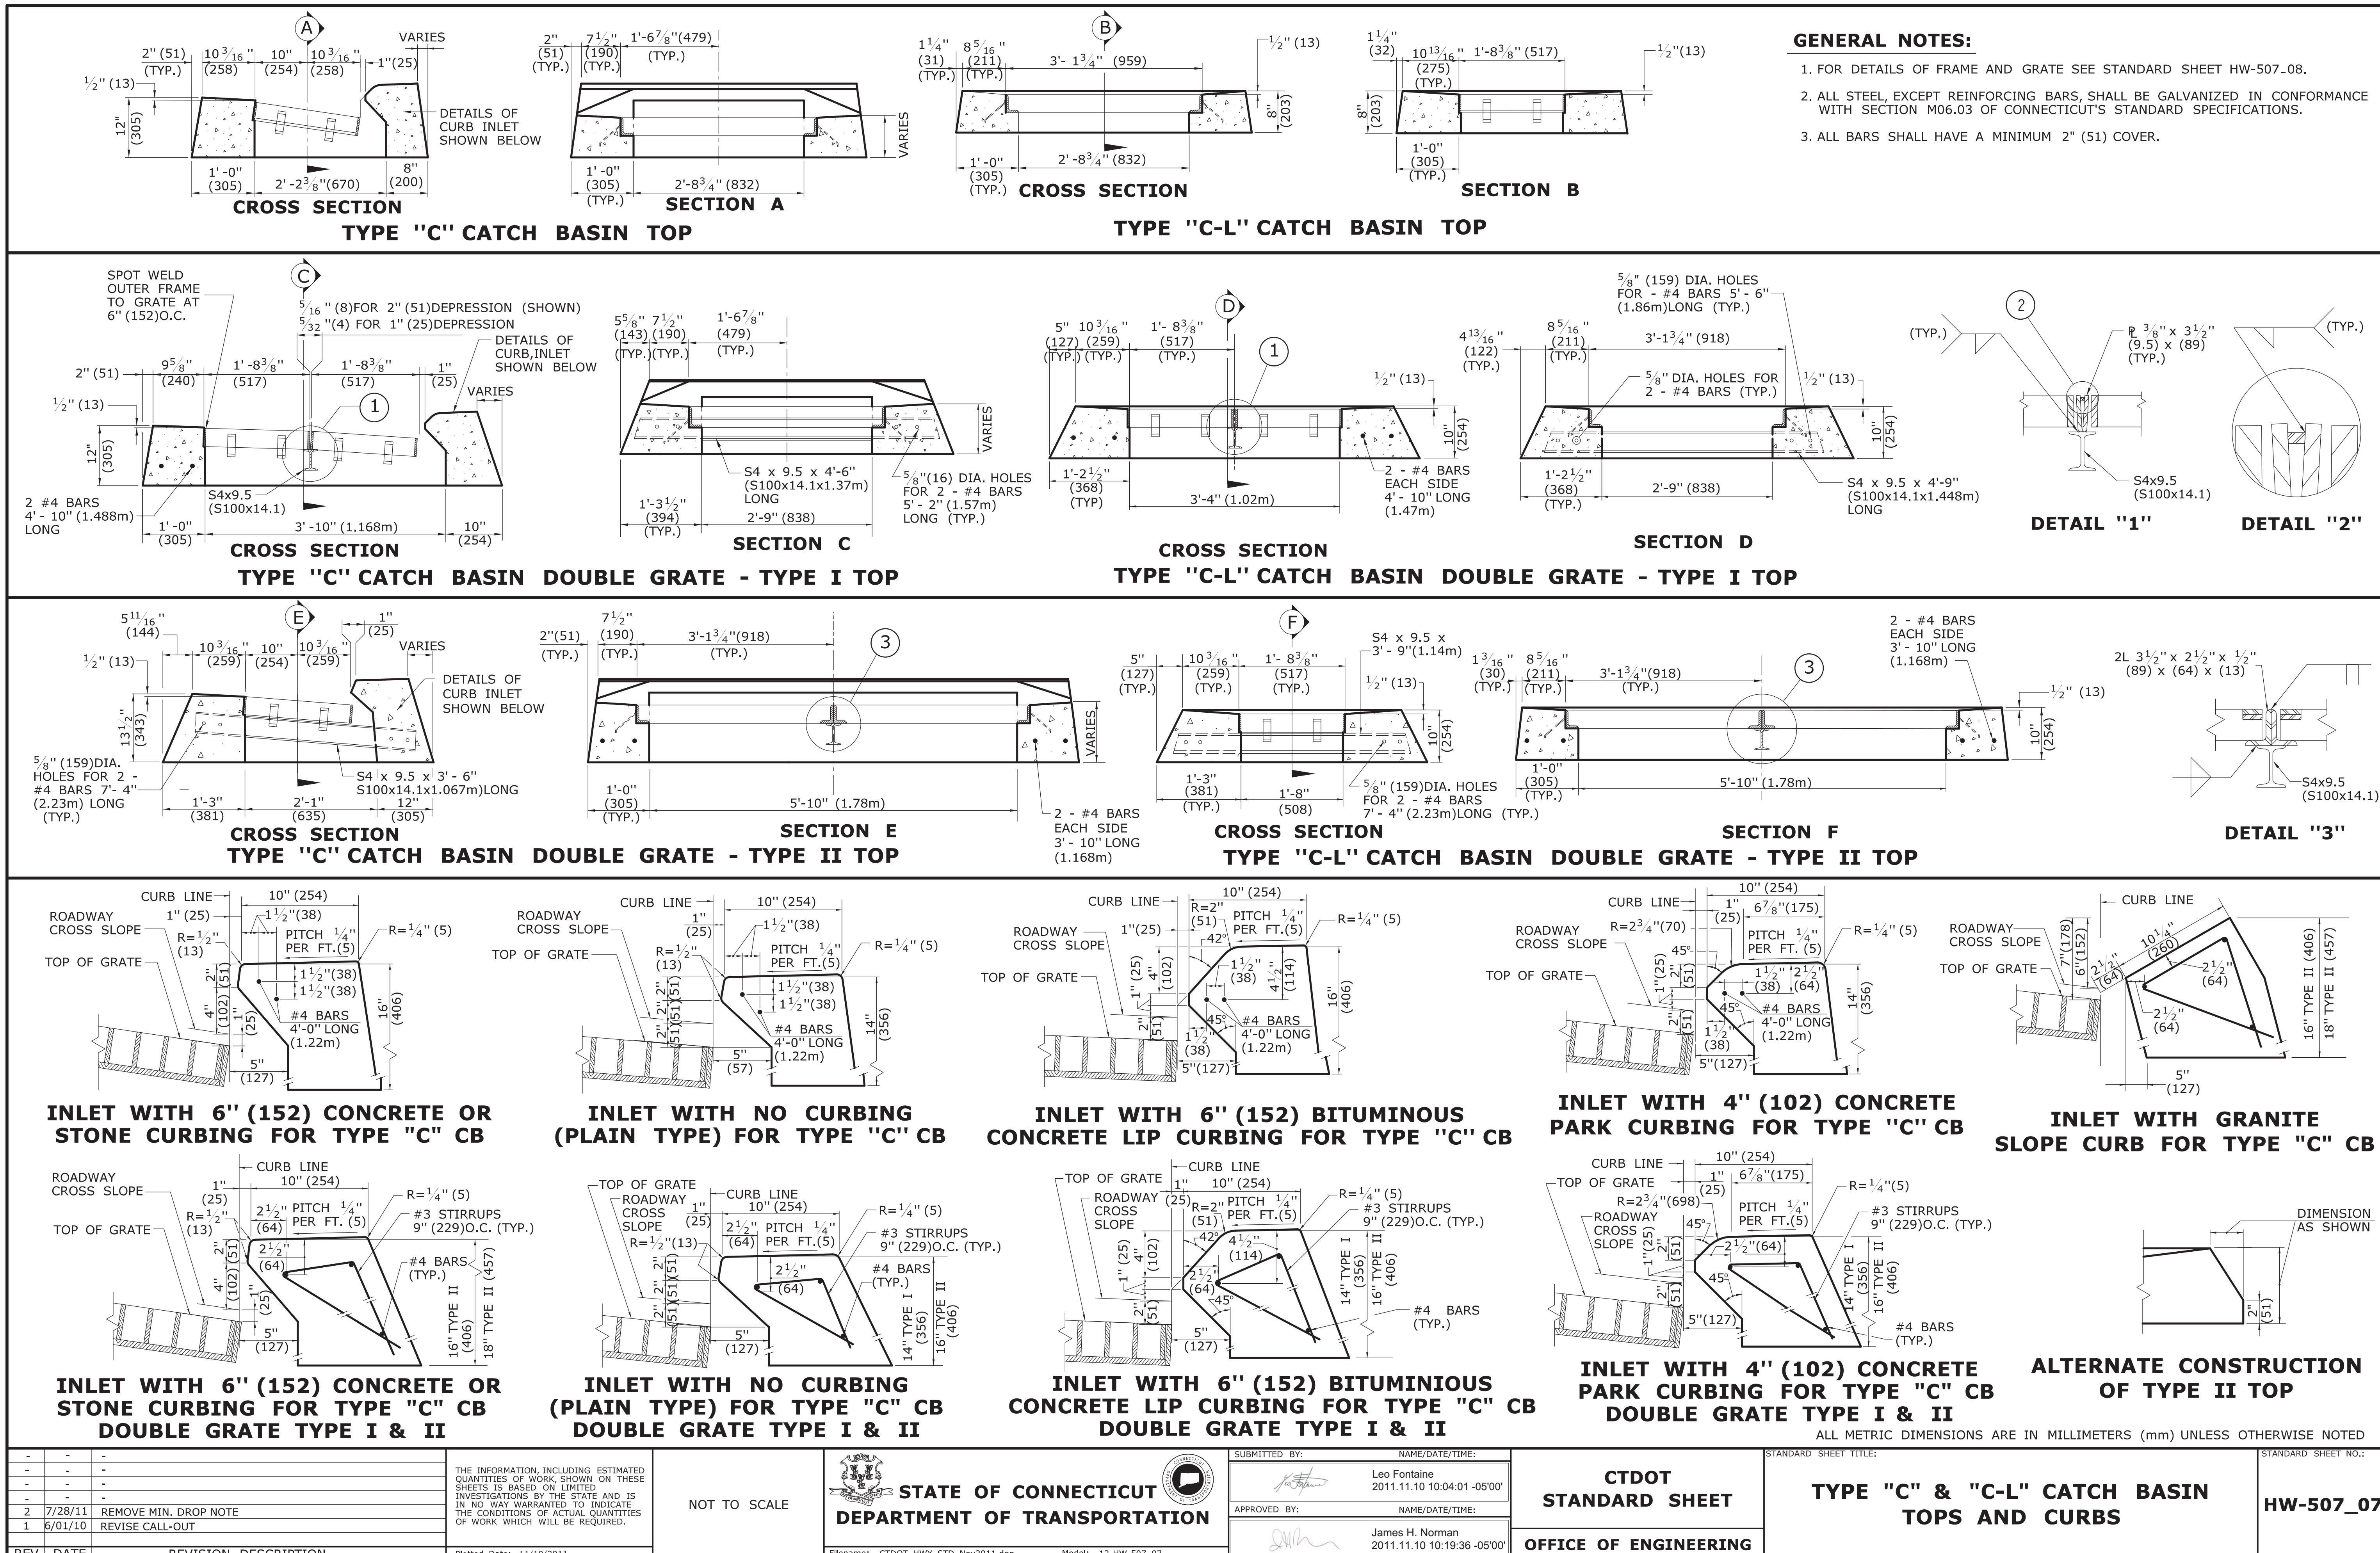

GENERAL NOTES:

- CHANNELS MAY BE SHAPED IN CONCRETE BASE OF MANHOLE OR FORMED USING BRICK OR MASONRY.
- A FRAME DIAMETER OF 3'-3" (991) WITH 4" (102) FLANGE MUST BE USED WHEN THE TOP DIAMETER OF THE PRECAST CONE IS LESS THAN 3'-6" (1067). ALL OTHER FRAME DIMENSIONS SHALL REMAIN THE SAME.
- COVER: CAST IRON STEEL
MIN. COVER WEIGHT 134LB.(61kg) 134LB.(61kg)
- ALL DIMENSIONS SUBJECT TO MANUFACTURING TOLERANCES.

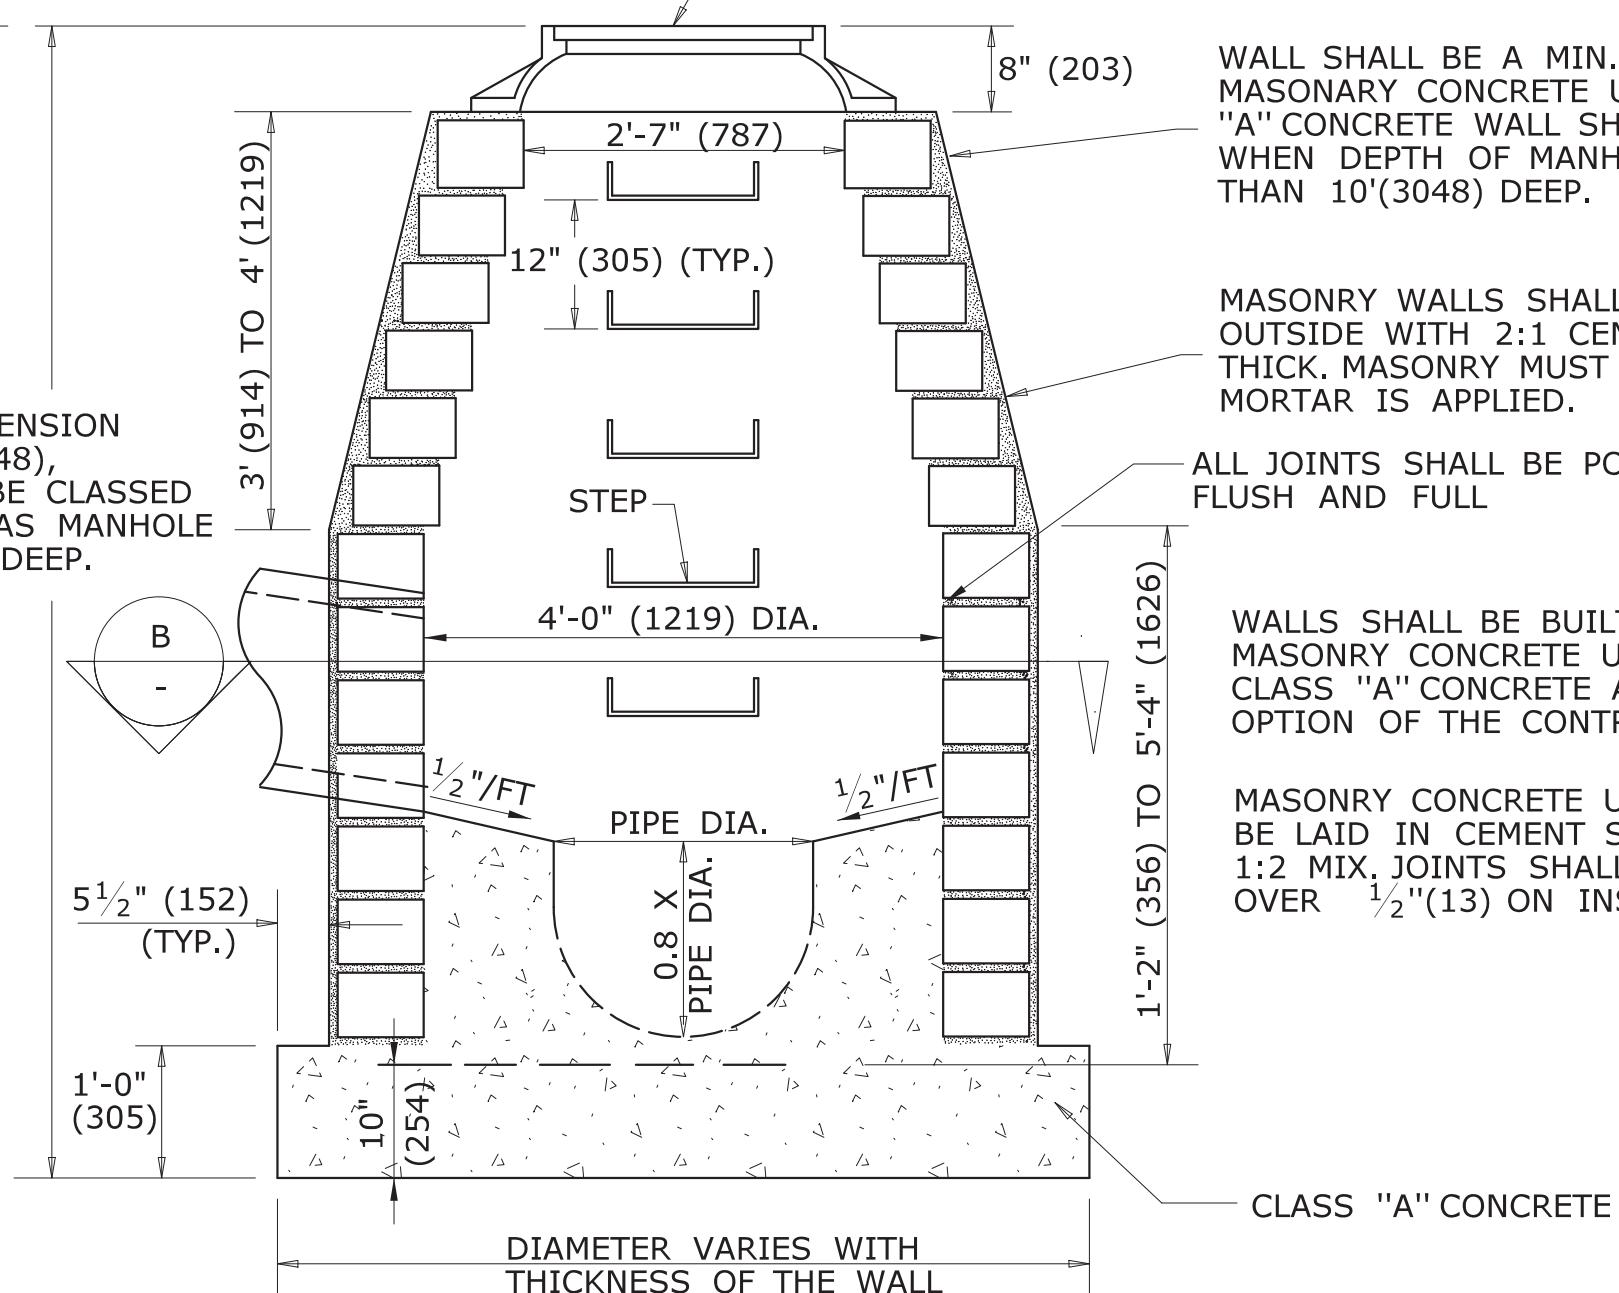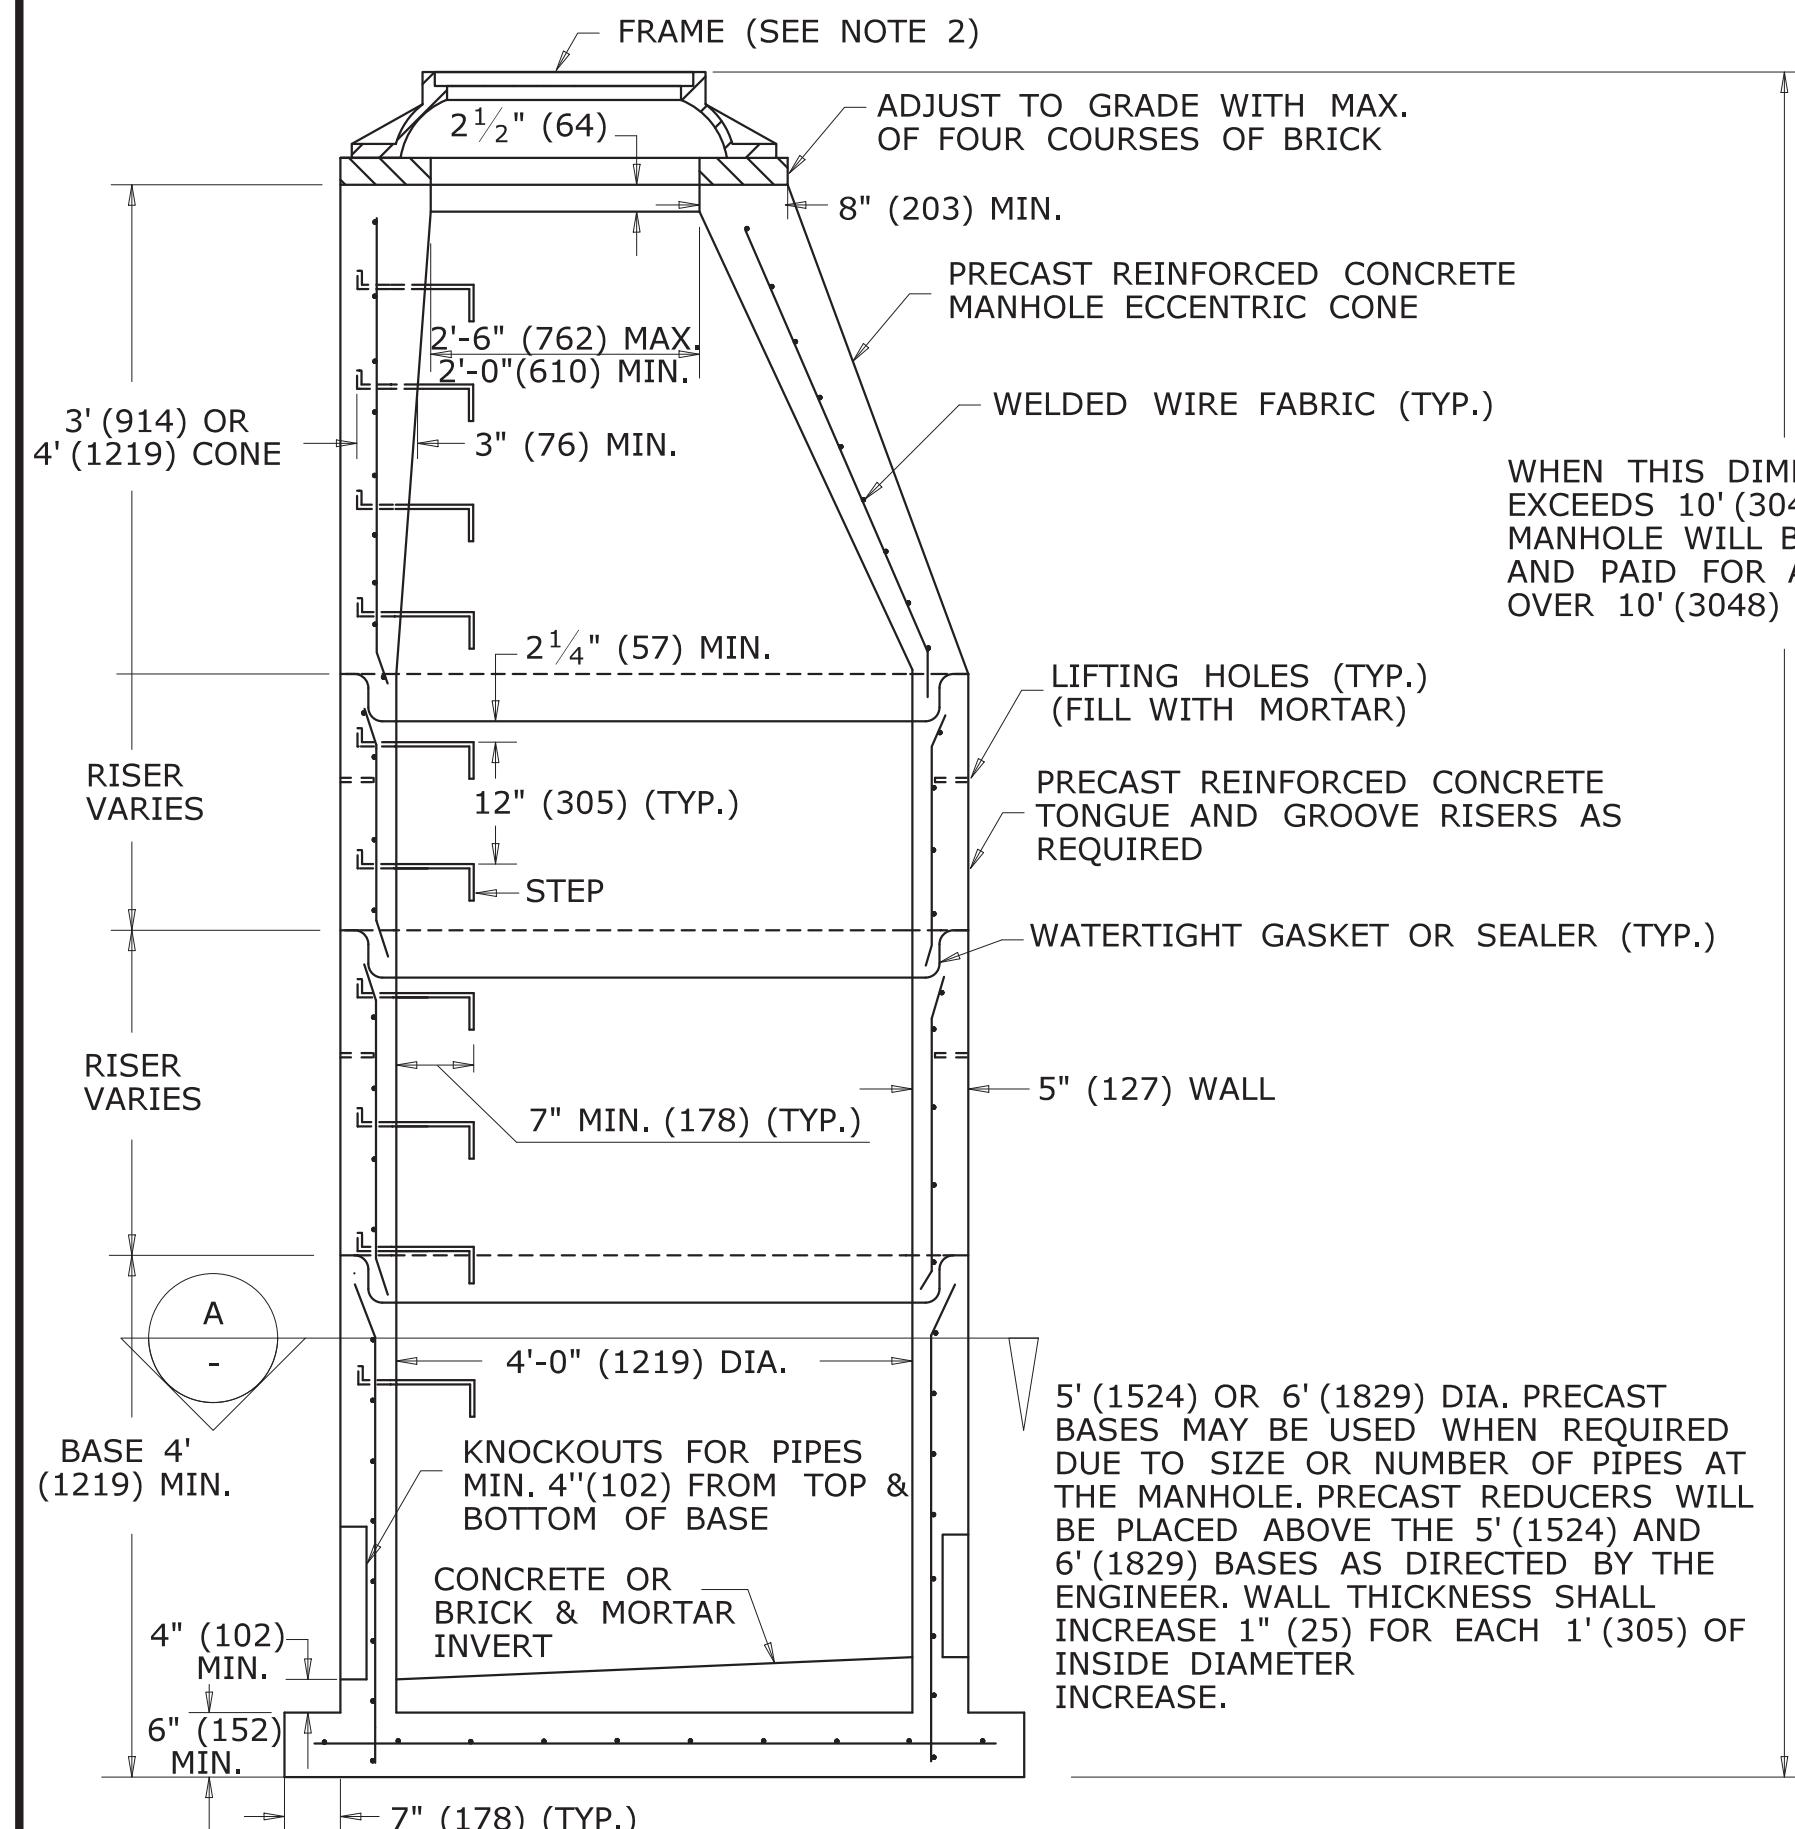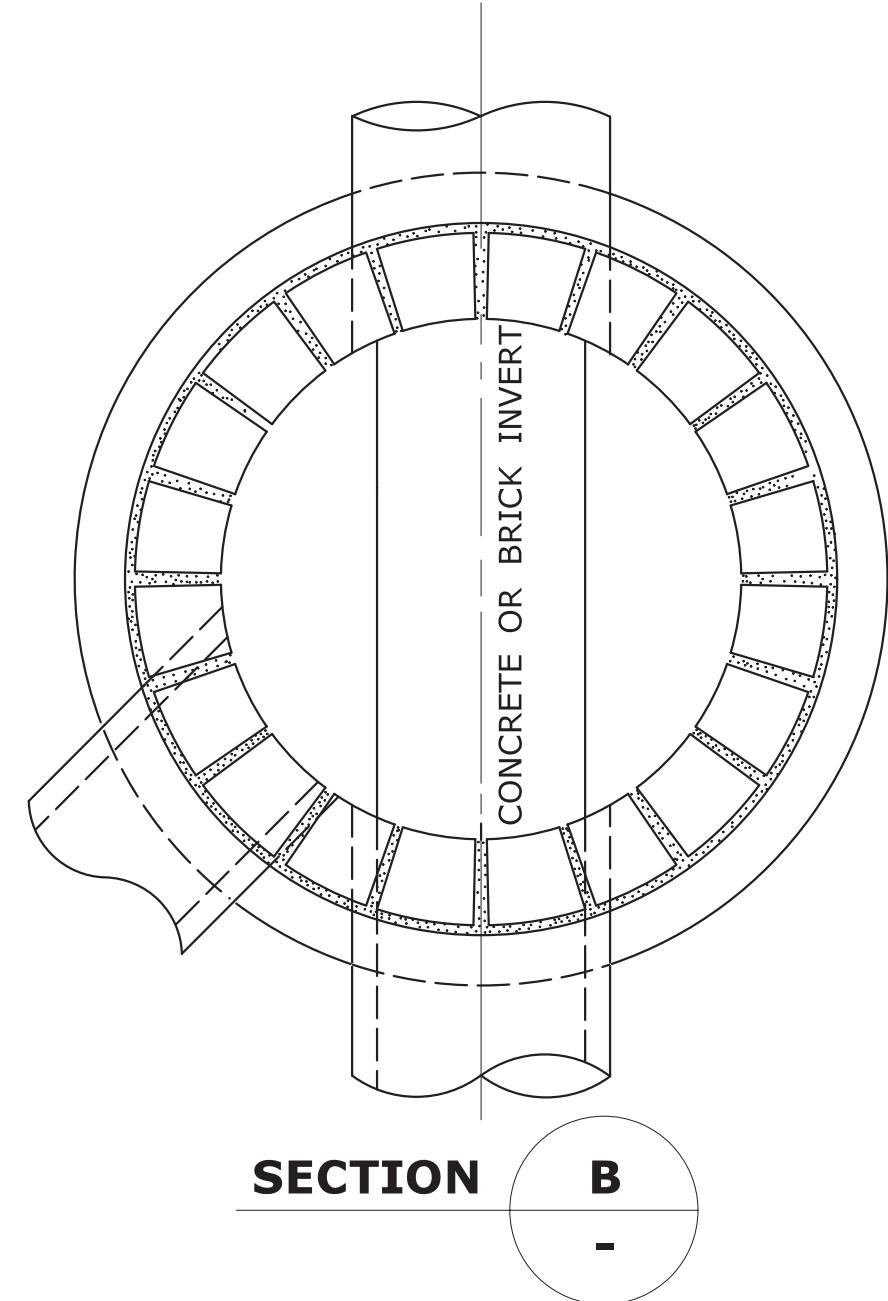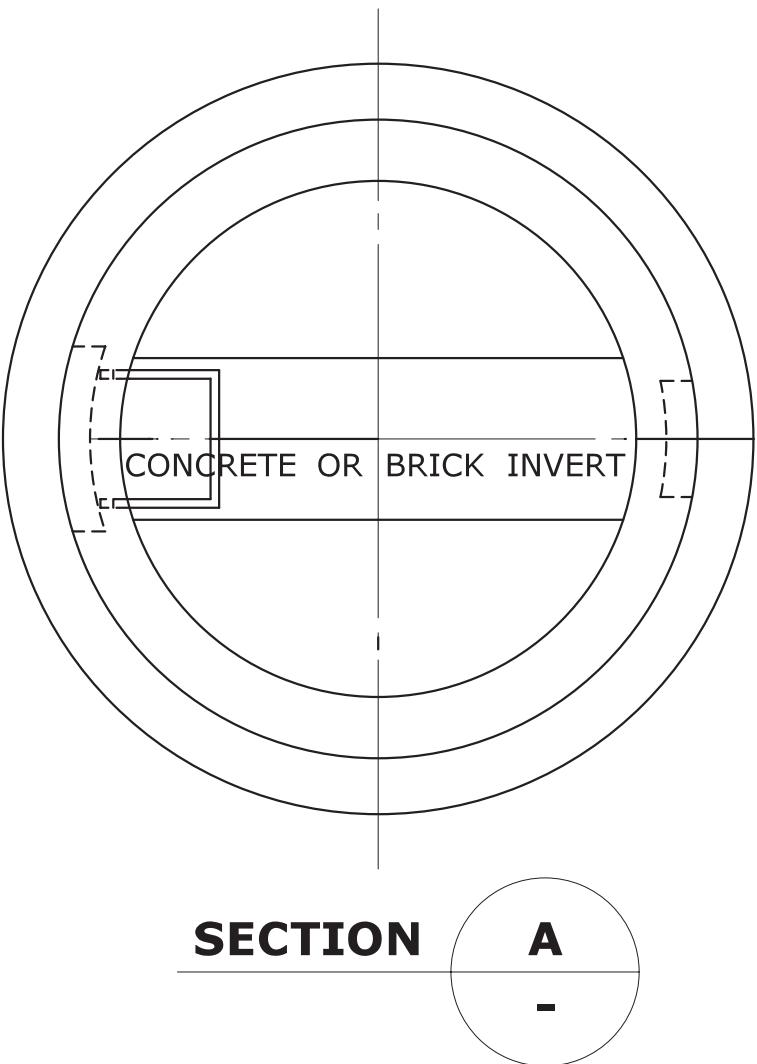

WALL SHALL BE A MIN. OF 6"(152) WITH MASONRY CONCRETE UNITS. CLASS "A" CONCRETE WALL SHALL BE 12"(300) THICK WHEN DEPTH OF MANHOLE IS GREATER THAN 10'(3048) DEEP.

MASONRY WALLS SHALL BE PLASTERED OUTSIDE WITH 2:1 CEMENT MORTAR $\frac{1}{2}$ "(13) THICK. MASONRY MUST BE WET WHEN MORTAR IS APPLIED.

ALL JOINTS SHALL BE POINTED FLUSH AND FULL

WALLS SHALL BE BUILT OF MASONRY CONCRETE UNITS OR CLASS "A" CONCRETE AT THE OPTION OF THE CONTRACTOR.

MASONRY CONCRETE UNITS SHALL BE LAID IN CEMENT SAND MORTAR 1:2 MIX. JOINTS SHALL NOT BE OVER $\frac{1}{2}$ "(13) ON INSIDE FACE



CLASS "A" CONCRETE

DIAMETER VARIES WITH THICKNESS OF THE WALL


ELEVATION

MANHOLE


MASONRY CONCRETE UNIT OR CLASS "A" CONCRETE

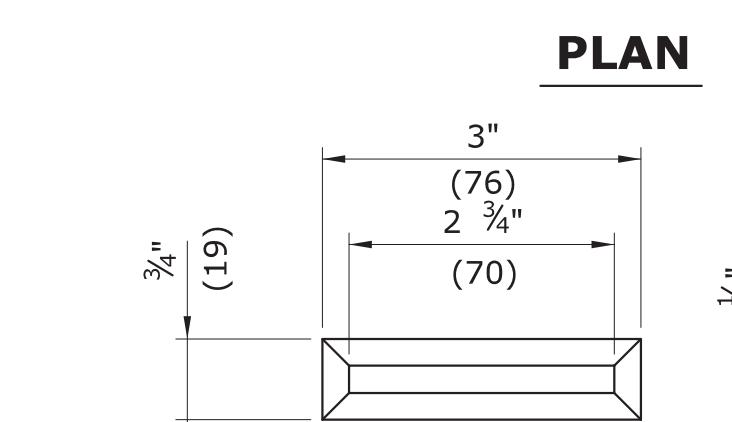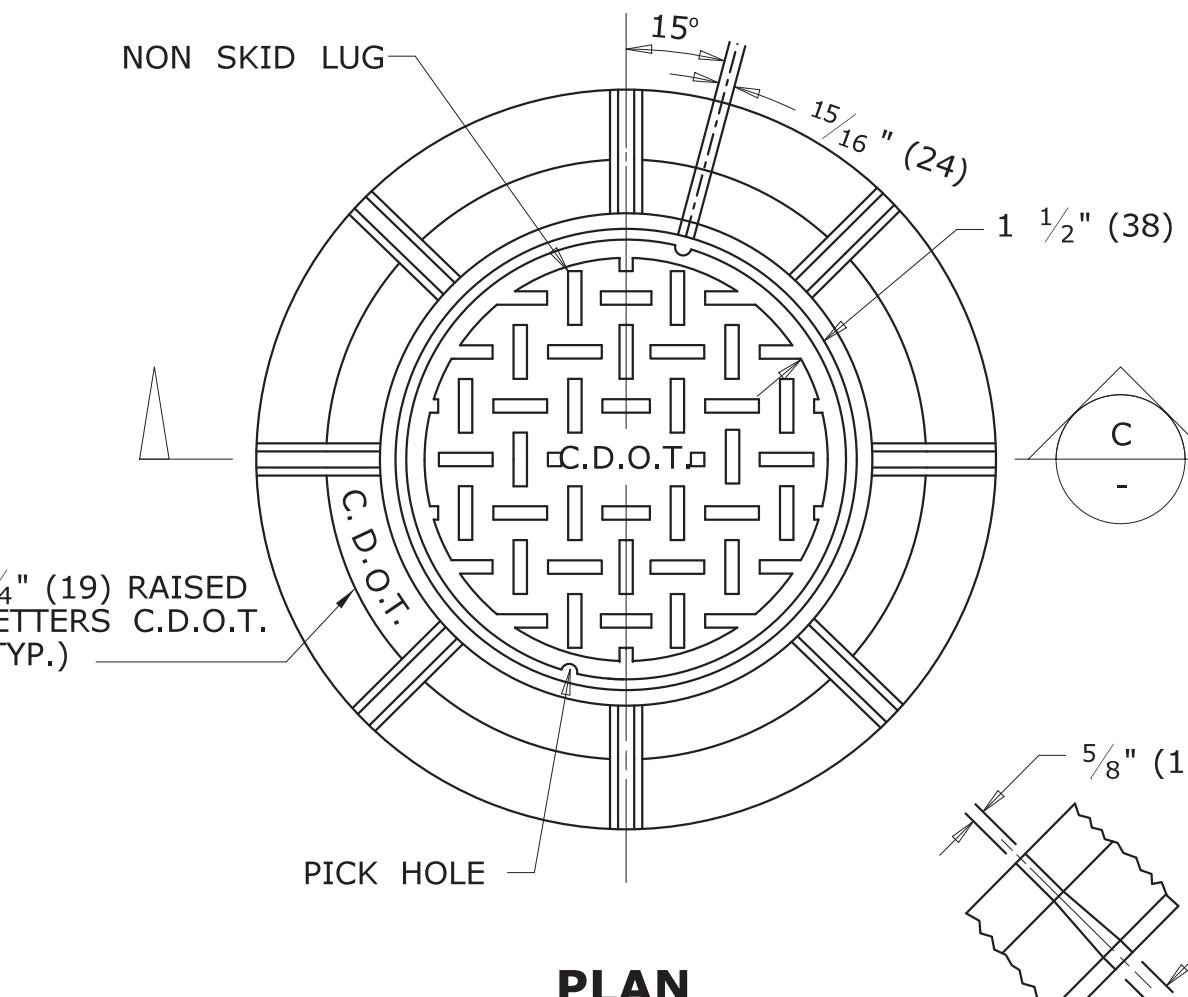

NON SKID LUG DETAIL

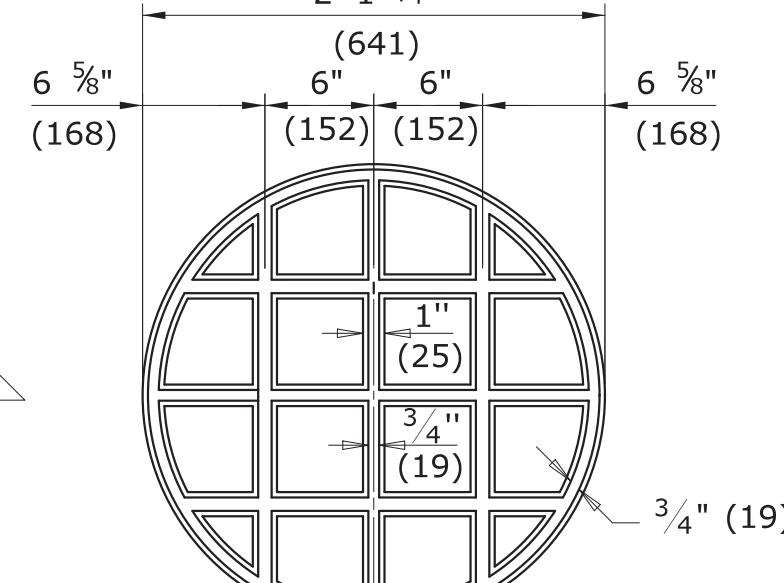

UNDERSIDE OF COVER DETAIL

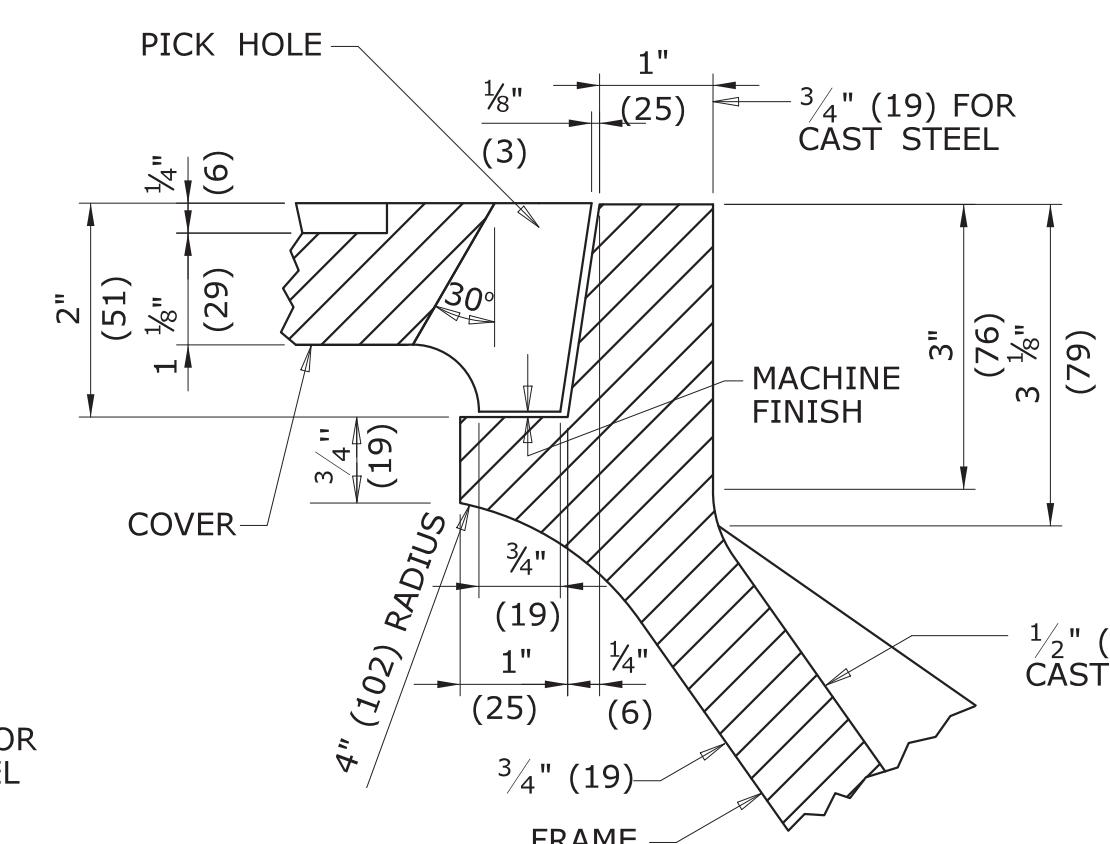

DETAIL OF SEAT



FRAME AND COVER DETAILS

STANDARD SHEET TITLE:		MANHOLE - FRAME & COVER		STANDARD SHEET NO.:	
CTDOT STANDARD SHEET	OFFICE OF ENGINEERING	HW-507_10			

1	6/11	REVISE STEP WIDTH PER OSHA
2	7/13	REVISE COVER FRAME WEIGHT
-	-	-
-	-	-
-	-	-
-	-	-

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Plotted Date: 6/13/2013

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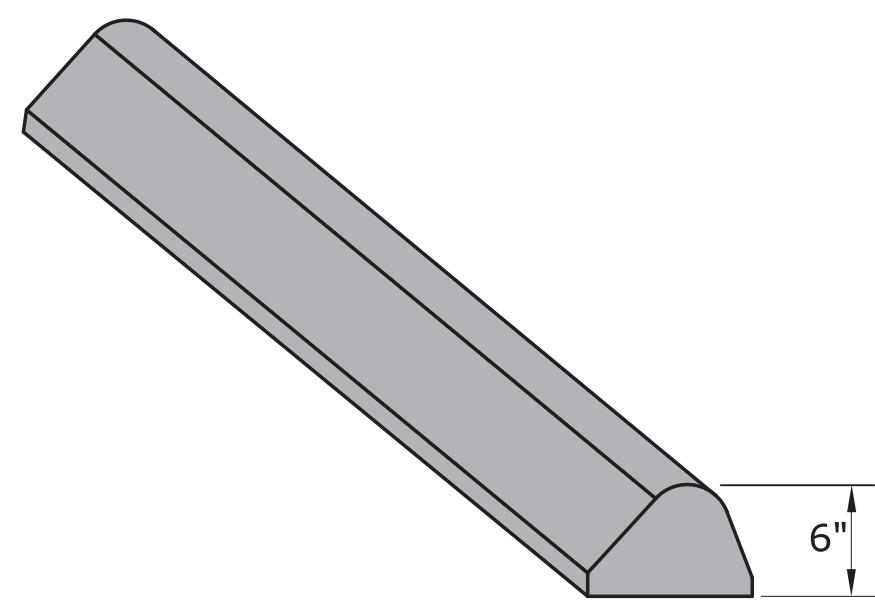


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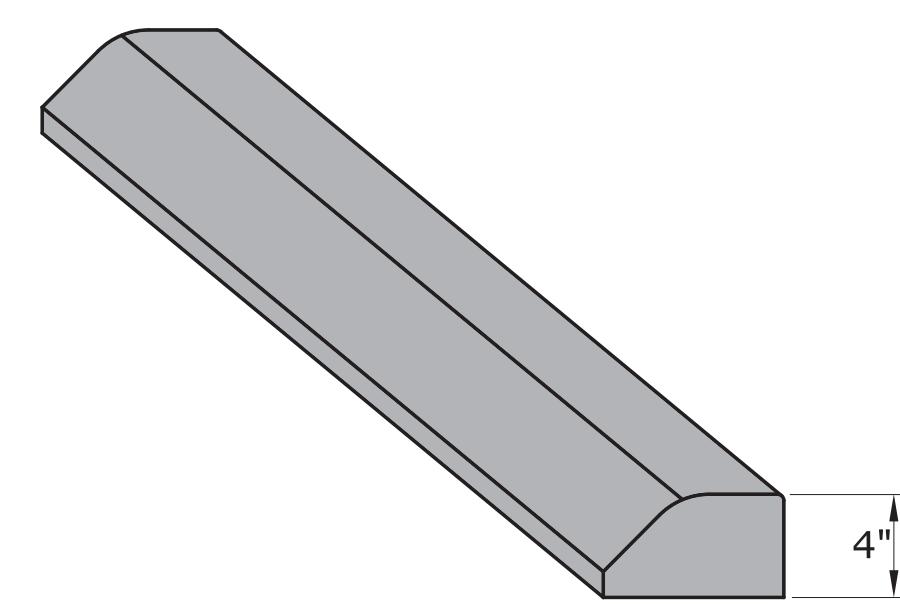
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APPROVED BY:	NAME/DATE/TIME:
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CTDOT
STANDARD SHEET
OFFICE OF ENGINEERING


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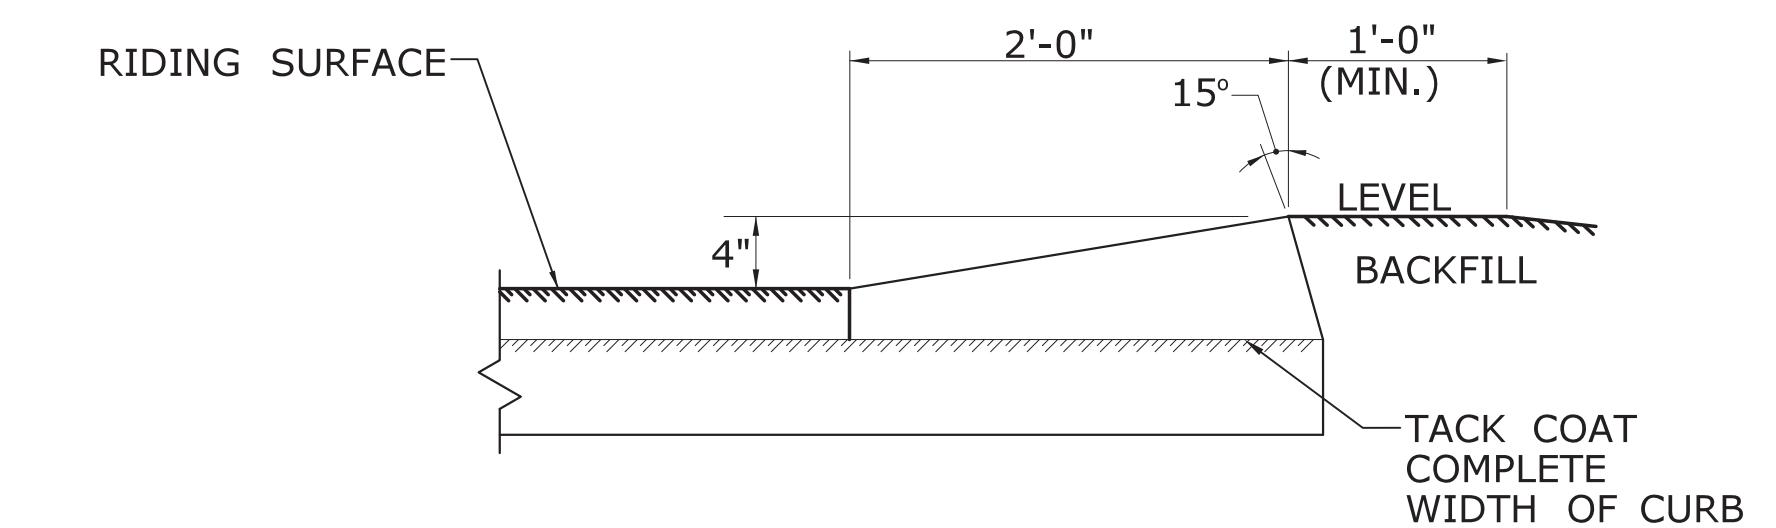
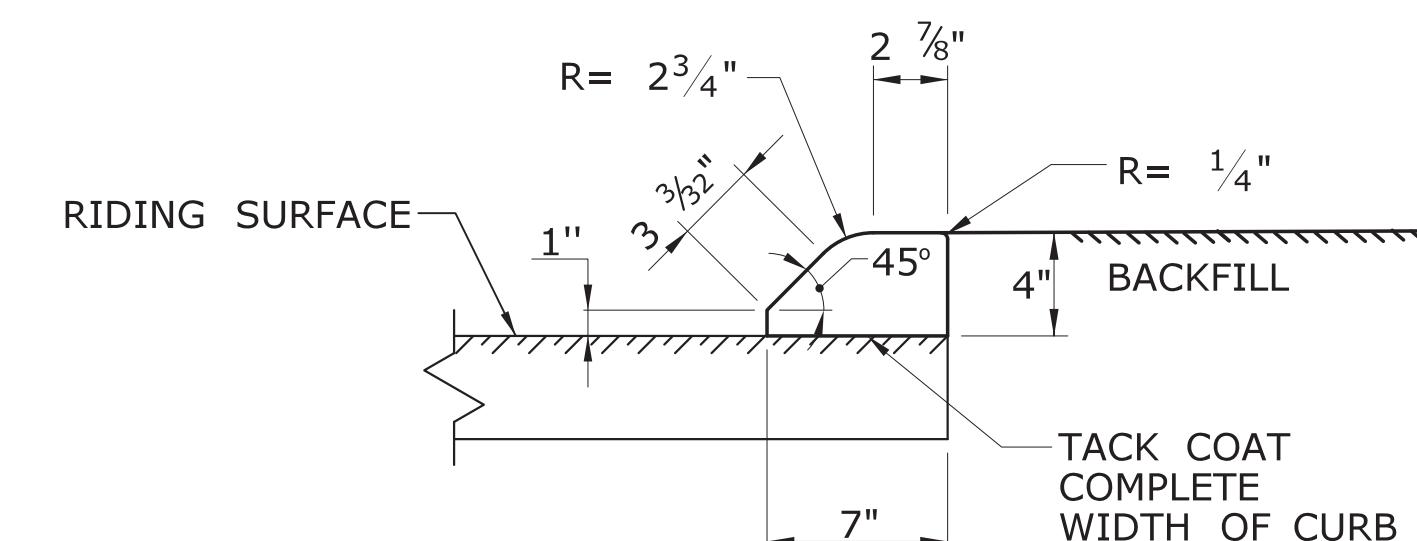
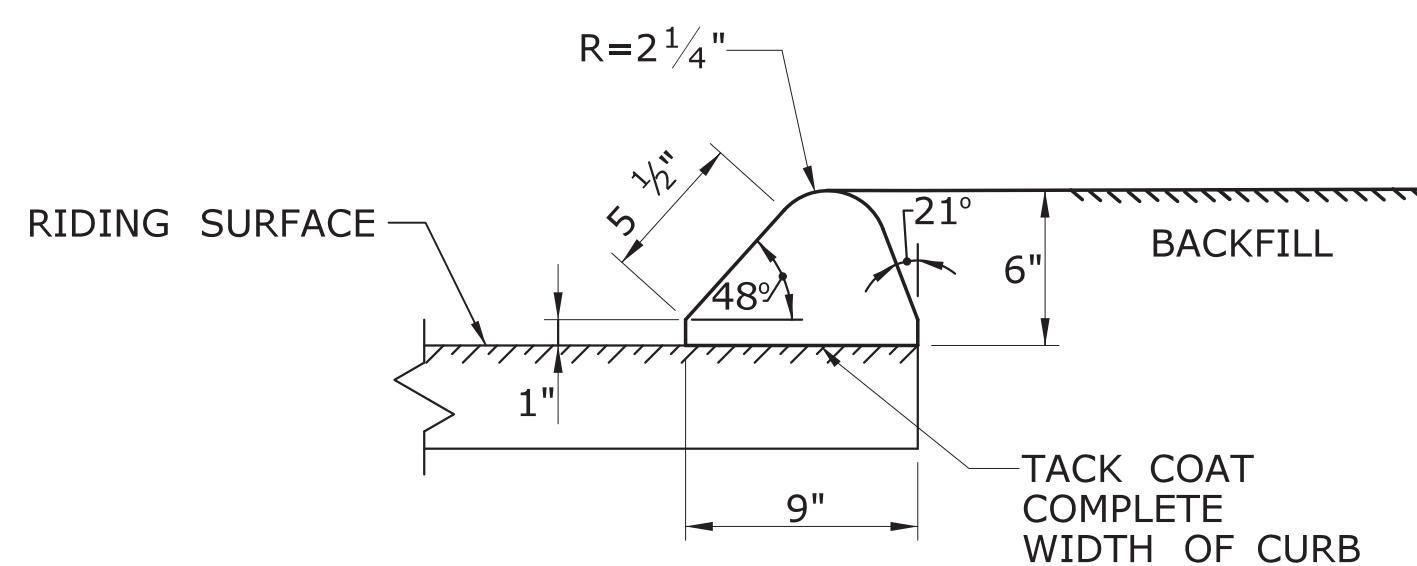
**BITUMINOUS CONCRETE LIP CURBING
(6" HIGH)**



**BITUMINOUS CONCRETE PARK CURBING
(4" HIGH)**



**BITUMINOUS CONCRETE BERM CURBING
(4" HIGH)**

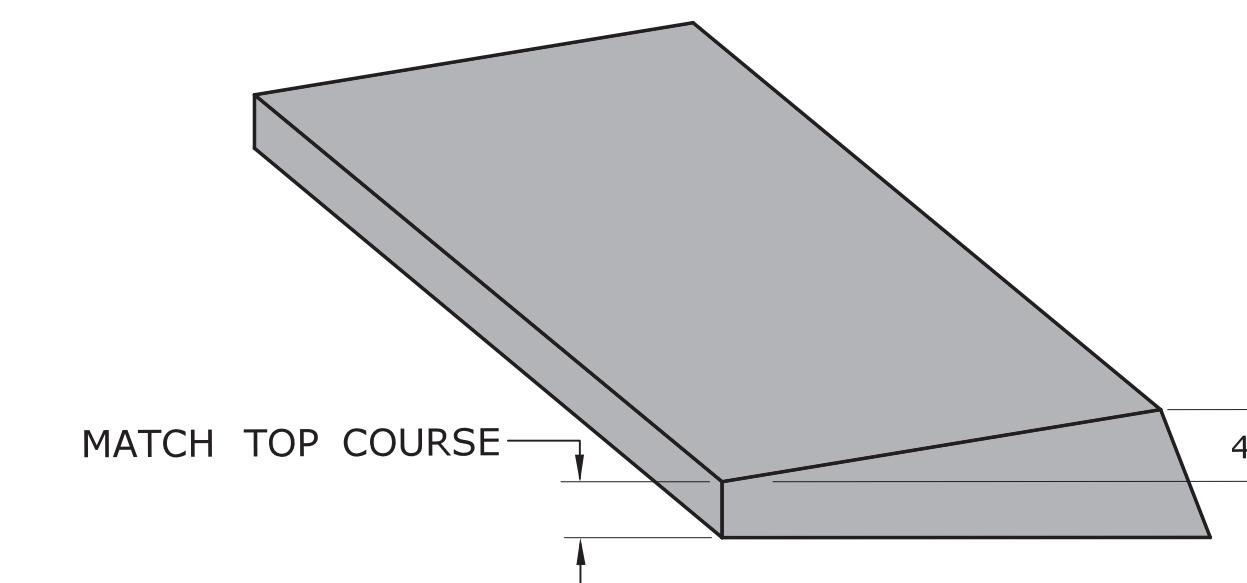

1	6/17	NEW SHEET

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NOT TO SCALE



Plotted Date: 6/6/2017

Model: CT-CIVL-2D_Sheet


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APPROVED BY:	NAME/DATE/TIME:
	Gregory M. Dorosh, P.E. 2017.06.07 10:44:27-04'00'

STANDARD SHEET TITLE:
**CTDOT
STANDARD SHEET**
OFFICE OF ENGINEERING




STANDARD SHEET NO.:
BITUMINOUS CONCRETE CURBING
HW-815_01

GENERAL NOTES:


1. DRIVEWAY ENTRANCE SHALL BE A MINIMUM OF 12' WIDE, EXCLUDING CURBING WHEN PRESENT.
2. WELDED WIRE FABRIC MATS WITH REINFORCING AT CLOSER SPACING MAY BE USED.
3. SURFACE HMA S0.375 TO BE PLACED IN TWO EQUAL LIFTS FOR BOTH RESIDENTIAL AND COMMERCIAL DRIVEWAYS.

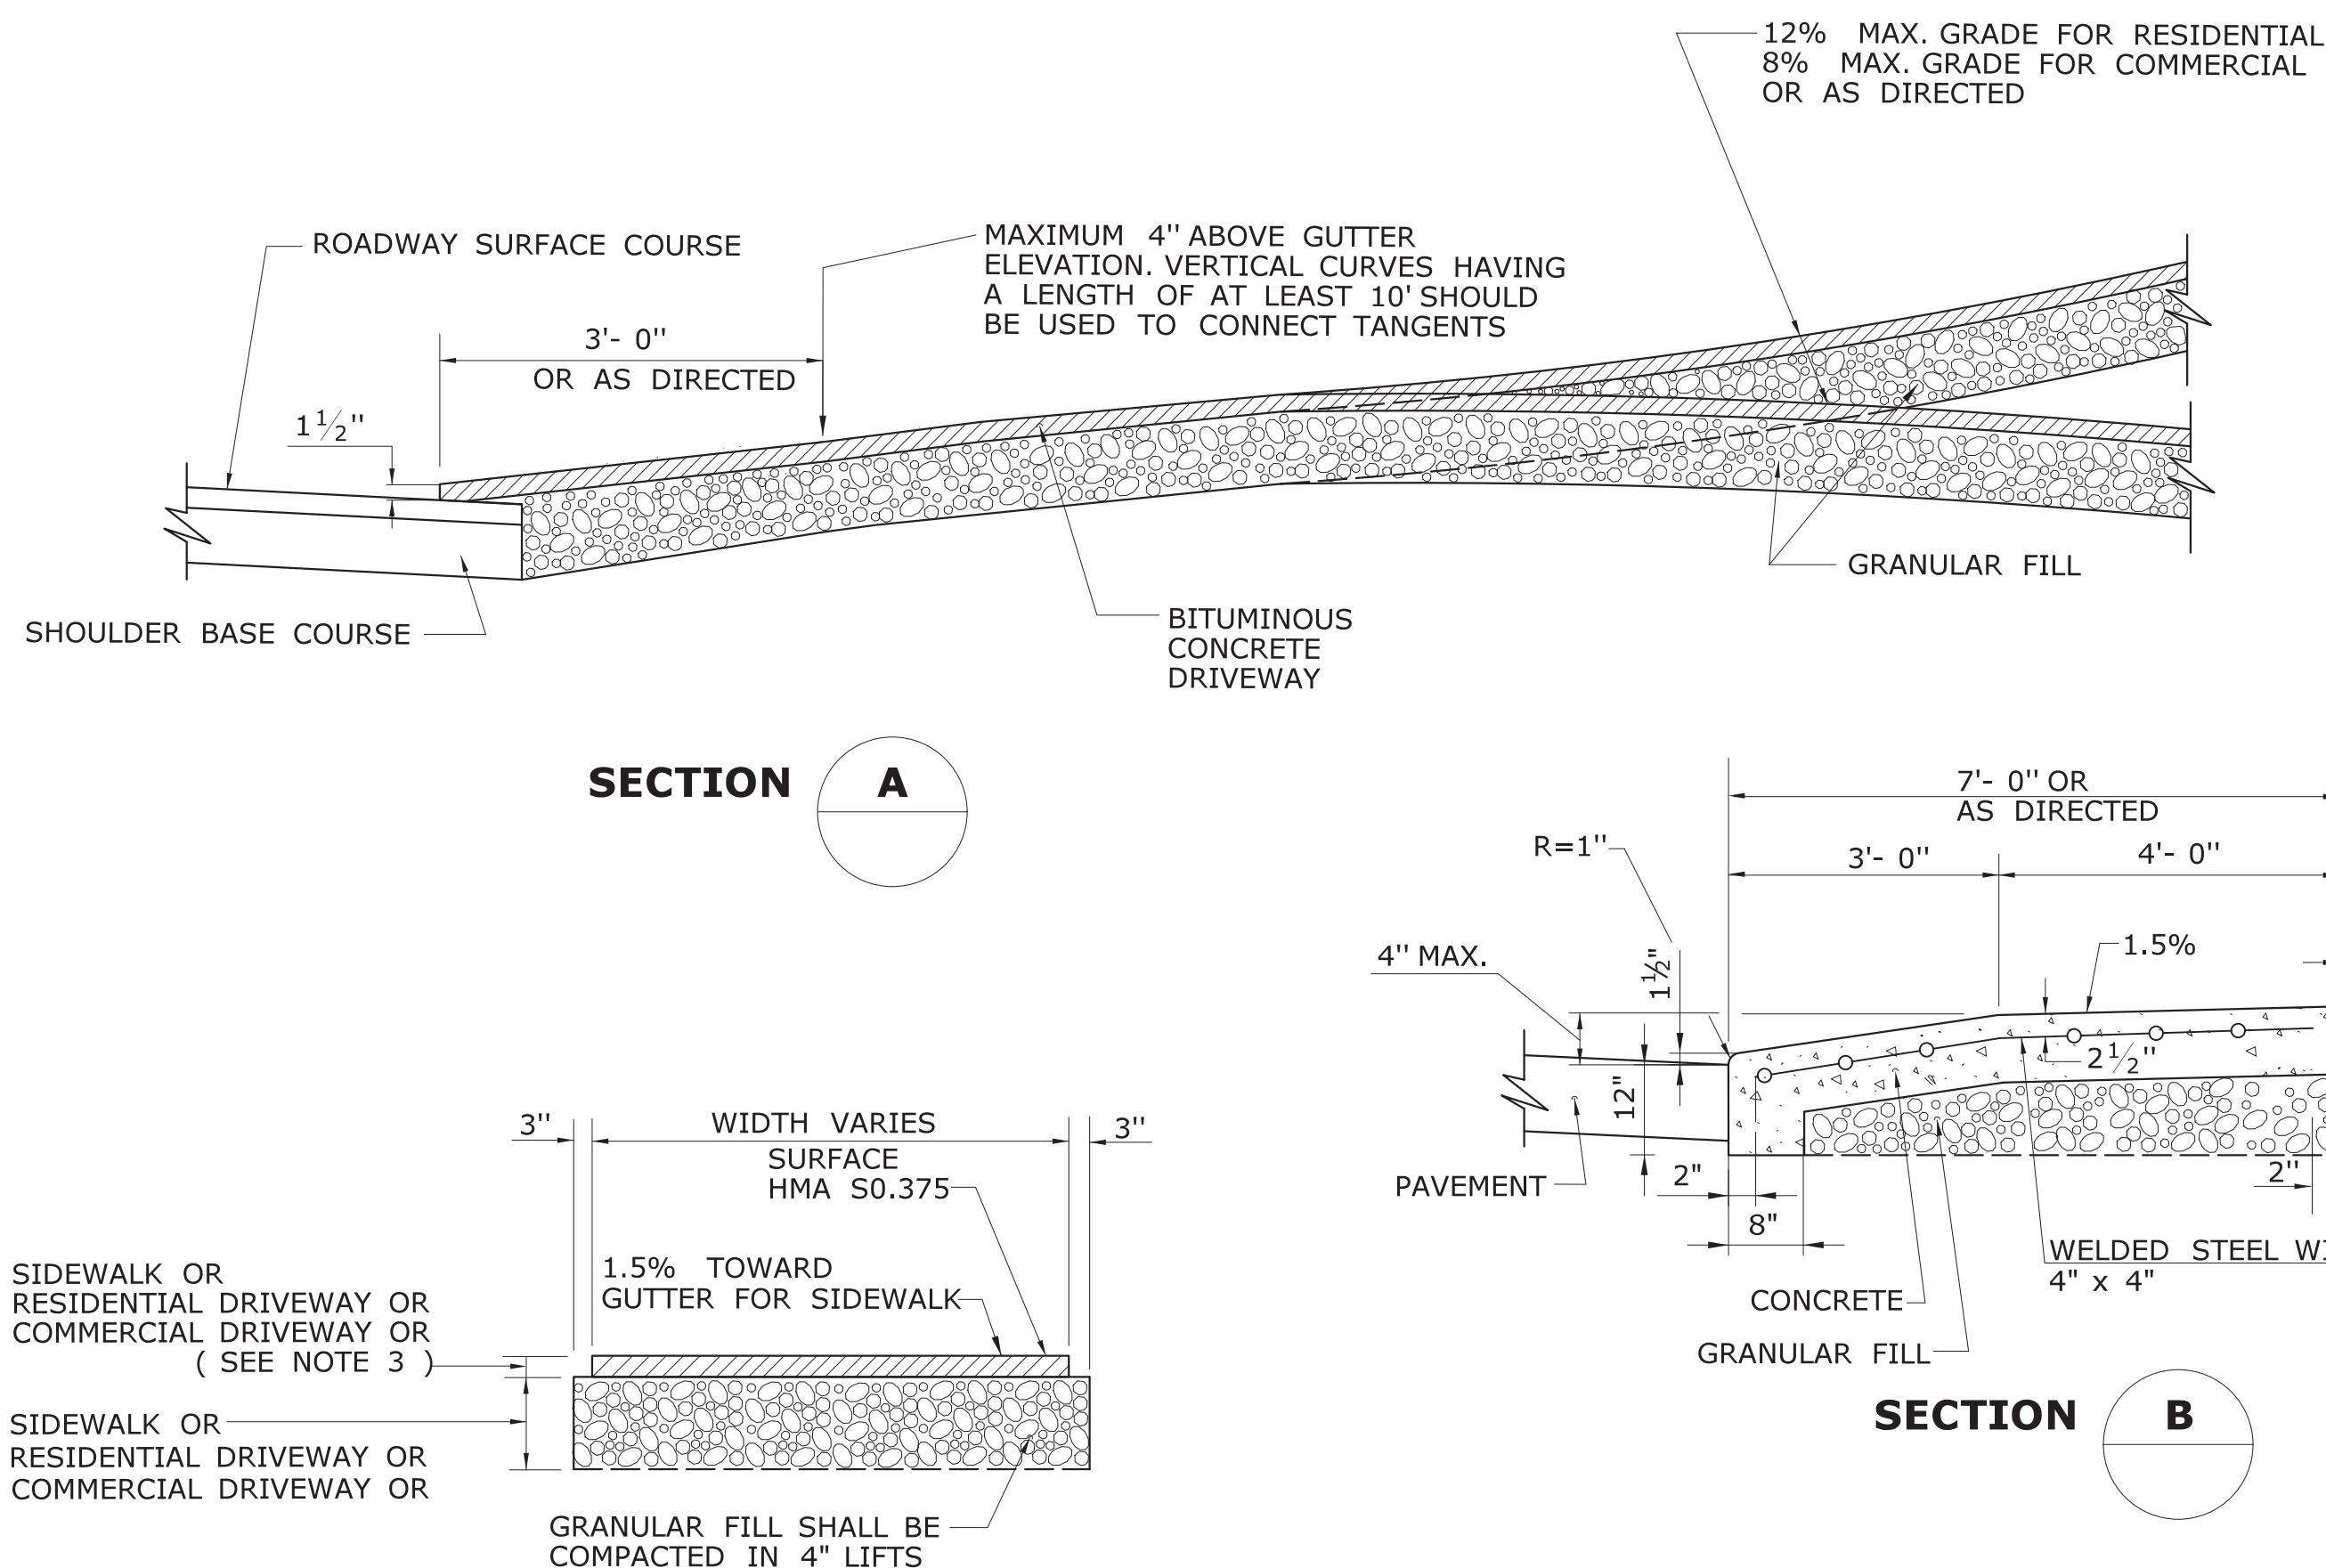


TYPICAL SECTION
BITUMINOUS CONCRETE
SIDEWALK AND DRIVEWAY

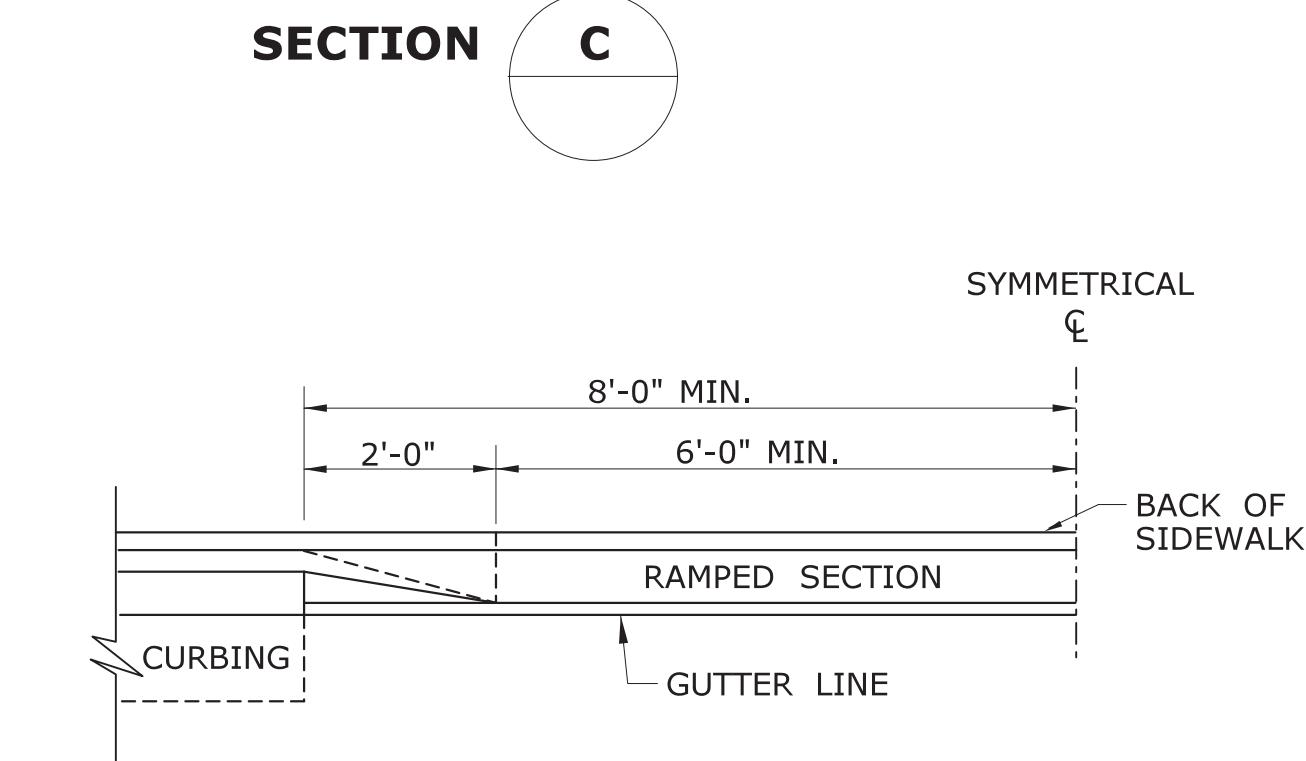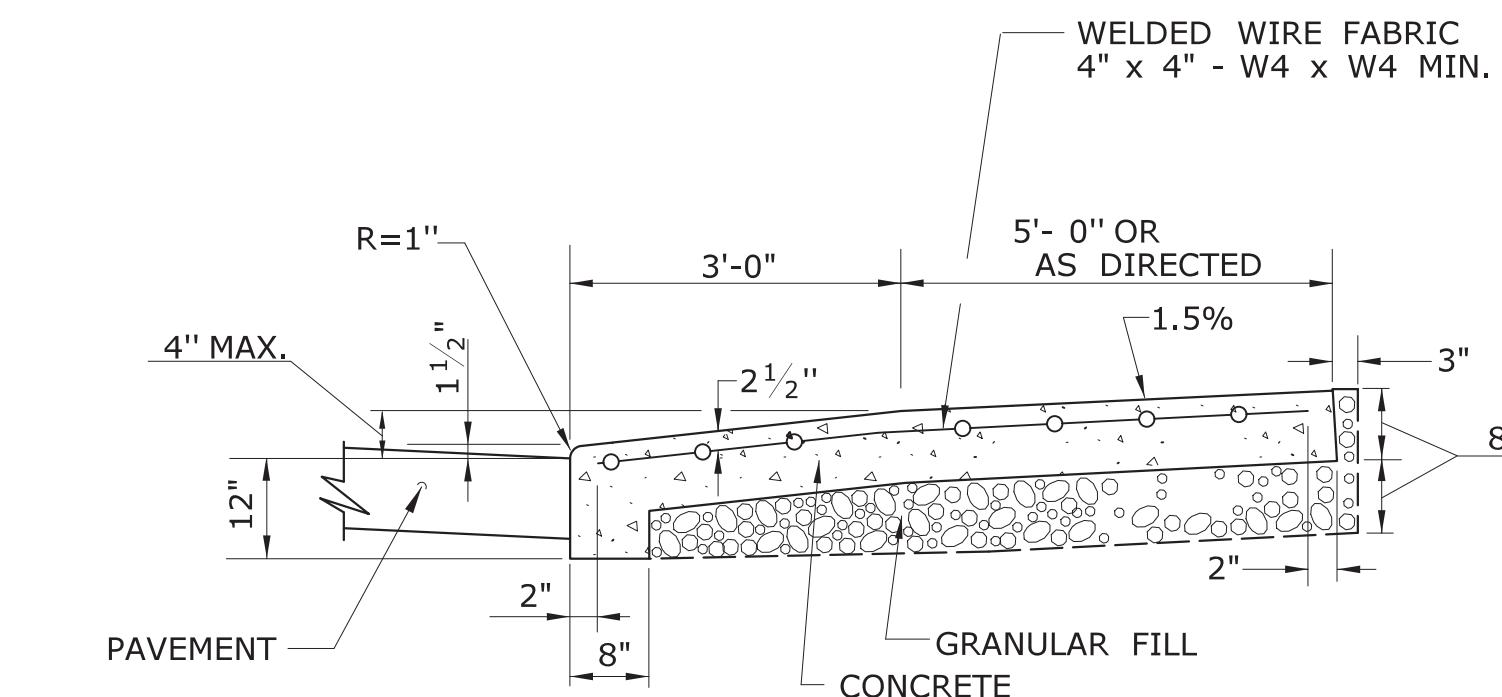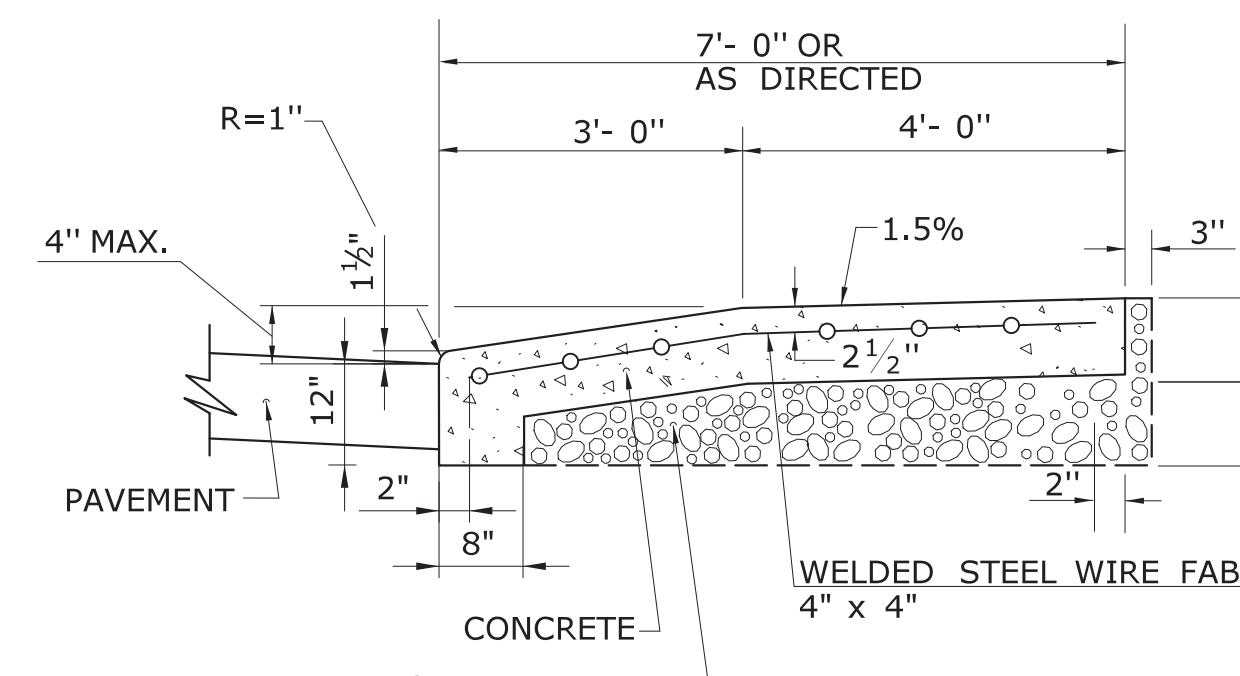


HALF ELEVATION

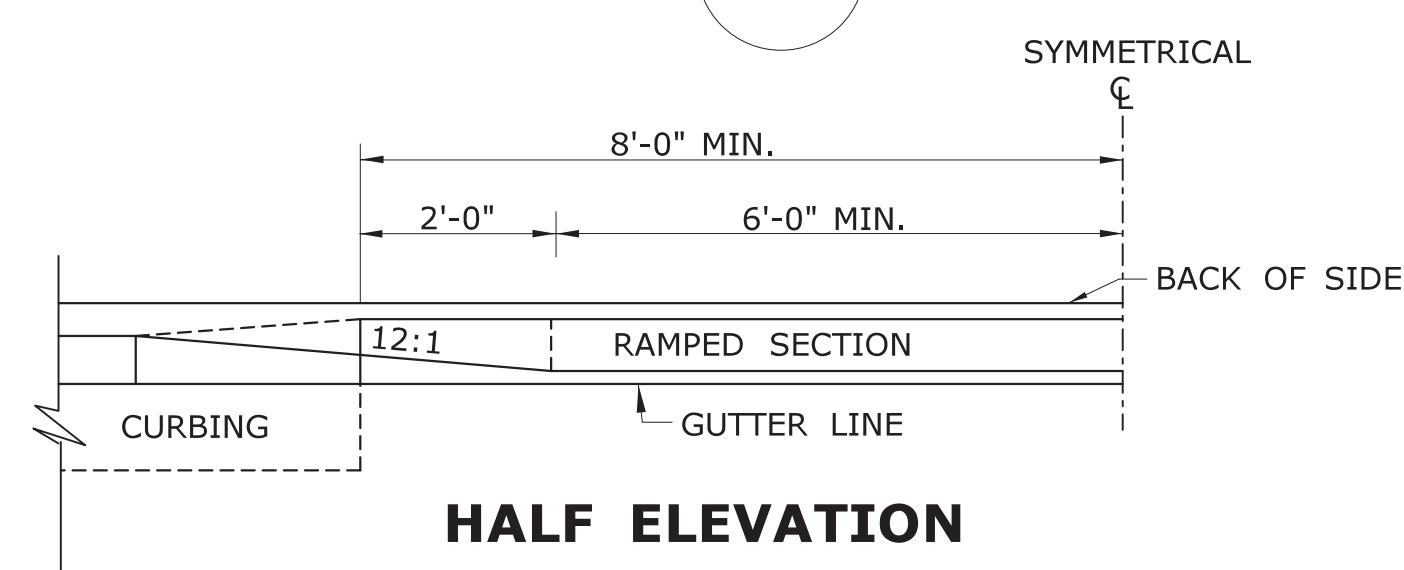


HALF ELEVATION

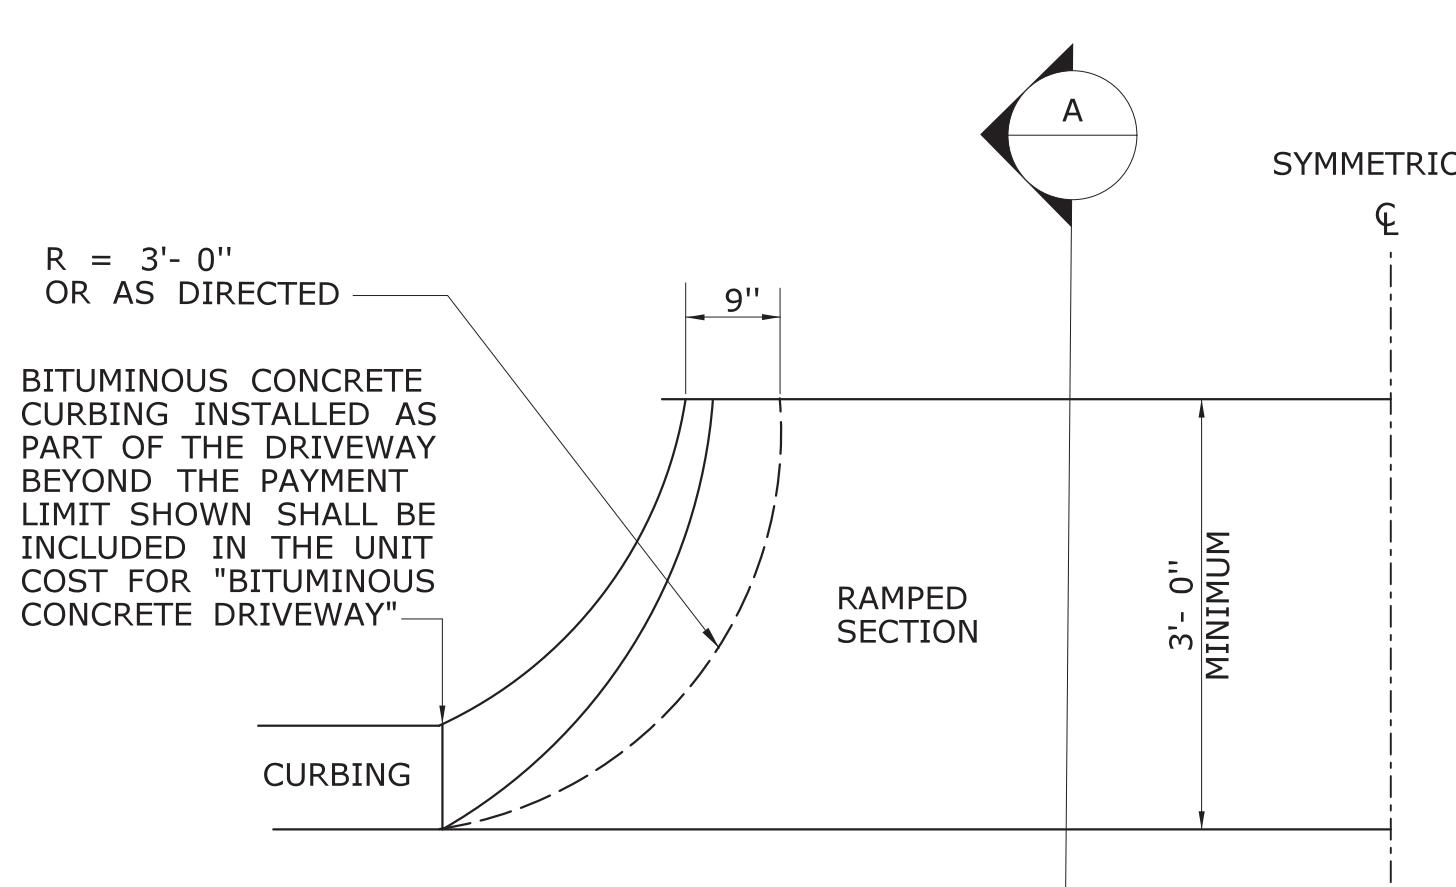

HALF BITUMINOUS CONCRETE
DRIVEWAY PLAN

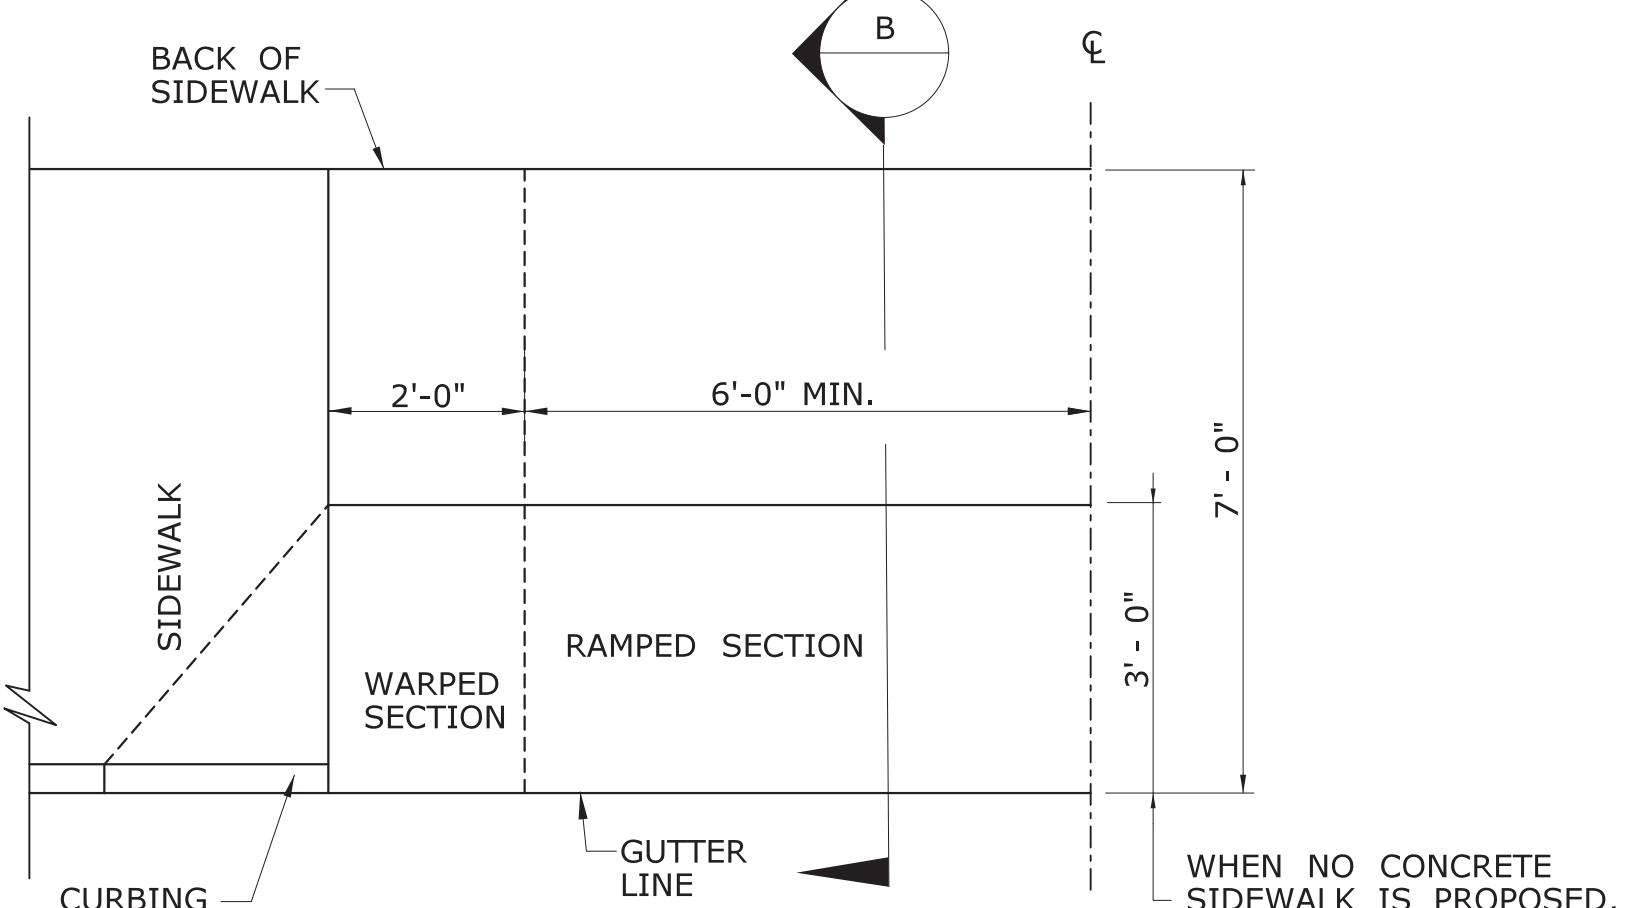

HALF PLAN OF
CONCRETE DRIVEWAY RAMP WHERE
SIDEWALK ADJOINS CURBING

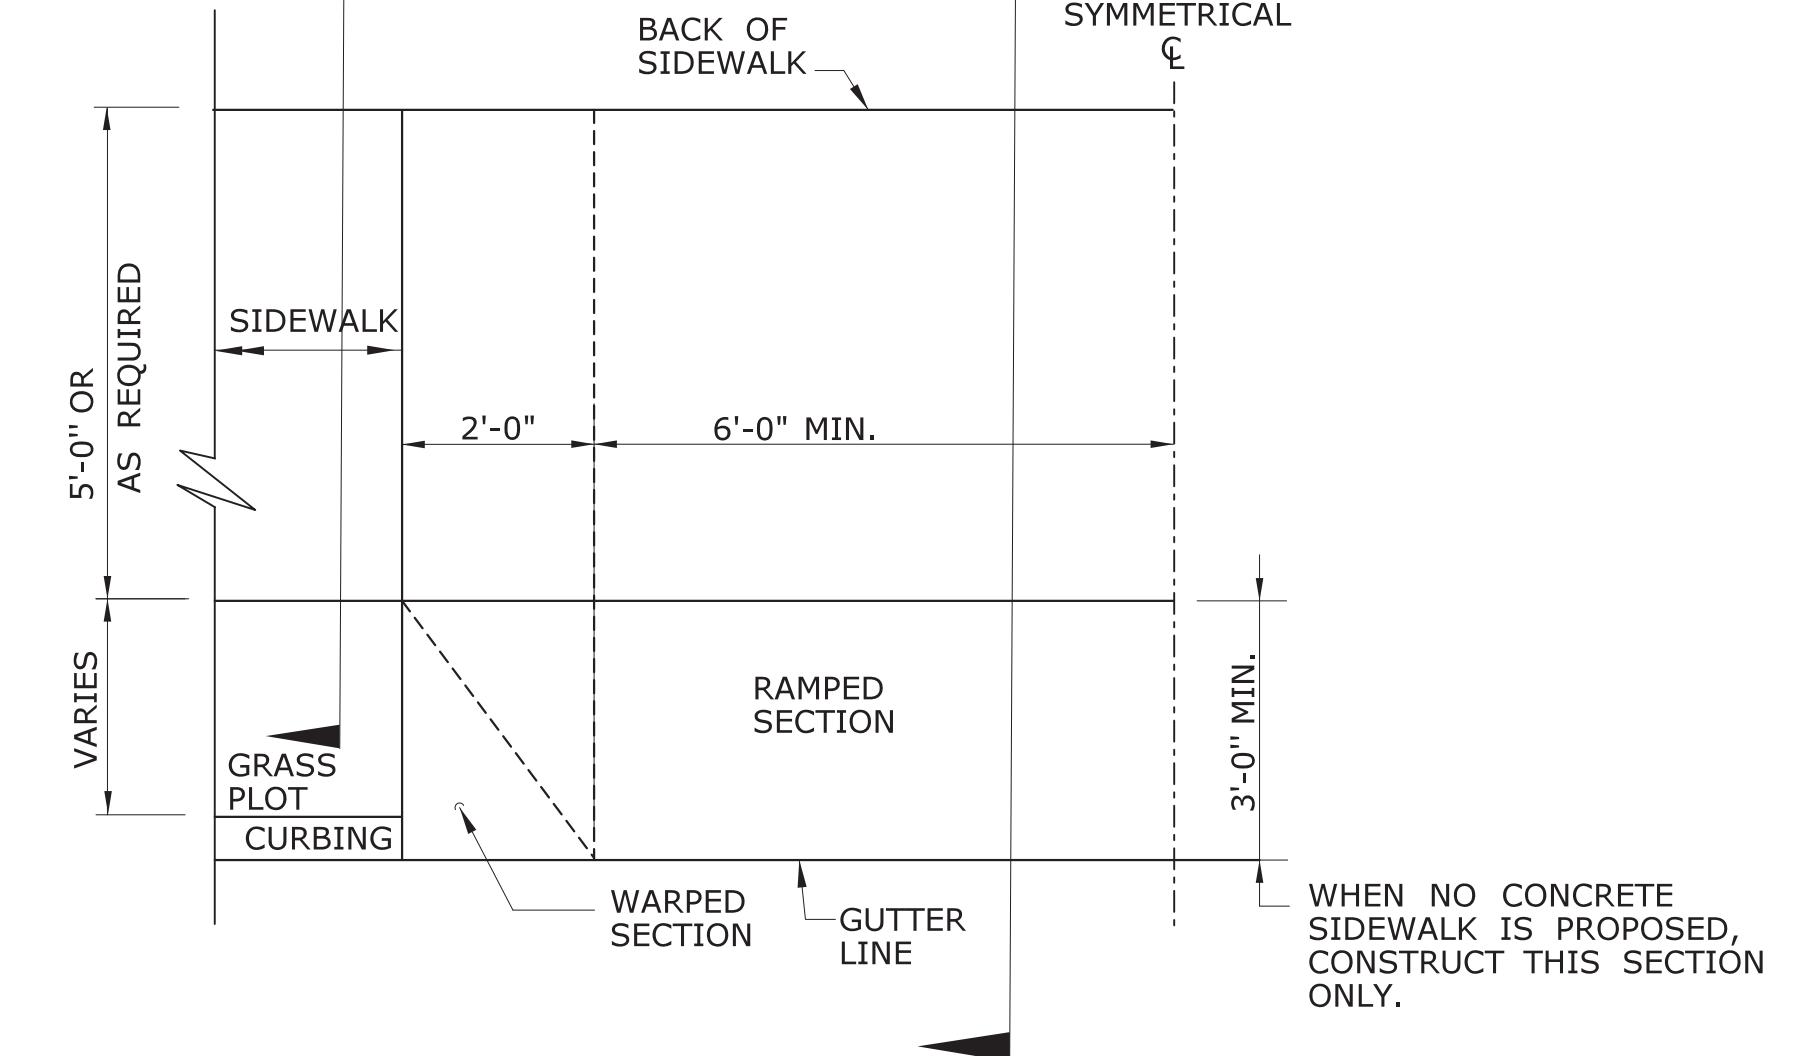

HALF PLAN OF
CONCRETE DRIVEWAY RAMP WHERE
CURB IS SEPARATED FROM
SIDEWALK BY GRASS PLOT

1	6/01/10	REVISED BORDER TITLE
2	6/01/10	REVISED HALF ELEVATION DETAILS
3	1/12	REVISE 2% MAX. SLOPE NOTE
4	6/17	REVISED SLOPES & MATERIAL COMPOSITIONS
-	-	INCREASED WALKING WIDTH OF CONCRETE DRIVEWAY RAMP
REV. DATE	REVISION DESCRIPTION	Plotted Date: 6/6/2017

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NOT TO SCALE




SUBMITTED BY: NAME/DATE/TIME:
Leo Fontaine, P.E.
2017.06.07 07:34:10-04'00'

APPROVED BY: NAME/DATE/TIME:
Gregory M. Dorosh, P.E.
2017.06.07 10:47:32-04'00'

CTDOT
STANDARD SHEET
OFFICE OF ENGINEERING

STANDARD SHEET TITLE:
DRIVEWAY RAMPS AND SIDEWALKS
HW-921_01

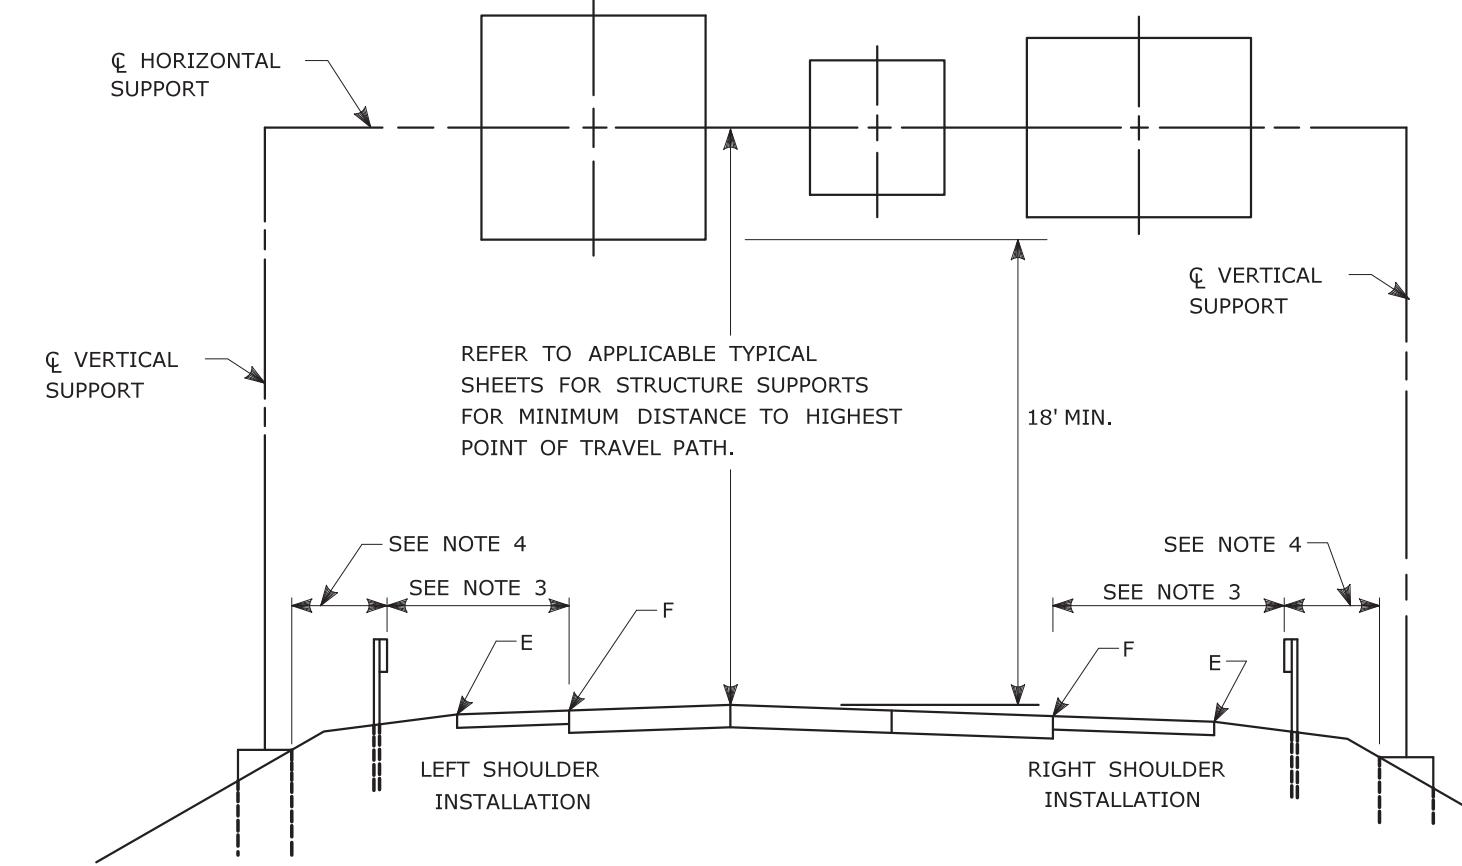

TYPICAL PLACEMENT OF OVERHEAD SIGNS ON SIGN SUPPORTS

NOTES:

- 1) FOR PLACEMENT OF CANTILEVER SIGN SUPPORT USE APPLICABLE PORTION OF ABOVE DETAIL.
- 2) BARRIER SYSTEMS MAY BE REQUIRED FOR BOTH SIDES OF SUPPORTS IN MEDIANES.
- 3) IMPACT PROTECTION SHALL BE PROVIDED FOR THE SIGN SUPPORTS LOCATED WITHIN CLEAR ZONE.
- 4) SIGN SUPPORT FOUNDATIONS SHALL BE LOCATED OUTSIDE OF BARRIER SYSTEMS DEFLECTION AREA.
- 5) ALL SIGNS ARE TO BE LEVEL, REGARDLESS OF CAMBER IN SUPPORT.

FOR MAXIMUM EFFECTIVENESS, POSITION SIDE MOUNTED SIGNS ON STRUCTURAL STEEL BREAKAWAY SIGN SUPPORTS AS FOLLOWS:

ON A TANGENT SECTION, POSITION THE SIGN SO THE VERTICAL AXIS IS PLUMB AND THE HORIZONTAL AXIS IS AT AN ANGLE OF 90° WITH THE TRAFFIC LANE WHICH THE SIGN SERVES. SIGNS LOCATED 30 FT OR MORE FROM THE EDGE OF THE ROAD SHALL BE TURNED APPROXIMATELY 3° TOWARD THE ROAD.

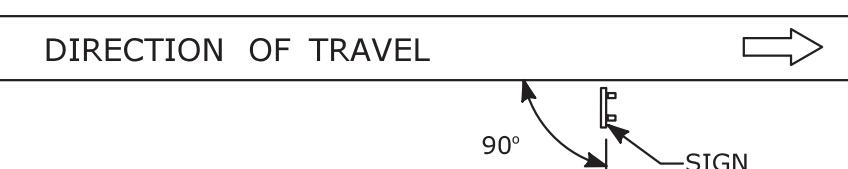


DIAGRAM "A"

ON A HORIZONTAL CURVE SECTION, POSITION THE SIGN SO THE VERTICAL AXIS IS PLUMB AND THE HORIZONTAL AXIS IS AT AN ANGLE OF 90° WITH A STRAIGHT LINE BETWEEN THE SIGN AND THE POINT AT WHICH THE SIGN SHALL BE READ.


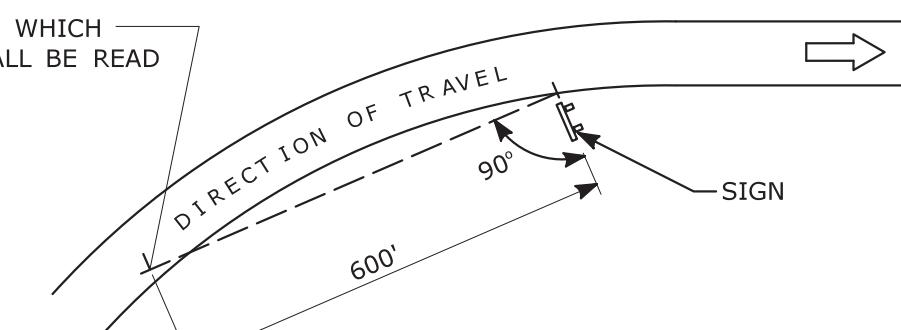


DIAGRAM "B"

SIGN ORIENTATION DETAILS FOR SIDE MOUNTED SIGNS ON STRUCTURAL STEEL BREAKAWAY SIGN SUPPORTS

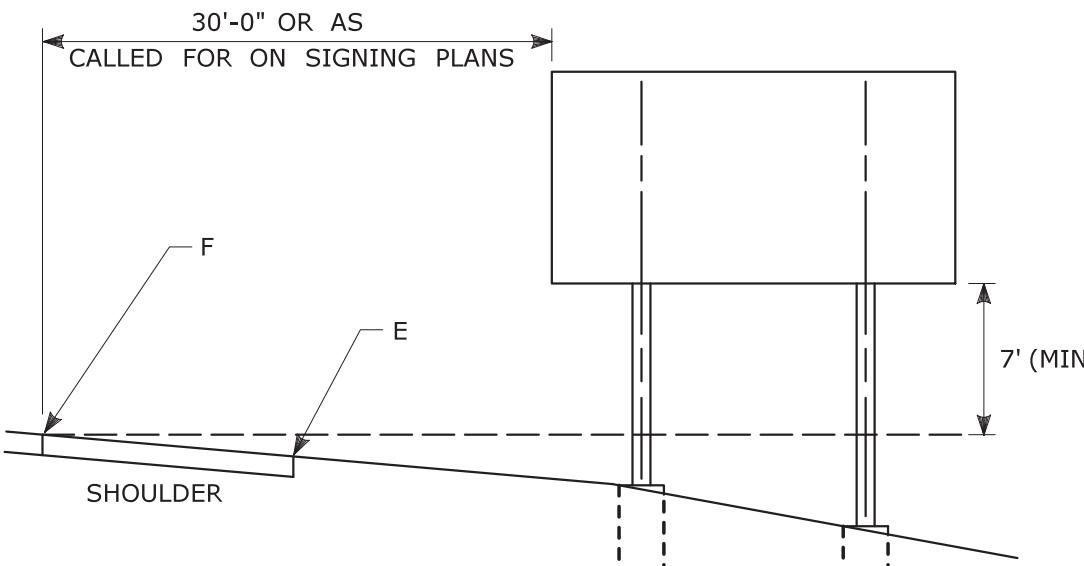


TYPICAL PLACEMENT OF SIDE MOUNTED SIGNS ON STRUCTURAL STEEL BREAKAWAY SIGN SUPPORTS


NOTES:

- 1) MIN. VERTICAL CLEARANCE ABOVE SIDEWALKS SHALL BE 7'.
- 2) WHERE GUIDE RAIL IS USED, THE OFFSET TO THE NEAR EDGE OF SIGN FACE SHALL BE AS SHOWN ELSEWHERE IN THE CONTRACT PLANS.
- 3) ON INTERSECTING ROADS AT RAMP TERMINI, THE OFFSET TO THE NEAR EDGE OF SIGN FACE SHALL BE 6' MIN. FROM POINT "E".
- 4) IF 30'-0" MIN. CANNOT BE MET, PLEASE CONTACT THE ENGINEER.

RETROREFLECTIVE STRIPS
48" LONG OR LESS:

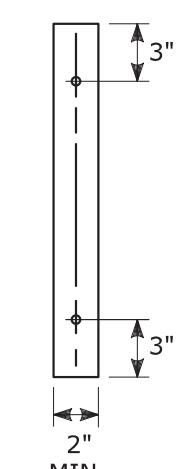


RETROREFLECTIVE STRIPS
OVER 48" LONG:

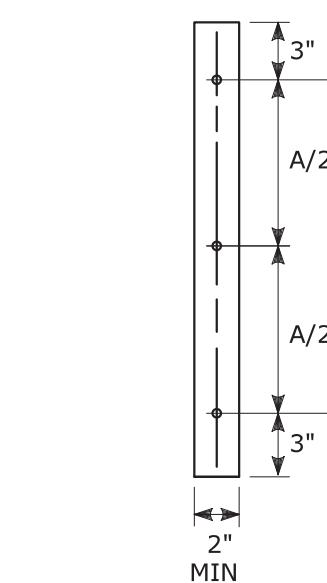

RETROREFLECTIVE STRIP DETAIL

NOTES:

RETROREFLECTIVE STRIPS WHICH ARE 48 IN LONG OR LESS SHALL BE ATTACHED USING 2 BOLTS AND RETROREFLECTIVE STRIPS OVER 48 IN LONG SHALL BE ATTACHED USING 3 BOLTS AS SHOWN ON THE DETAILS ABOVE. REFER TO STANDARD SHEET No. TR-1208-02 "METAL SIGN POSTS AND SIGN MOUNTING DETAILS" FOR MOUNTING DETAILS. RETROREFLECTIVE STRIP COLOR SHALL MATCH THE BACKGROUND COLOR OF THE SIGN, EXCEPT THAT THE COLOR OF THE STRIP FOR "YIELD" AND "DO NOT ENTER" SIGNS SHALL BE RED.

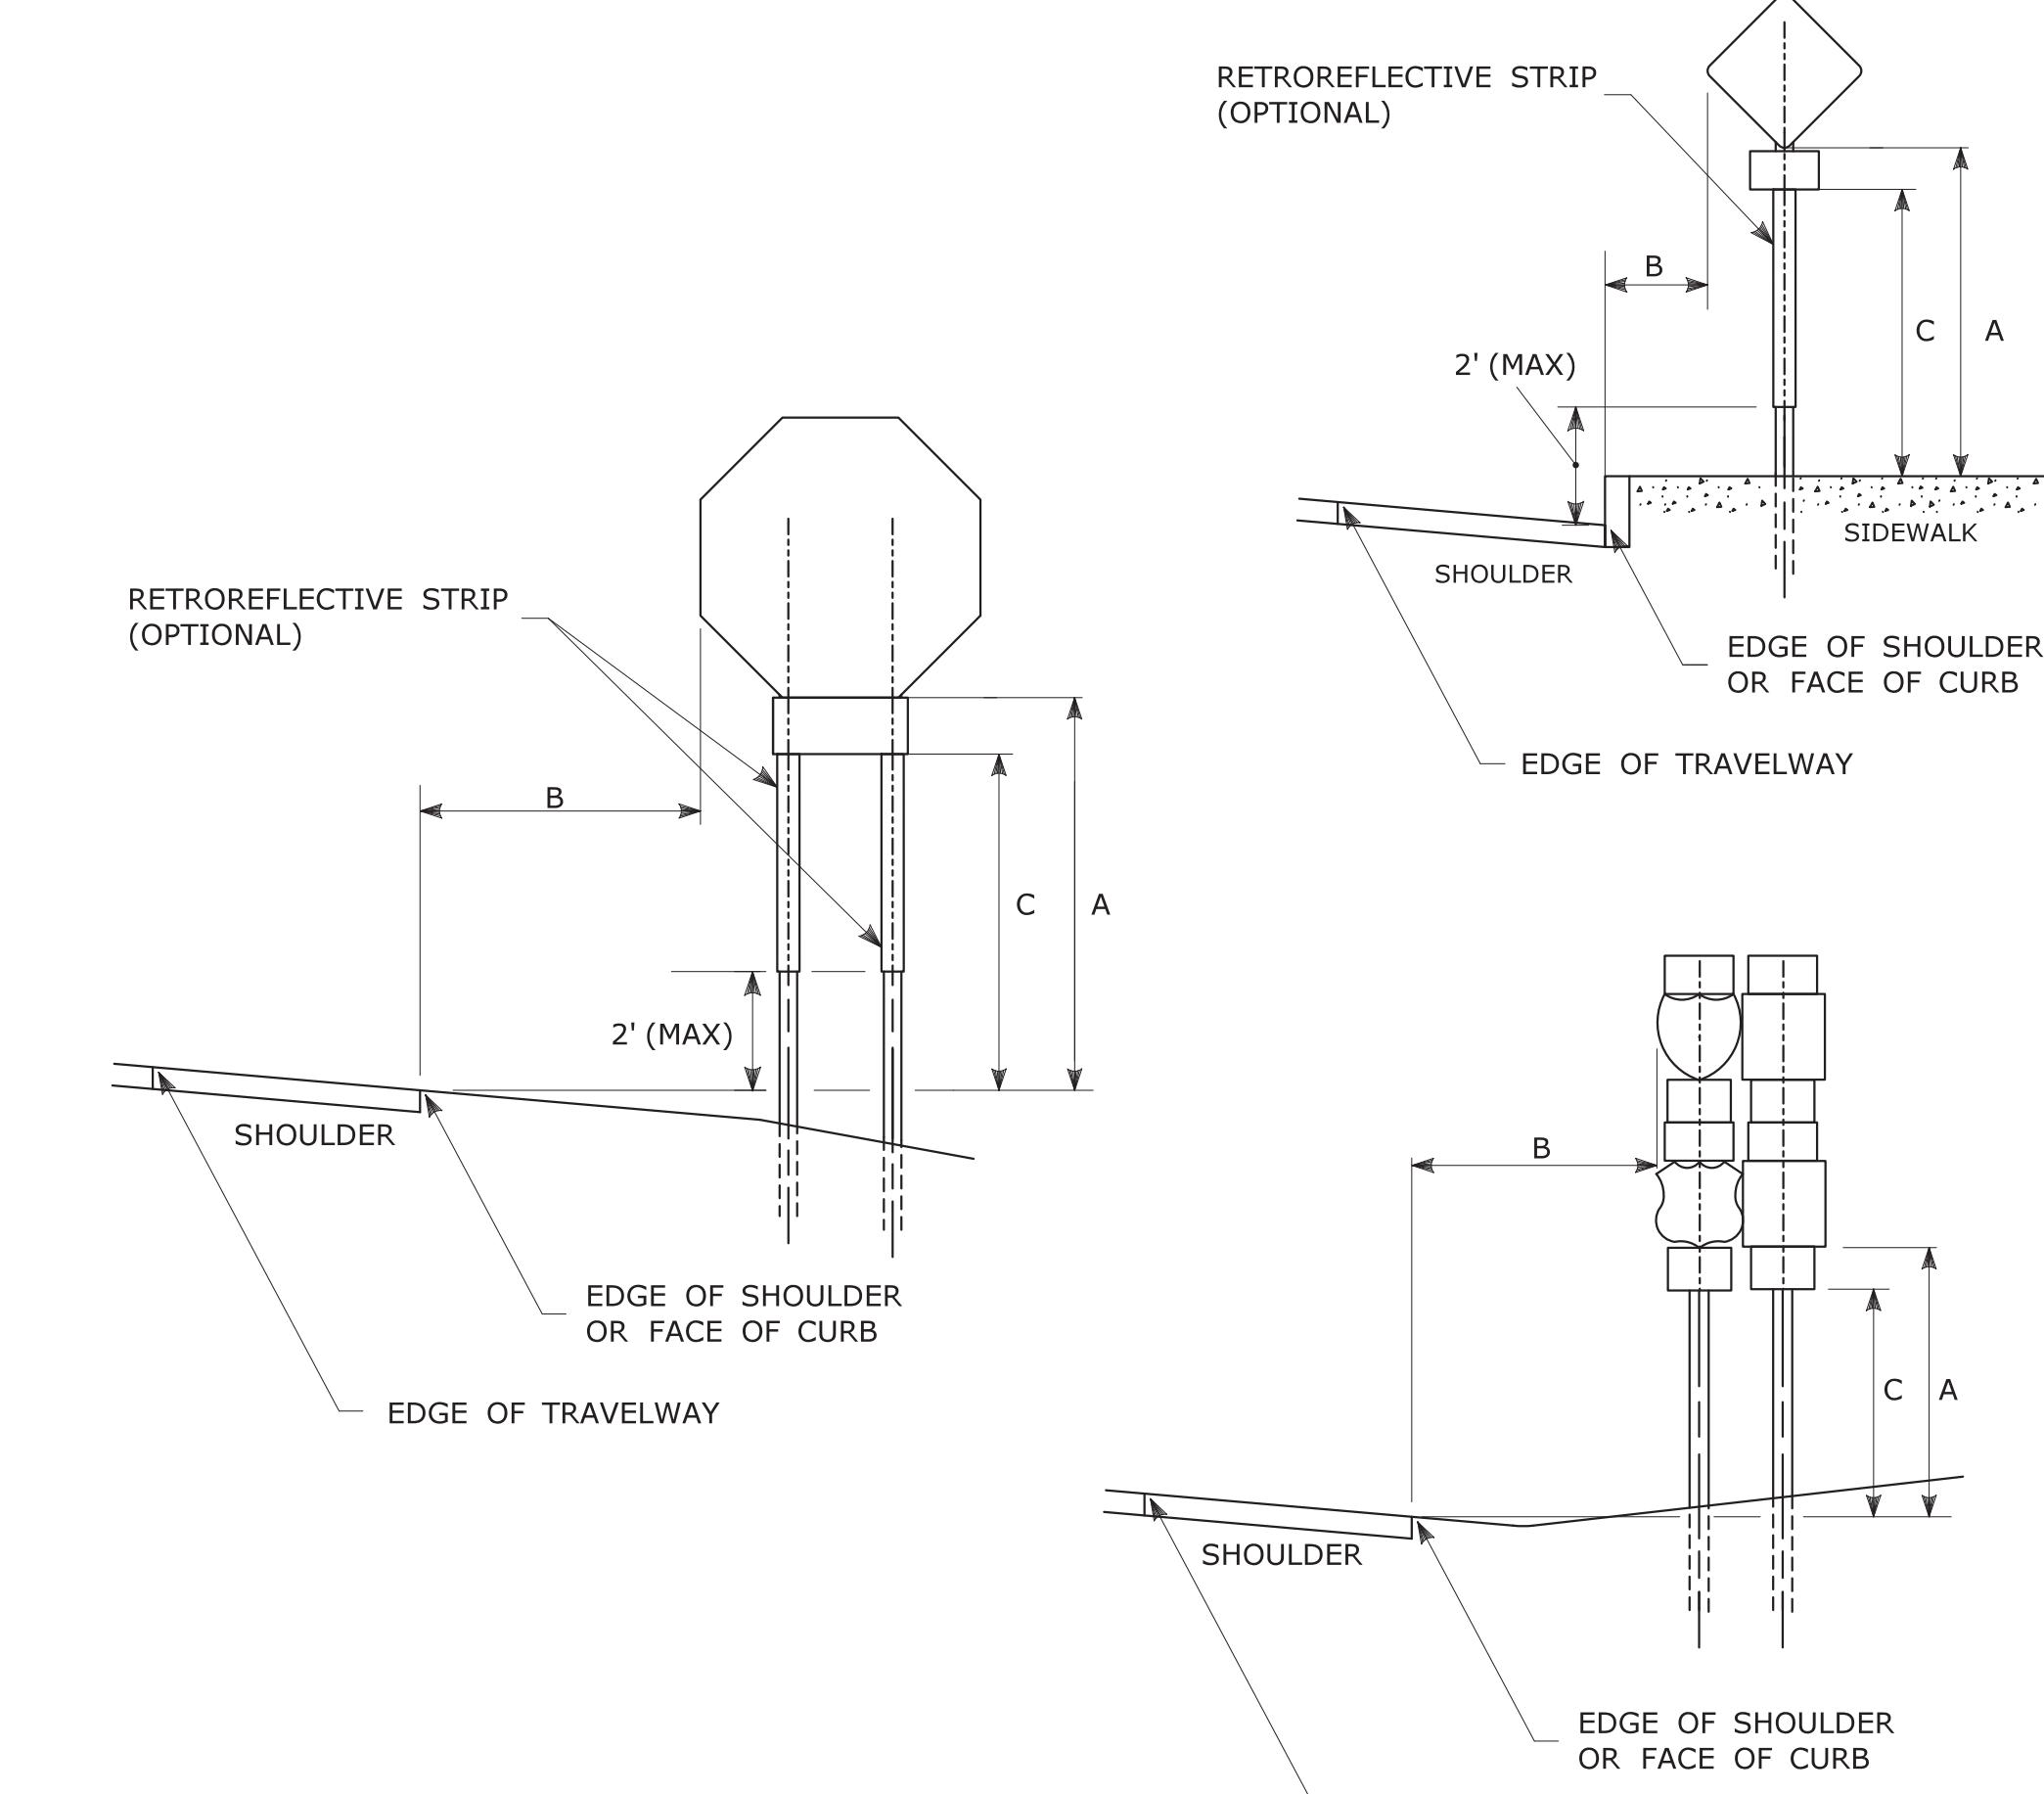

TYPICAL SIGN PLACEMENT DETAIL

NOTES:

ALL SIGNS AND SHIELDS ON DIRECTIONAL ASSEMBLIES SHALL ABUT VERTICALLY. REFER TO STANDARD SHEET No. TR-1208-02 "METAL SIGN POSTS AND SIGN MOUNTING DETAILS" FOR SIGN POSTS AND SIGN MOUNTING.

IF A RETROREFLECTIVE STRIP IS USED ON SIGN SUPPORT, IT SHALL BE PLACED FOR THE FULL LENGTH OF THE SUPPORT FROM THE BOTTOM OF THE SIGN TO WITHIN 2 FT ABOVE THE EDGE OF THE ROADWAY. PARKING SIGNS TYPICALLY USE 45° MOUNTING BRACKET.

DIM."A" MIN. SIGN HEIGHT	DIM."B" MIN. LATERAL OFFSET	DIM."C" MIN. PLAQUE HEIGHT	ASSEMBLY LOCATION
7'	6'	5'	SIGNS ON FREEWAYS AND EXPRESSWAYS EXCEPT CHEVRON ALIGNMENT SIGNS, ONE-DIRECTION LARGE ARROW SIGNS, DO NOT ENTER SIGNS, AND WRONG WAY SIGNS
5'	2'	4'	• SIGNS IN RURAL AREAS • DO NOT ENTER AND WRONG WAY SIGNS ALONG EXIT RAMPS • DO NOT ENTER AND WRONG WAY SIGNS ON LIMITED ACCESS HIGHWAYS
5'	2'	N/A	• CHEVRON ALIGNMENT SIGNS LOCATED ON FREEWAYS, EXPRESSWAYS, RAMPS, AND IN RURAL AREAS • ONE-DIRECTION LARGE ARROW SIGNS LOCATED ON FREEWAYS, EXPRESSWAYS, RAMPS, AND IN RURAL AREAS
4'	2'	4'	CENTRAL ISLANDS OF ROUNDABOUTS
7'	2'	6'	BUSINESS & RESIDENTIAL AREAS WHERE PARKING OR OTHER OBSTRUCTIONS LIMIT VISIBILITY
7'	2'	7'	SIDEWALKS

OR AS DIRECTED BY THE ENGINEER

8 FT MINIMUM HEIGHT REQUIRED IF A SUPPLEMENTAL PLAQUE IS SUBMOUNTED BELOW THE MAJOR SIGN.

6 FT FROM EDGE OF SHOULDER, WHEN SHOULDER IS OVER 6 FT WIDE
12 FT FROM EDGE OF TRAVELWAY, WHEN SHOULDER IS LESS THAN 6 FT WIDE.

A LATERAL OFFSET OF AT LEAST 1 FT FROM THE FACE OF THE CURB MAY BE USED WHERE SIDEWALK WIDTH IS LIMITED OR WHERE EXISTING UTILITY POLES ARE CLOSE TO THE CURB.

A CLEAR PATH OF NOT LESS THAN 4 FT SHALL BE PROVIDED IN SIDEWALK AREAS.

2 4-2017	MINOR REVISIONS.
1 2-2011	MINOR REVISIONS.
REV. DATE	REVISION DESCRIPTION

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Plotted Date: 4/3/2017

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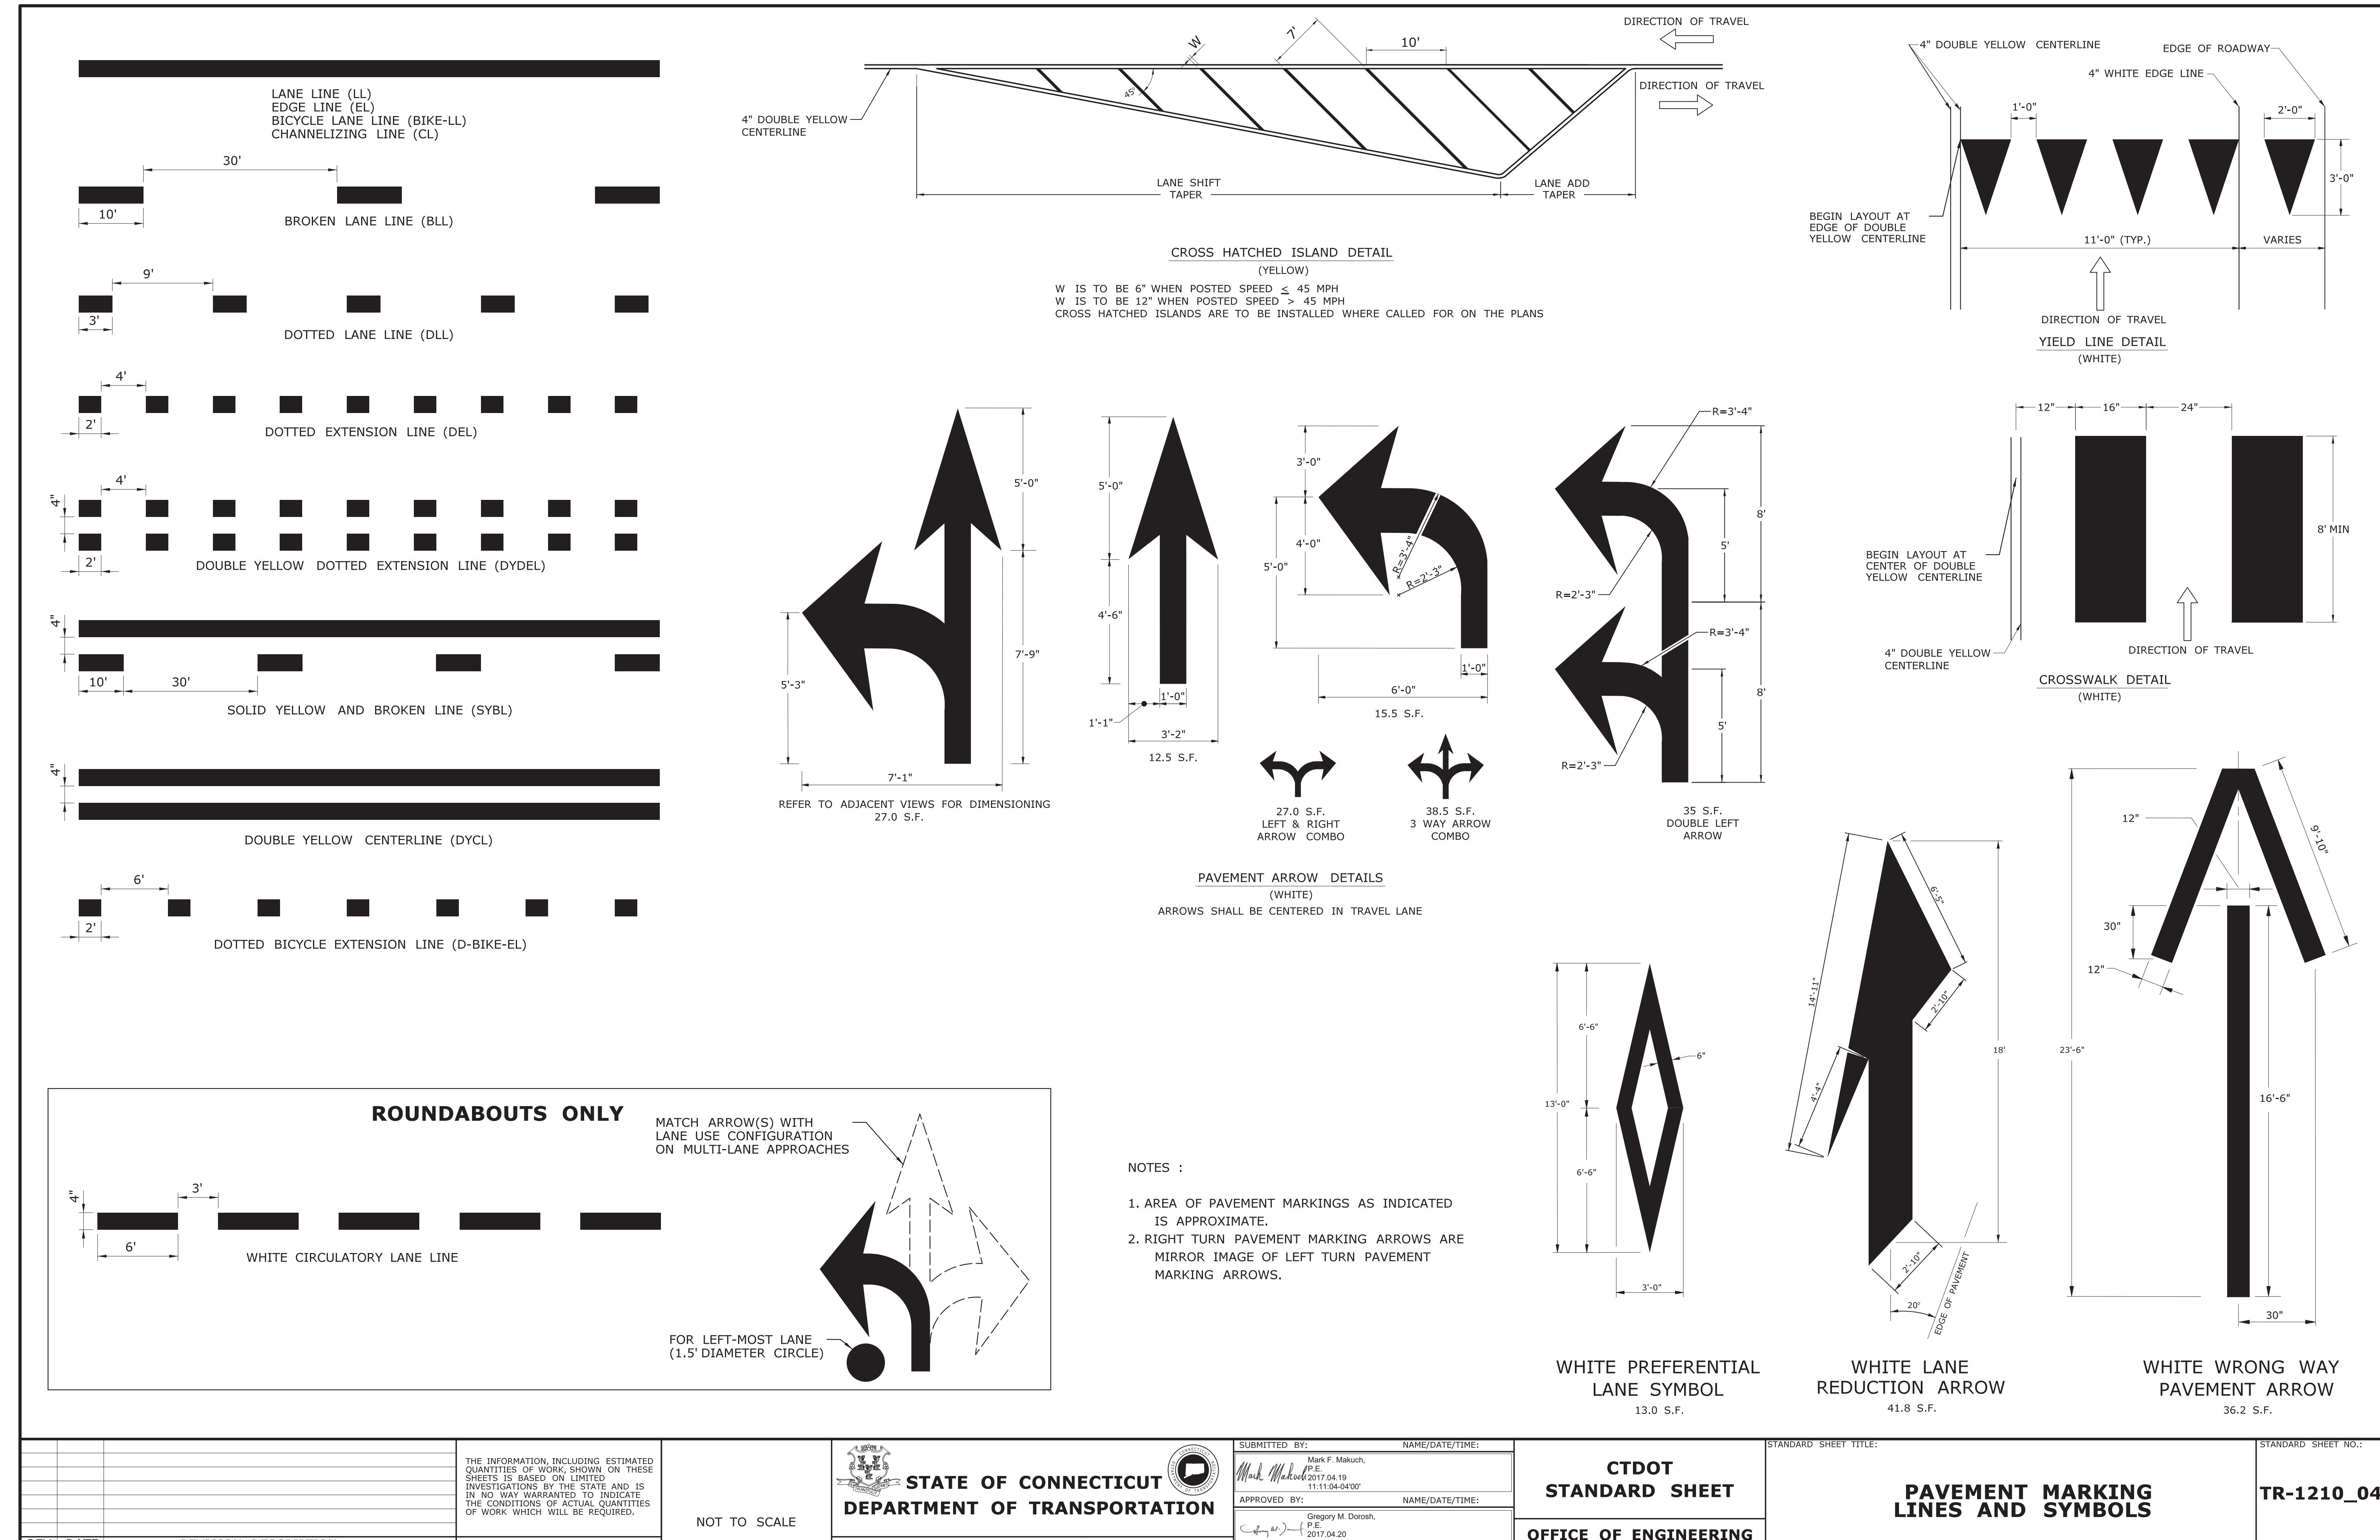
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DEPARTMENT OF TRANSPORTATION





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CTDOT STANDARD SHEET
OFFICE OF ENGINEERING




STANDARD SHEET TITLE:
**SIGN PLACEMENT AND
RETROREFLECTIVE STRIP DETAILS**

STANDARD SHEET NO.:
TR-1208_01



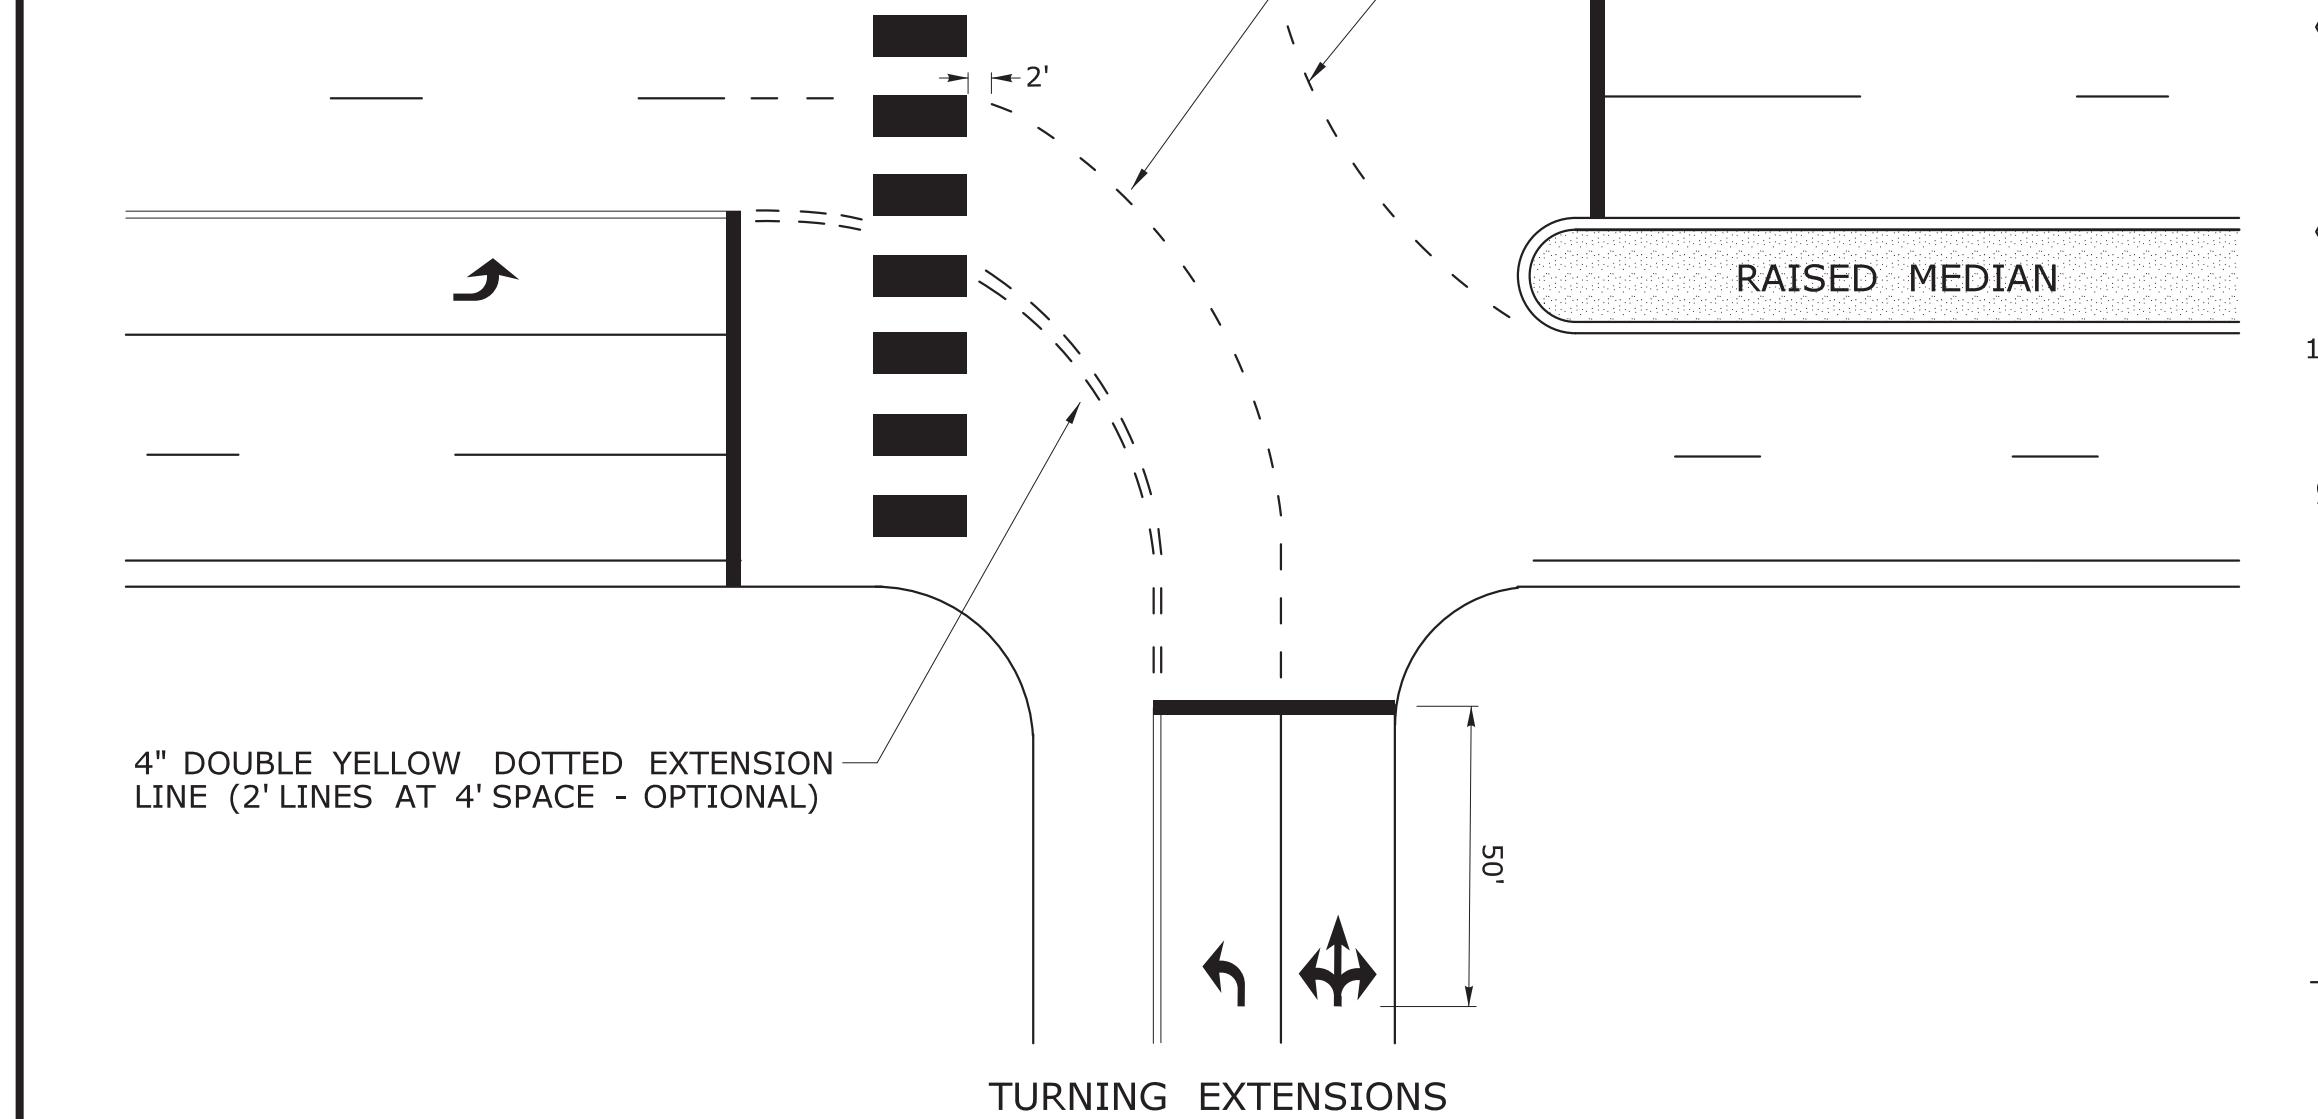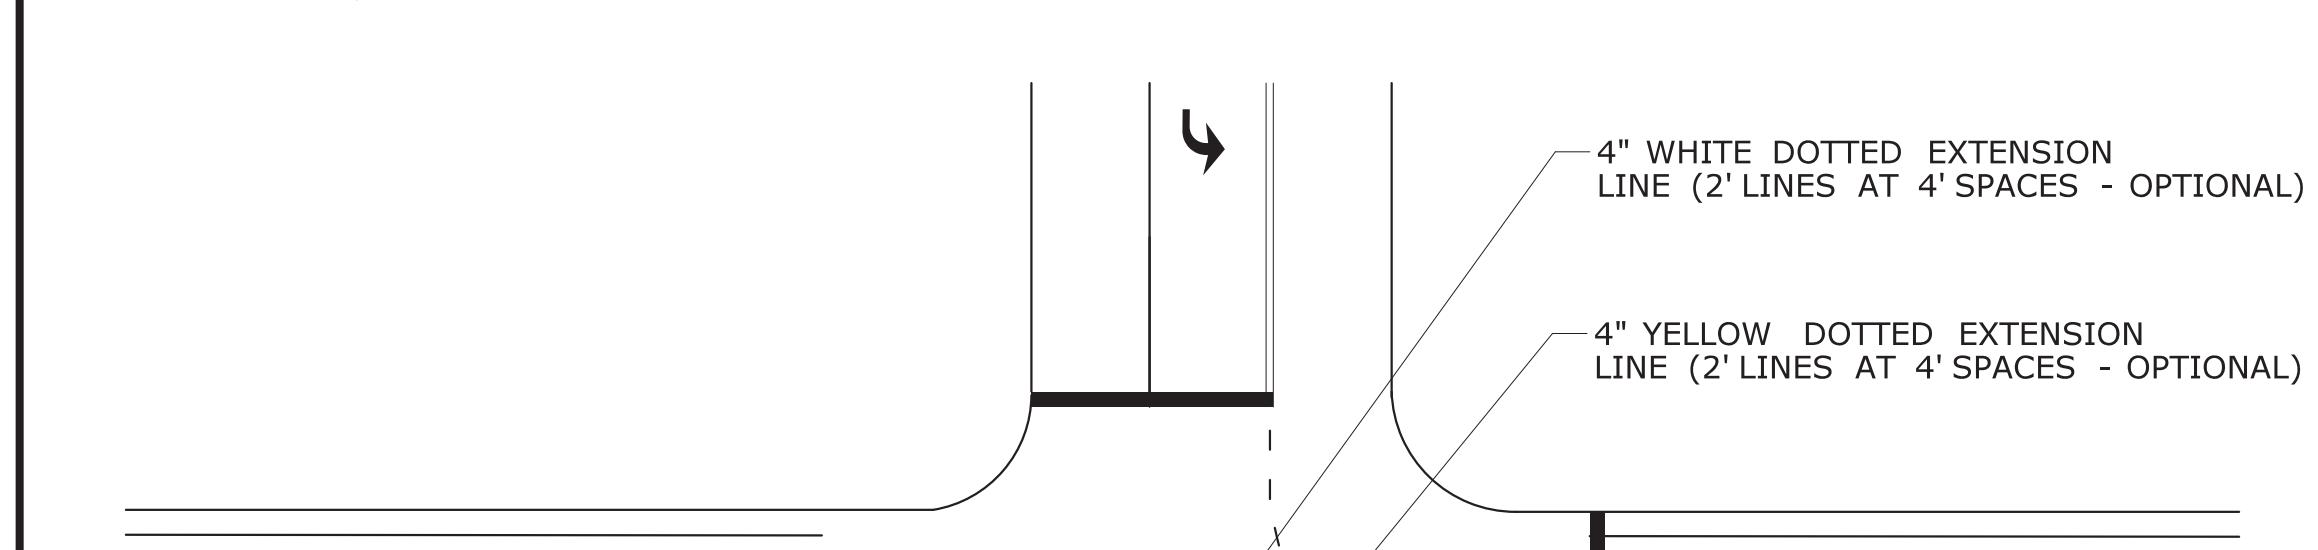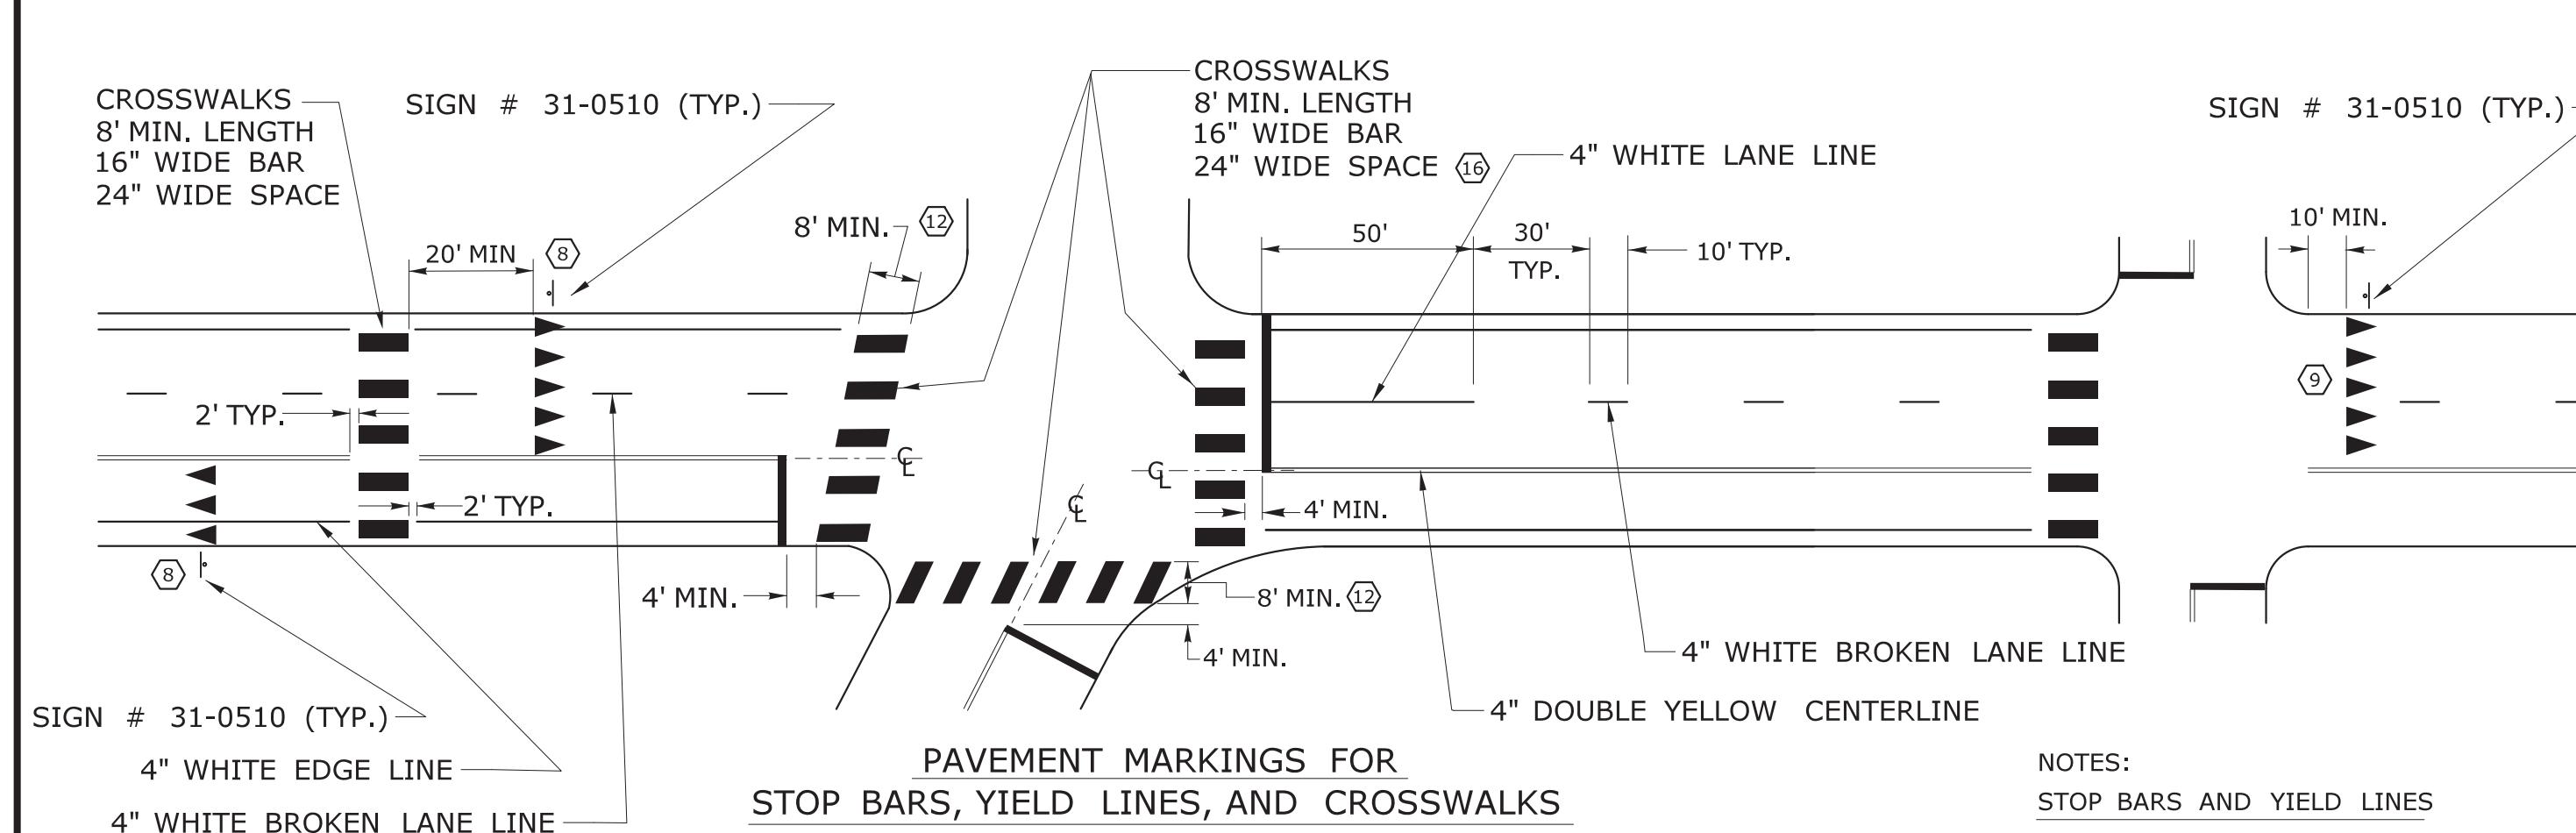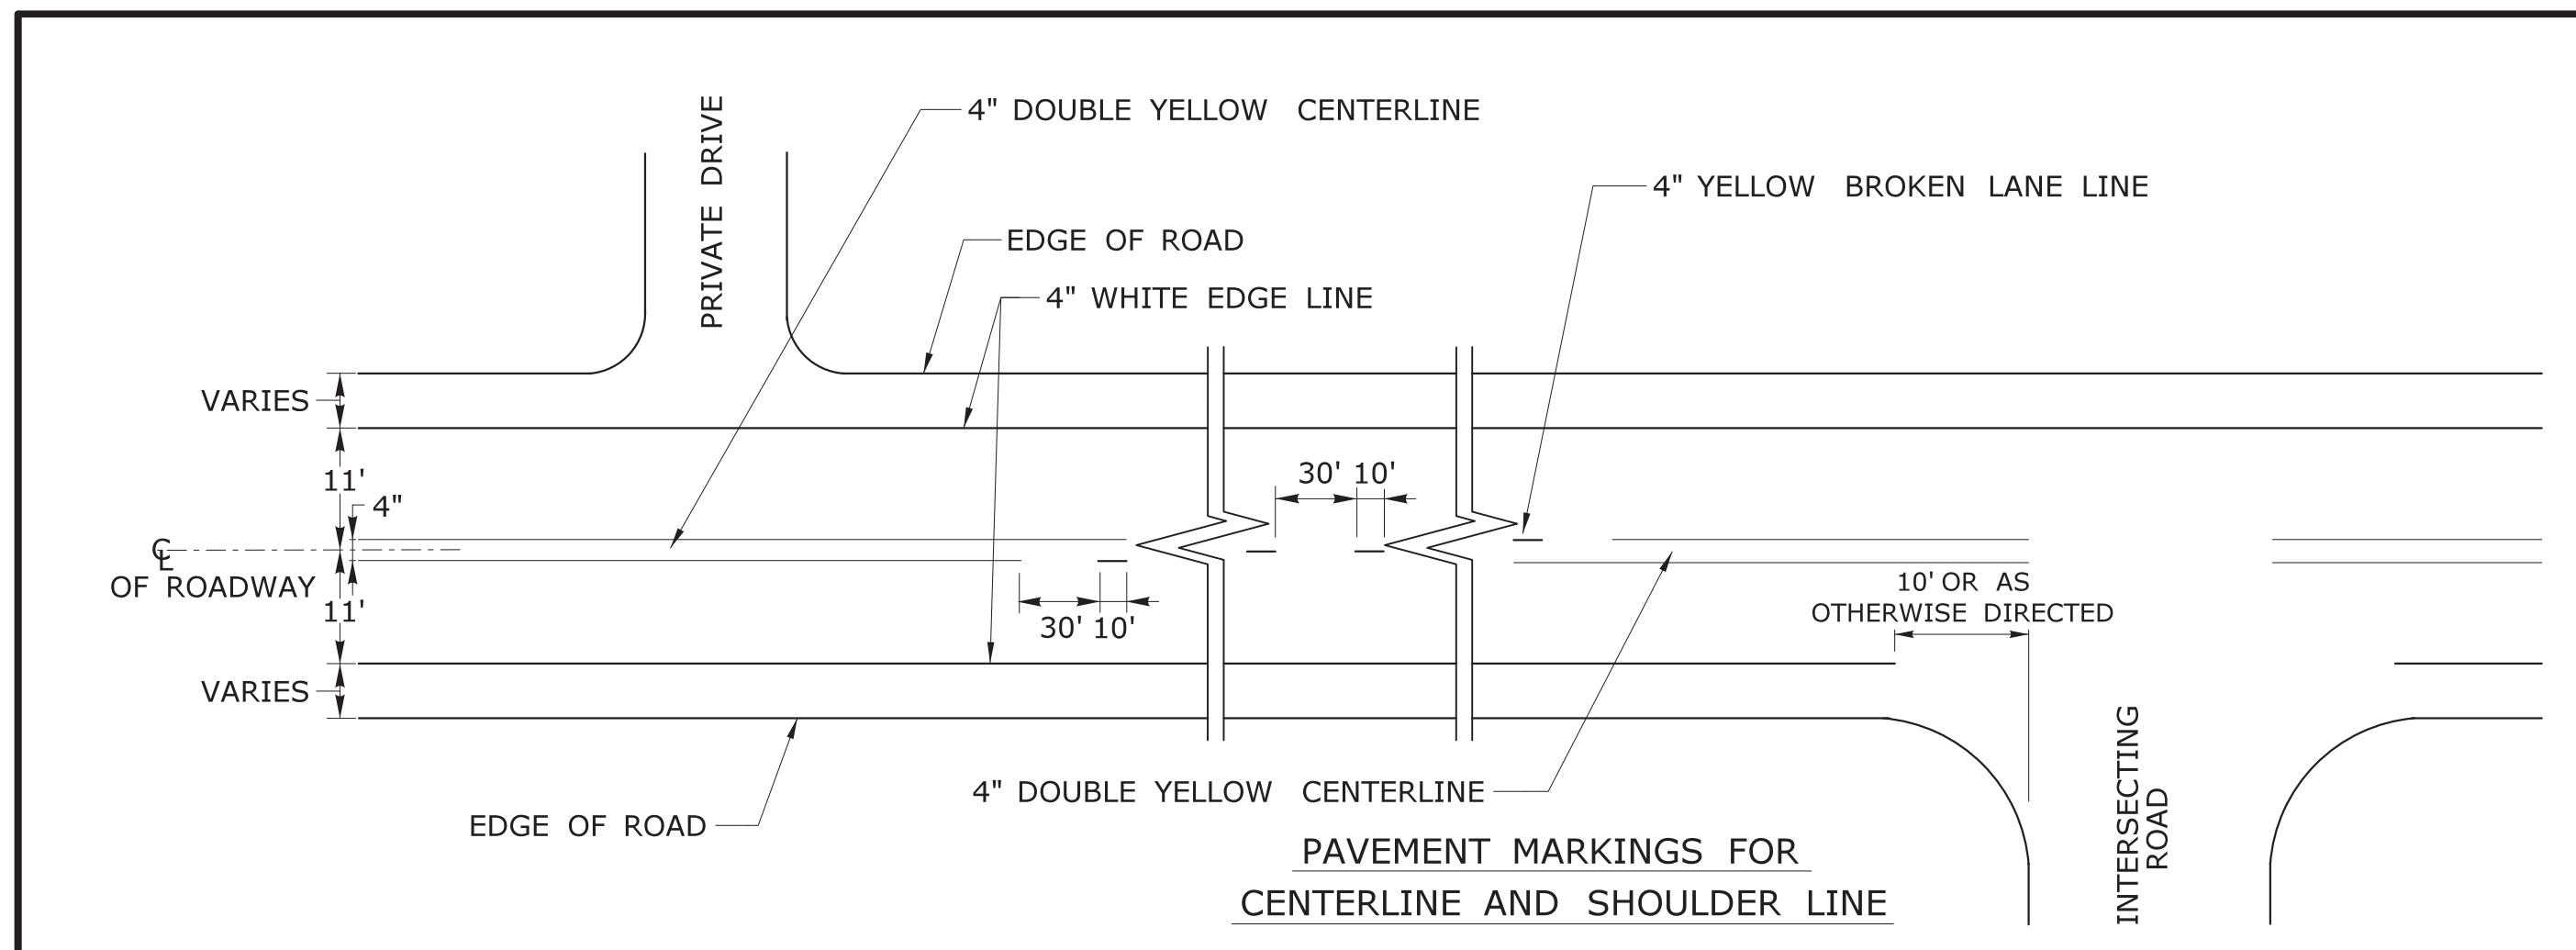

NOTES:
STOP BARS AND YIELD LINES
1. STOP BARS AND YIELD LINES SHALL BE WHITE.
2. STOP BARS SHALL BE 12" MIN. UNLESS OTHERWISE NOTED ON PLANS.
3. STOP BARS TO BE PLACED A MINIMUM OF 4' IN ADVANCE OF THE NEAREST EDGE OF CROSSWALK AND SHOULD BE PLACED 90° TO THE CENTERLINE OF THE ROADWAY.
4. IN THE ABSENCE OF A MARKED CROSSWALK THE STOP BAR SHOULD BE PLACED 90° TO THE CENTERLINE OF THE ROADWAY, AT THE DESIRED STOPPING POINT AT LEAST 5' AND NO MORE THAN 30' FROM THE NEAREST EDGE OF THE INTERSECTING ROADWAY.
5. THE STOP SIGN SHOULD BE PLACED IN LINE WITH THE STOP BAR. HOWEVER, IF THE STOP SIGN CANNOT BE LOCATED EXACTLY WHERE VEHICLES ARE EXPECTED TO STOP, THE STOP BAR SHOULD BE PLACED AT THE STOPPING POINT.
6. FOR STOP BARS AT RAMPS SEE DETAILS "R", "S", "T", & "U" AND NOTES ON TRAFFIC STANDARD SHEET TR-1210 07 "PAVEMENT MARKINGS FOR DIVIDED HIGHWAYS EXIT RAMPS".
7. FOR YIELD LINE INSTALLATIONS, ONLY FULL TRIANGLES ARE TO BE INSTALLED.
8. MID-BLOCK CROSSWALKS ARE CROSSWALKS LOCATED MORE THAN 50 FEET FROM A SIGNALIZED OR UNSIGNALIZED INTERSECTION. YIELD LINES ASSOCIATED WITH MIDBLOCK CROSSWALKS SHOULD BE INSTALLED 20 TO 50 FEET IN ADVANCE OF THE NEAREST CROSSWALK LINE OR AS DIRECTED BY THE ENGINEER.
SIGN # 31-0510 IS REQUIRED.
9. FOR CROSSWALKS AT UNSIGNALIZED INTERSECTIONS WITH MINOR STREET STOP CONTROL, YIELD LINES SHALL BE INSTALLED ON MULTI-LANE APPROACHES, BUT NOT SINGLE LANE APPROACHES.
10. THE YIELD SIGN SHOULD BE PLACED IN LINE WITH A YIELD LINE. HOWEVER, IF THE YIELD SIGN CANNOT BE LOCATED EXACTLY WHERE VEHICLES ARE EXPECTED TO YIELD, THE YIELD LINE SHOULD BE PLACED AT THE YIELDING POINT.
CROSSWALKS
11. CROSSWALK MARKINGS SHALL BE WHITE.
12. AT LOCATIONS WHERE THE CROSSWALK IS SKewed, BARS TO BE PARALLEL TO \mathbb{C} AND ENDS OF BARS TO BE PARALLEL. THE LENGTH OF THE BARS WILL VARY DEPENDING ON THE ANGLE OF SKew.
13. BARS SHOULD BE NO CLOSER THAN 1' FROM EDGE OF ROAD.
14. ONLY FULL LENGTH BARS ARE TO BE INSTALLED.
15. DECORATIVE CROSSWALKS SHALL BE BANDED FROM CURB TO CURB WITH A MINIMUM 12" WIDE WHITE TRANSVERSE LINE ALONG EACH EDGE.
16. 24" WIDE SPACE TO BE CENTERED ON YELLOW CENTERLINE.
PAVEMENT MARKINGS FOR TURNING LANES
17. INSTALL AT LEAST TWO ARROWS PER LANE WHERE STORAGE LENGTH IS GREATER THAN 150 FEET.

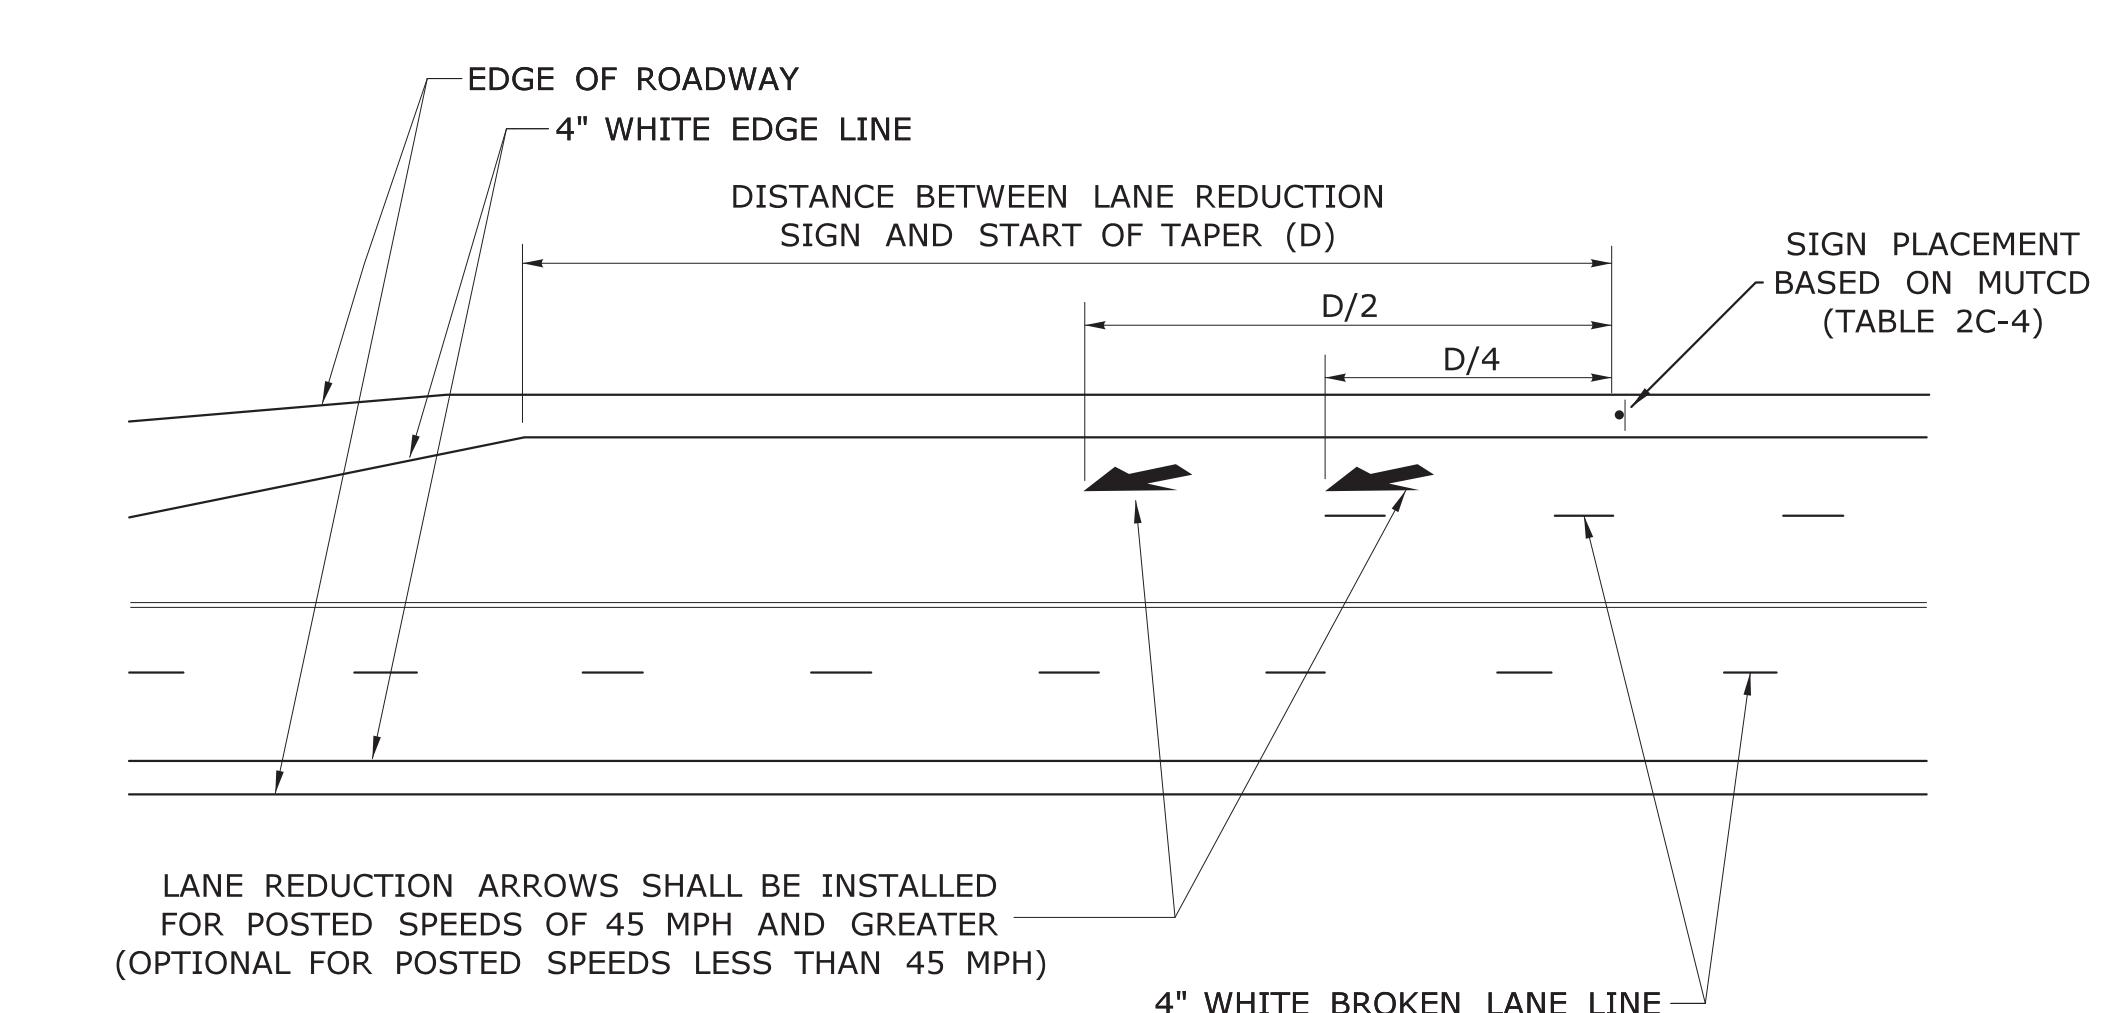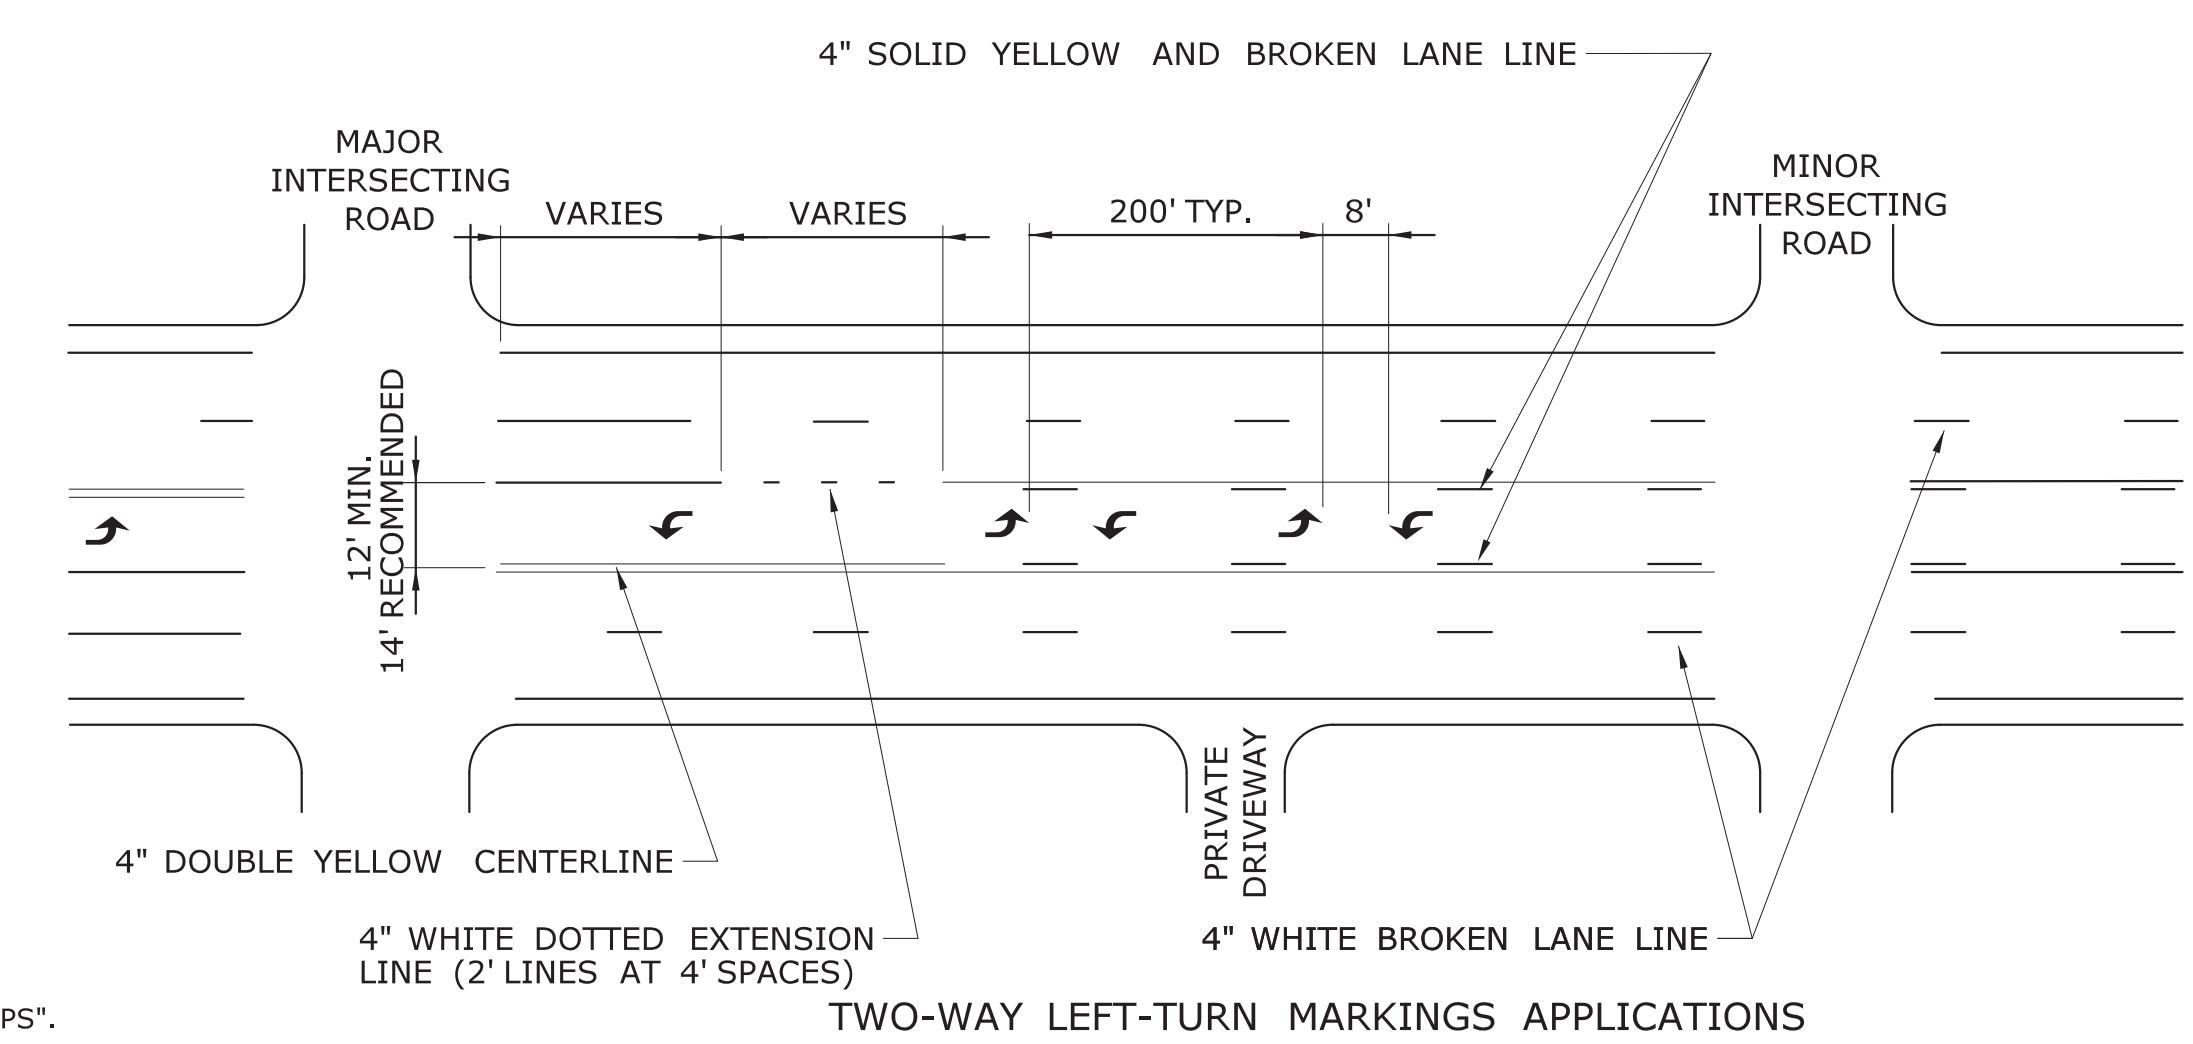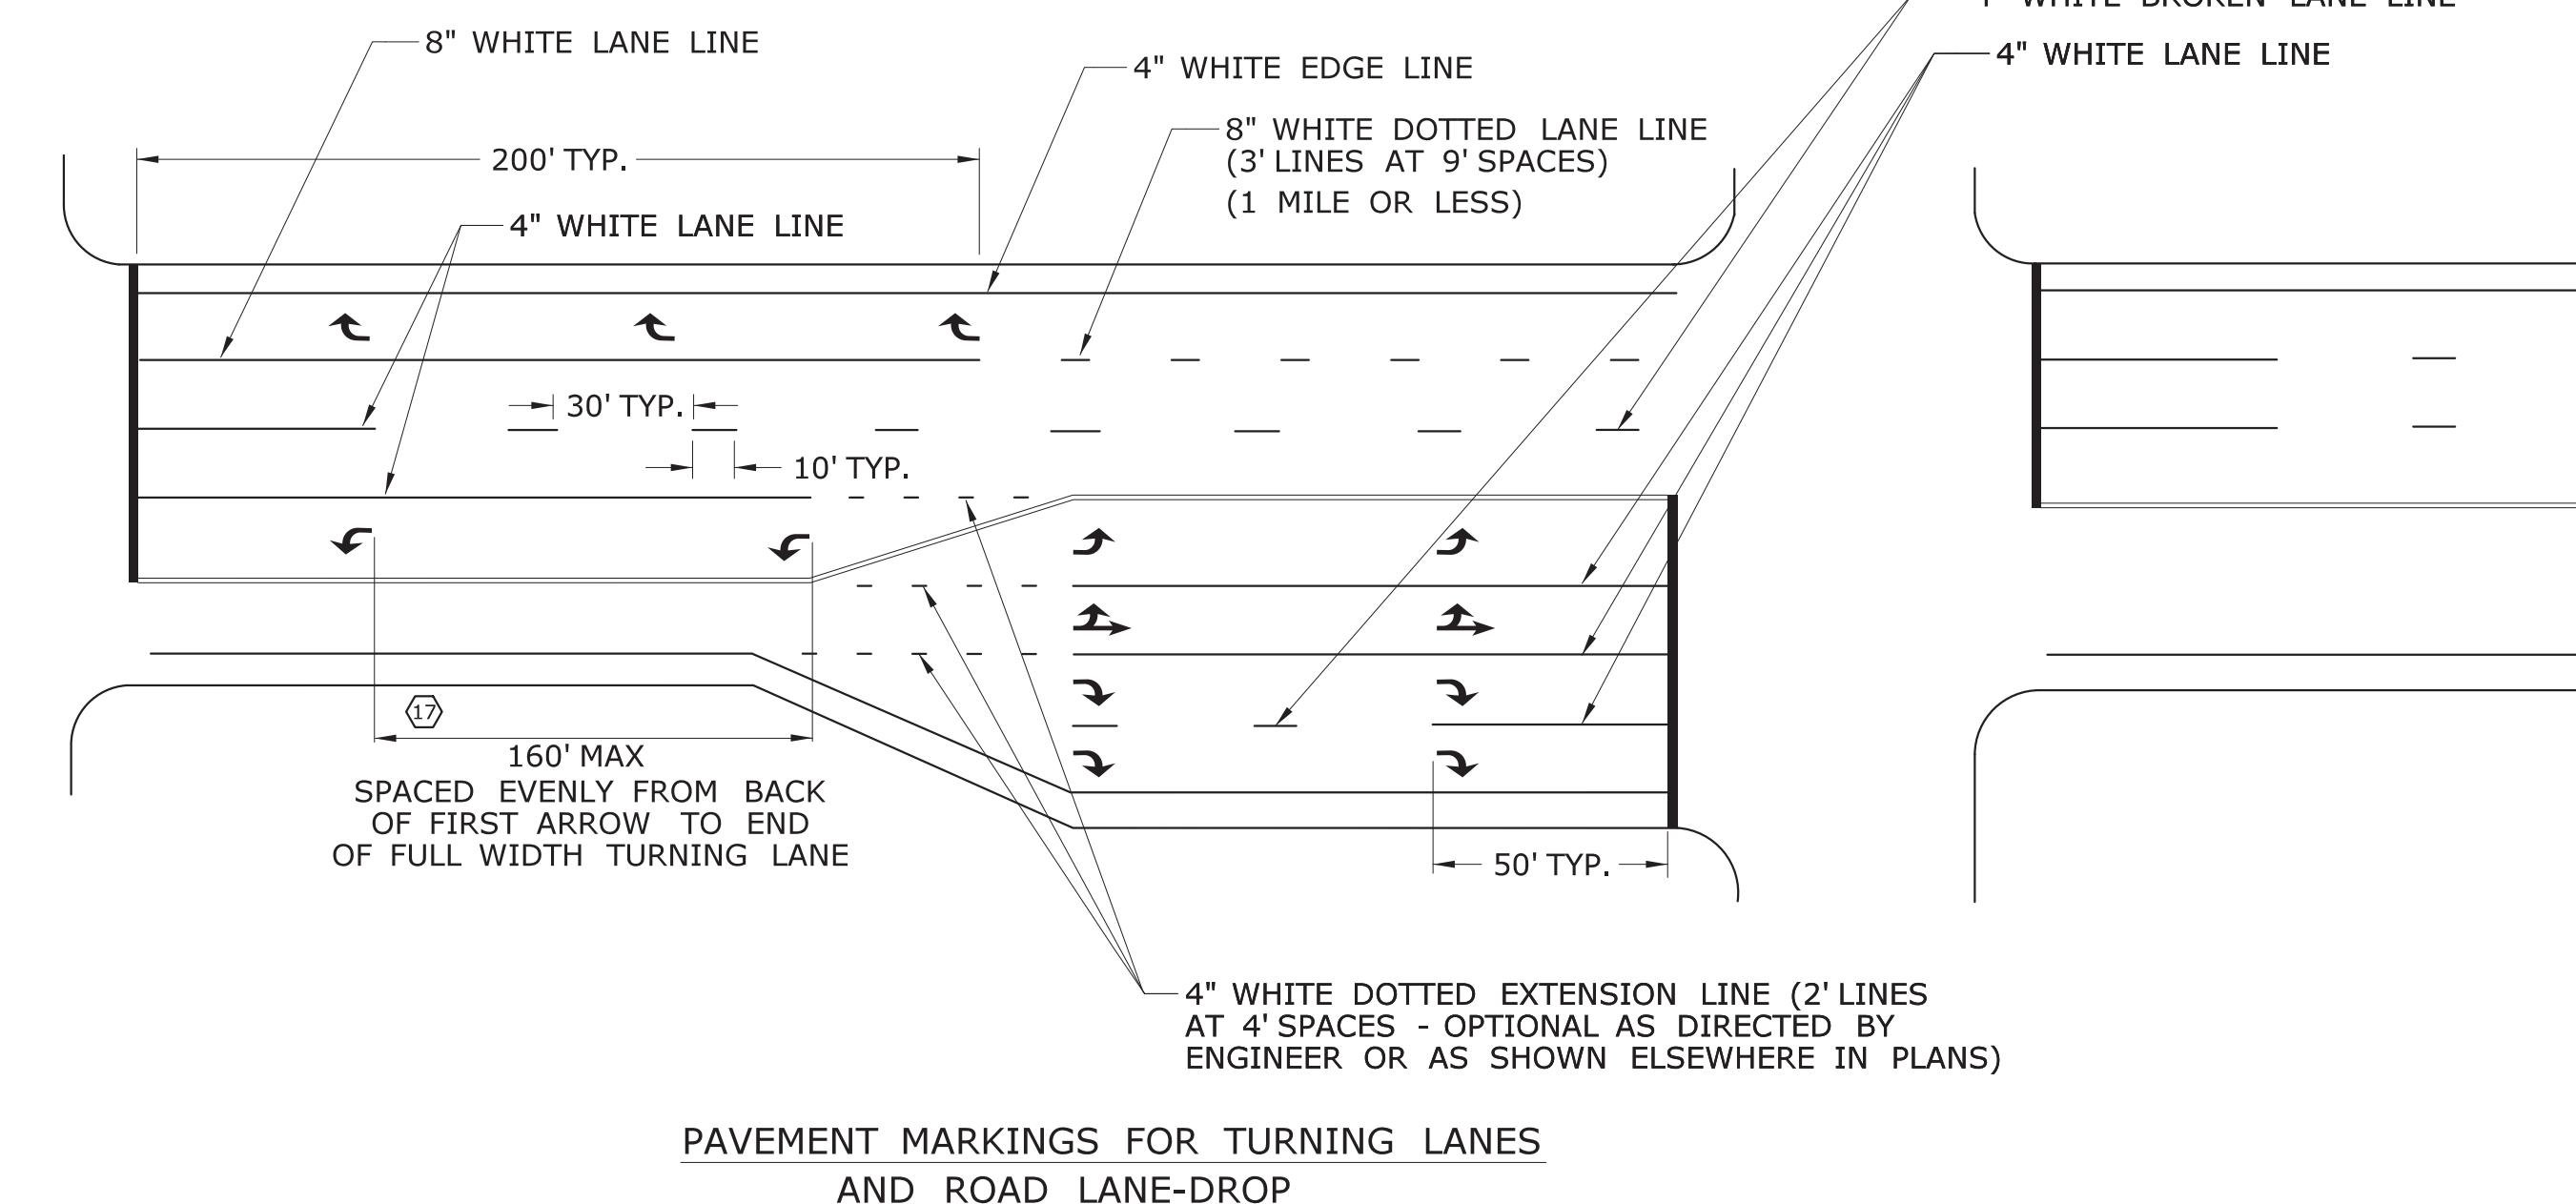

REV. DATE	REVISION DESCRIPTION
	Plotted Date: 4/3/2017

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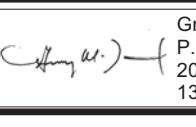
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Model: TR-1210.05



SUBMITTED BY: NAME/DATE/TIME:
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 2017.04.19
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APPROVED BY: NAME/DATE/TIME:
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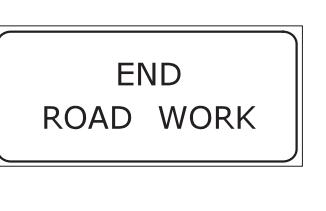
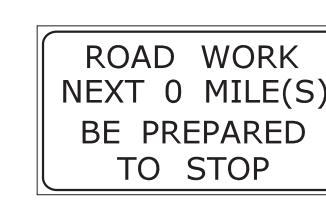
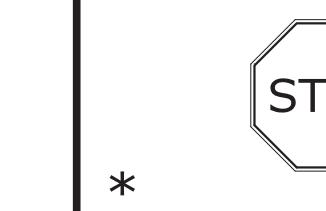
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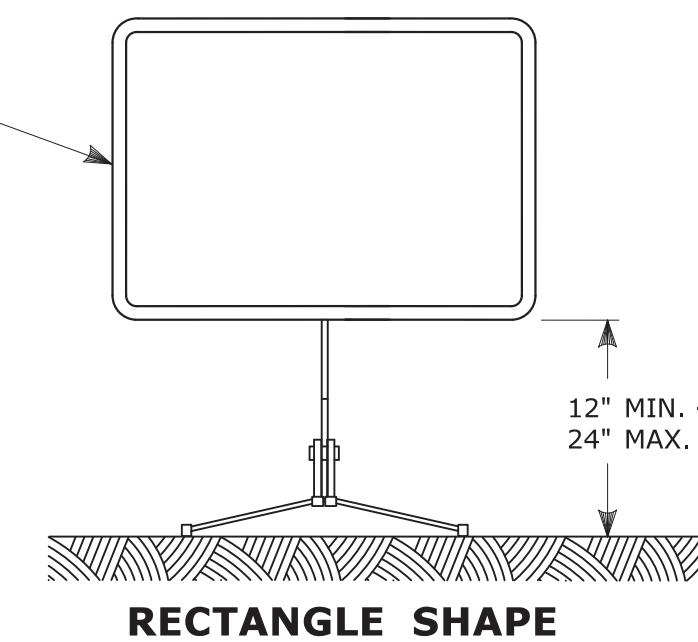
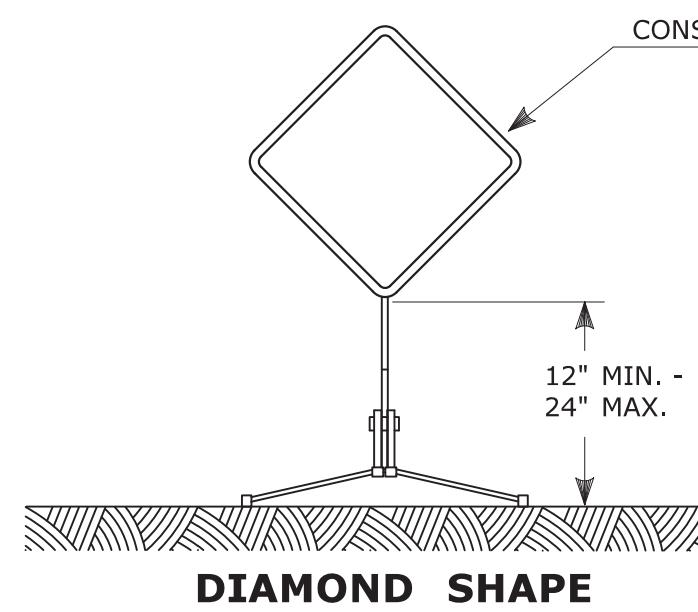
STANDARD SHEET TITLE:

**PAVEMENT MARKINGS
FOR NON FREEWAYS**

STANDARD SHEET NO.:

TR-1210_08

E5 - SERIES		G20 - SERIES		M4 - SERIES		R1 - SERIES		R9 & R11 - SERIES		W1 - SERIES		W3 - SERIES																																																																																																																													
 <p>COPY & BORDER - WHITE BACKGROUND - GREEN</p> <table border="1"> <thead> <tr> <th>AREA (SQ. FT)</th> <th>SIZE (INCHES)</th> <th>CONN. #</th> <th>POSTS</th> </tr> </thead> <tbody> <tr> <td>16.0</td> <td>48</td> <td>51-6147</td> <td>2</td> </tr> </tbody> </table>		AREA (SQ. FT)	SIZE (INCHES)	CONN. #	POSTS	16.0	48	51-6147	2	 <p>END ROAD WORK</p>		 <p>ROAD WORK NEXT 0 MILE(S) BE PREPARED TO STOP</p>		 <p>DETOUR</p>		 <p>STOP</p>		 <p>SIDEWALK CLOSED</p>		 <p>BOTH LANES SHIFT LEFT AHEAD (L)</p> <p>BOTH LANES SHIFT RIGHT AHEAD (R)</p>		 <p>STOP AHEAD</p>																																																																																																																			
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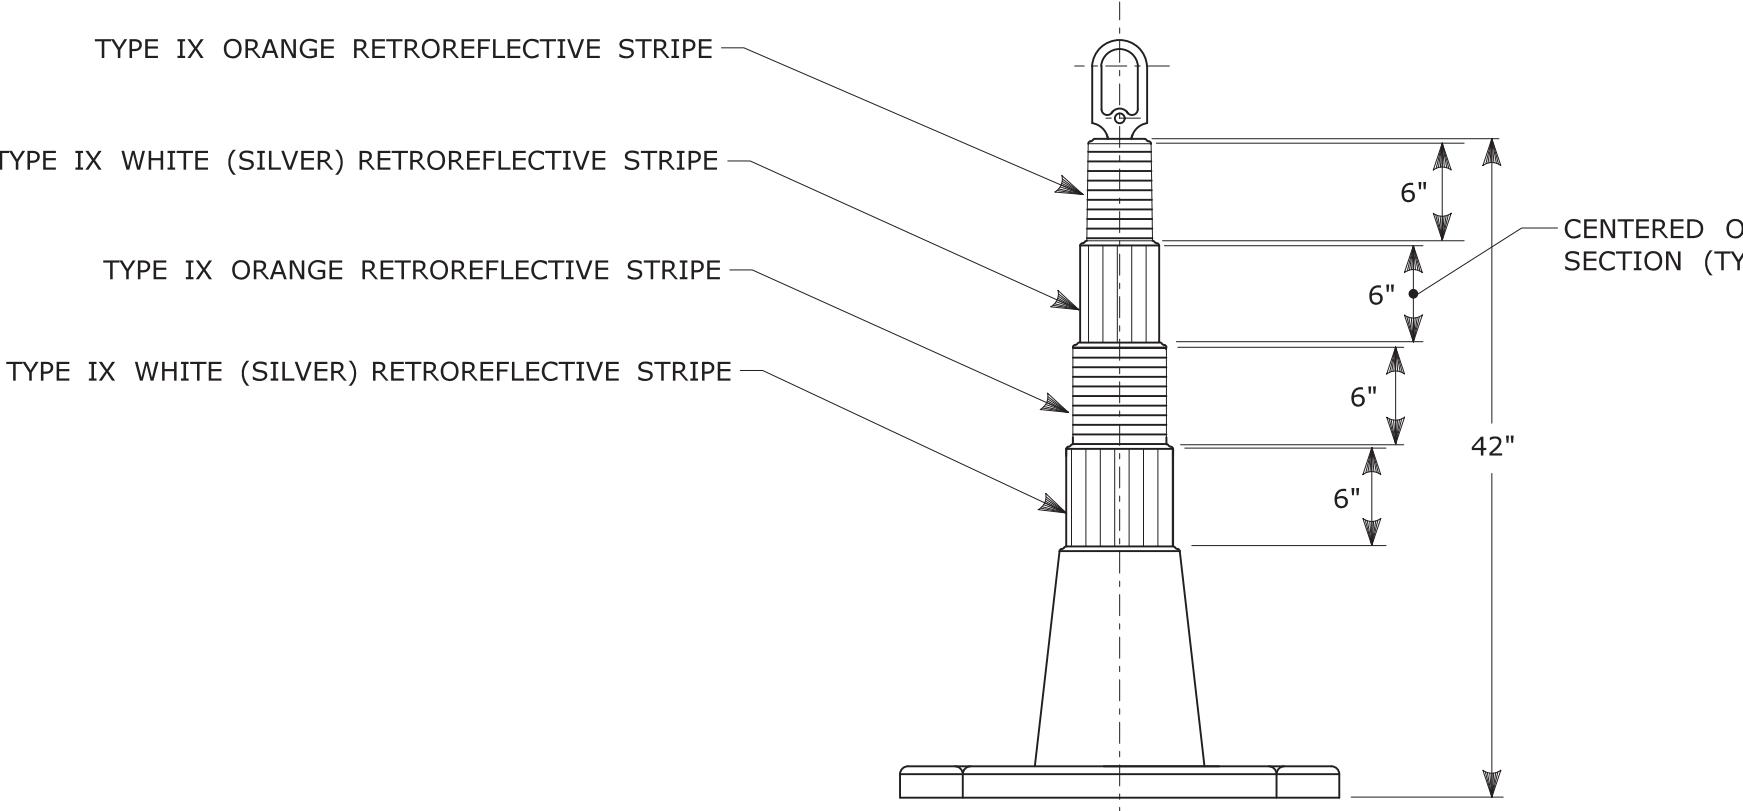


PORABLE CONSTRUCTION SIGNS

NOTES FOR PORTABLE SIGN SUPPORTS:

1. SIGNS AND THEIR PORTABLE SUPPORTS SHALL CONFORM TO THE REQUIREMENTS OF NCHRP REPORT 350 (TL-3) OR THE AASHTO MASH FOR CATEGORY 2 DEVICES AND THE LATEST EDITION OF THE MUTCD.
2. MOUNTING HEIGHT OF SIGNS SHALL BE A MINIMUM OF 12" AND A MAXIMUM OF 24". SIGNS SHALL BE MOUNTED HIGHER AS NEEDED TO MEET FIELD CONDITIONS OR AS DIRECTED BY THE ENGINEER.
3. THE ENGINEER RESERVES THE RIGHT TO REJECT ANY SUPPORT DEEMED UNSUITABLE FOR THE PURPOSE INTENDED.
4. PORTABLE SIGN SUPPORTS SHALL BE STABILIZED IN A MANNER THAT WILL NOT AFFECT THEIR COMPLIANCE WITH NCHRP REPORT 350 (TL-3) OR THE AASHTO MASH FOR CATEGORY 2 DEVICES.
5. PORTABLE CONSTRUCTION SIGN SUPPORTS SHOULD NOT BE USED FOR DURATION OF MORE THAN 3 DAYS EXCEPT FOR R9-8 THROUGH R9-11a SERIES, R11 SERIES, W1-6 THROUGH W1-8 SERIES, M4-10, AND E5-1. SEE STANDARD SHEET TR-1220-01 - "SIGNS FOR CONSTRUCTION AND PERMIT OPERATIONS" FOR SIGN DETAILS.


* FOR E5-1 (EXIT SIGNS) USE MIN 48".



42" TRAFFIC CONE

NOTES:


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2. IF RUBBER CONES ARE USED, THEY SHALL HAVE INTERIOR RIBS FOR RIGIDITY.
3. IF PLASTIC CONES ARE USED, THEY SHALL BE COLOR IMPREGNATED.
4. THE ENGINEER RESERVES THE RIGHT TO REJECT ANY CONE DEEMED UNSUITABLE FOR THE PURPOSE INTENDED.
5. THE ENTIRE AREA OF ORANGE AND WHITE STRIPES SHALL BE RETROREFLECTIVE SHEETING AS REQUIRED IN THE SPECIFICATIONS.
6. THE SECTIONS OF CONES NOT COVERED WITH RETROREFLECTIVE STRIPES SHALL BE ORANGE.

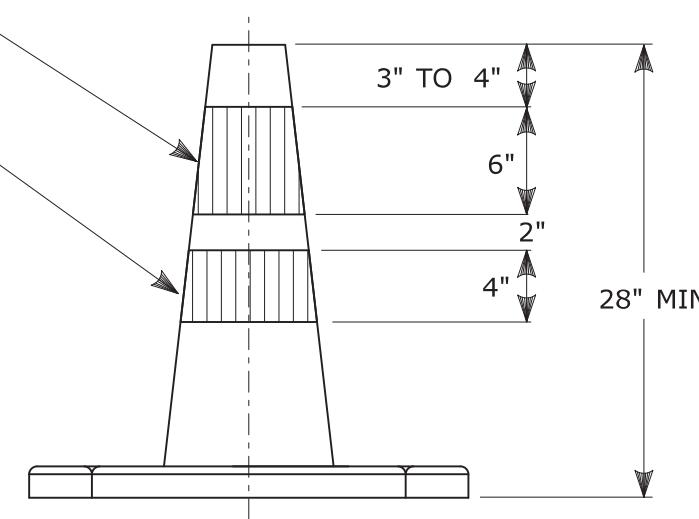


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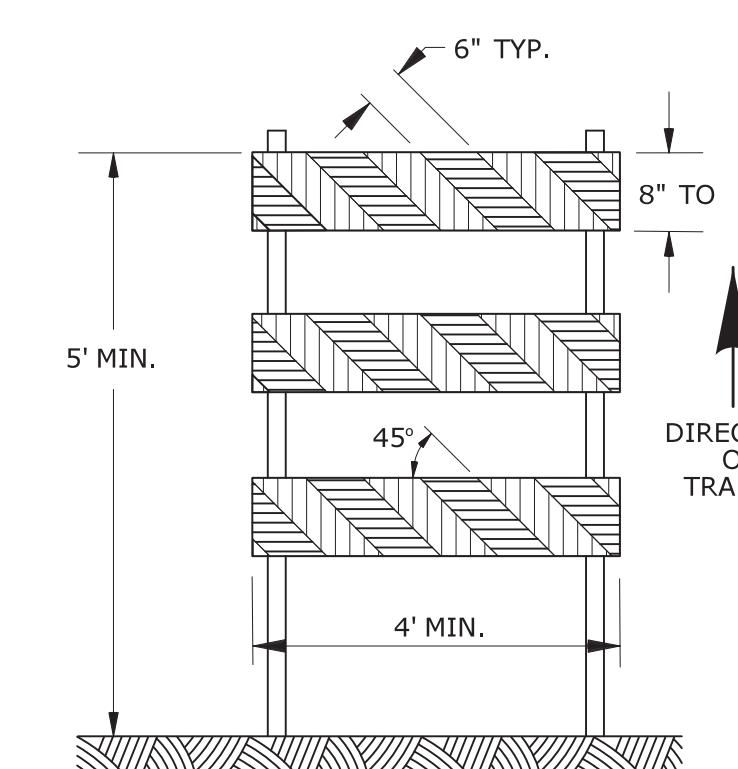
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4. THE ENGINEER RESERVES THE RIGHT TO REJECT ANY CONE DEEMED UNSUITABLE FOR THE PURPOSE INTENDED.
5. TRAFFIC CONES NOT USED AT NIGHT MAY UTILIZE TYPE III SHEETING.
6. THE SECTIONS OF CONES NOT COVERED WITH RETROREFLECTIVE STRIPES SHALL BE ORANGE.



TYPE I BARRICADE

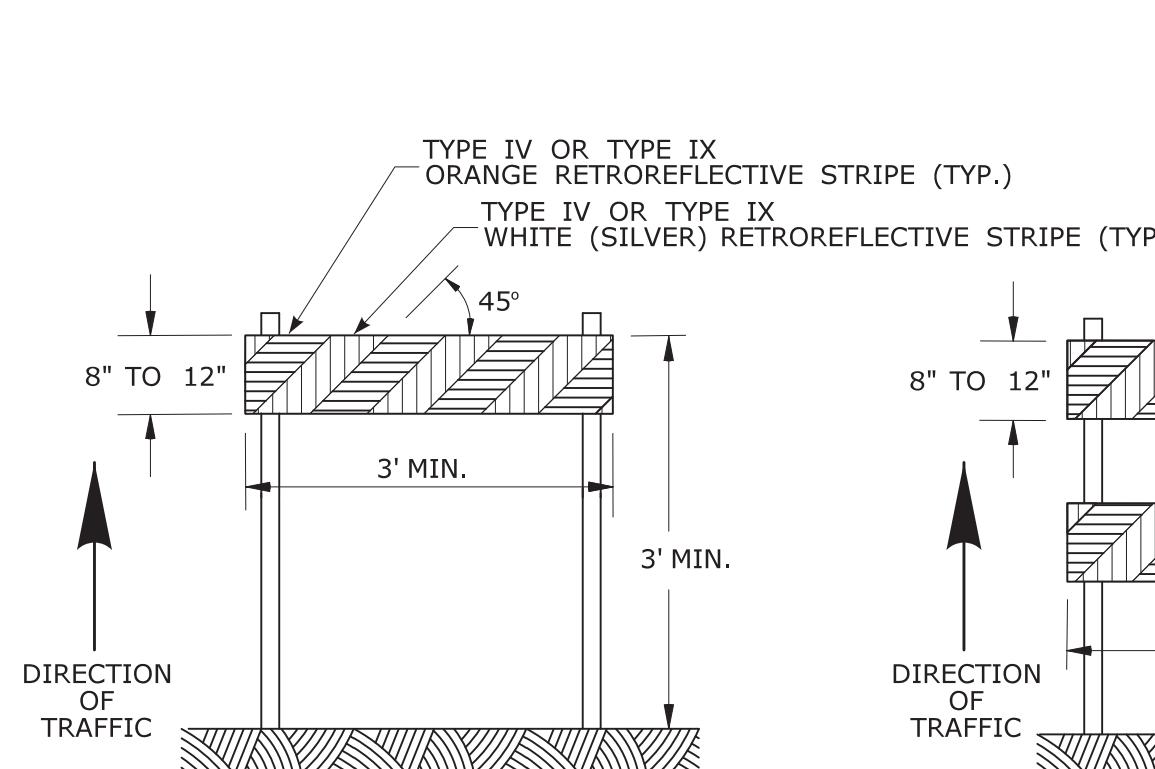

TYPE II BARRICADE

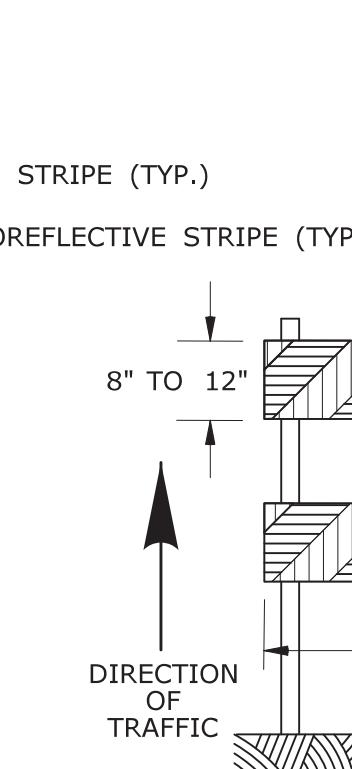


TYPE III BARRICADE

CONSTRUCTION BARRICADES

NOTES:

1. CONSTRUCTION BARRICADES SHALL CONFORM TO THE REQUIREMENTS OF NCHRP REPORT 350 (TL-3) OR THE AASHTO MASH AND THE LATEST EDITION OF THE MUTCD.
2. MARKINGS FOR BARRICADE RAILS SHALL BE ALTERNATE ORANGE AND WHITE STRIPES SLOPING DOWNWARD IN THE DIRECTION TRAFFIC IS TO PASS. 6" WIDE STRIPES SHALL BE USED.
3. THE ENTIRE AREA OF ORANGE AND WHITE STRIPES SHALL BE RETROREFLECTIVE SHEETING AS REQUIRED IN THE SPECIFICATIONS. THE SIDES OF BARRICADES FACING TRAFFIC SHALL HAVE RETROREFLECTIVE RAIL FACES.
4. THE ENGINEER RESERVES THE RIGHT TO REJECT ANY BARRICADE DEEMED UNSUITABLE FOR THE PURPOSE INTENDED.
5. CORNERS OF BARRICADE RAILS SHALL BE ROUNDED.
6. SIGNS MAY ONLY BE INSTALLED ON TYPE III BARRICADES AND SHALL BE PLACED SO AS TO COVER NO MORE THAN ONE BARRICADE RAIL.

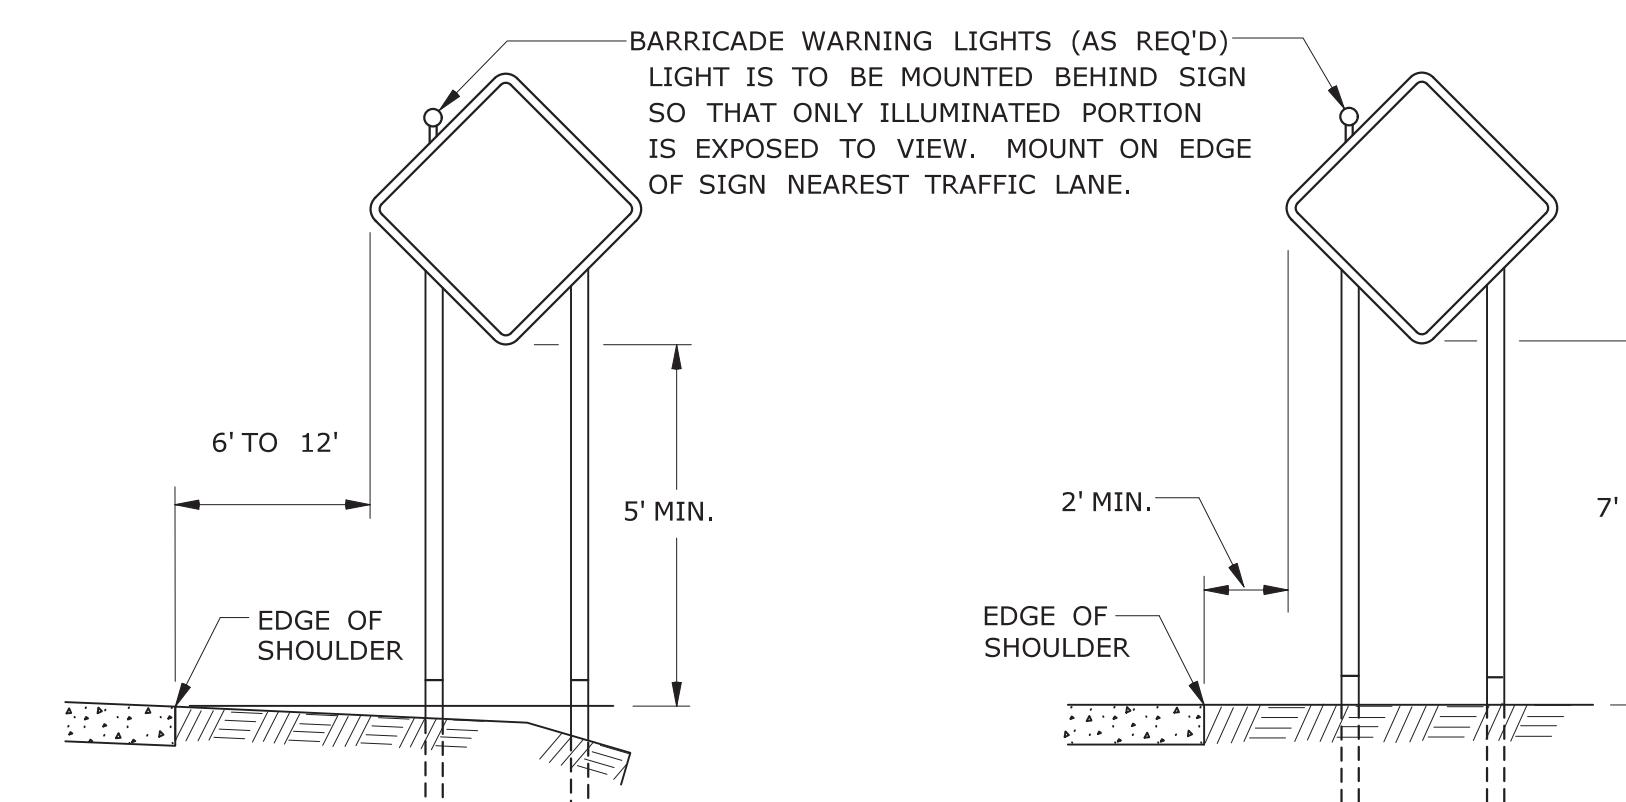


RURAL AREA

URBAN AREA

PLACEMENT OF CONSTRUCTION SIGNS TYPICAL LONG TERM INSTALLATION

NOTES:

SUPPORTS SHALL BE METAL SIGN POSTS AND HAVE BREAK-AWAY FEATURES.
SEE TYPICAL SHEETS:
"TYPICAL SIGN SUPPORT AND SIGN PLACEMENT DETAILS-GORE EXIT SIGN"
"TYPICAL METAL SIGN POSTS AND SIGN MOUNTING DETAILS"

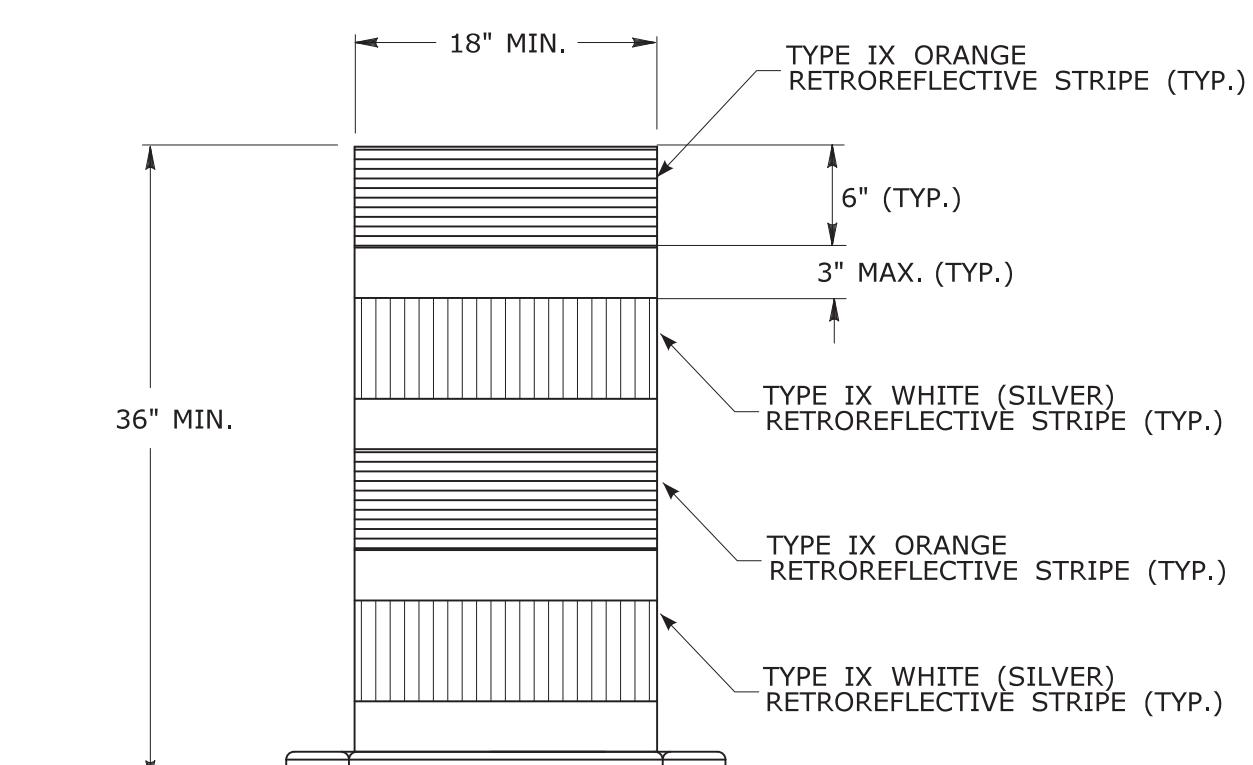

TRAFFIC DRUM
FRONT VIEW


NOTES:

1. TRAFFIC DRUM SHALL CONFORM TO THE REQUIREMENTS OF NCHRP REPORT 350 (TL-3) OR THE AASHTO MASH FOR CATEGORY 1 DEVICES AND THE LATEST EDITION OF THE MUTCD.
2. THE ENGINEER RESERVES THE RIGHT TO REJECT ANY DRUM DEEMED UNSUITABLE FOR THE PURPOSE INTENDED.
3. THE ENTIRE AREA OF ORANGE AND WHITE STRIPES SHALL BE RETROREFLECTIVE SHEETING AS REQUIRED IN THE SPECIFICATIONS.
4. THE SECTIONS OF DRUMS NOT COVERED WITH RETROREFLECTIVE STRIPES SHALL BE ORANGE.

2	8-2015	UPDATED PER MUTCD AND FORM 816 JAN 2015 REVISION.
1	2-2011	MINOR REVISIONS.
REV. DATE	REVISION DESCRIPTION	Plotted Date: 8/14/2015

THE INFORMATION, INCLUDING ESTIMATED QUANTITIES OF WORK, SHOWN ON THESE SHEETS IS BASED ON LIMITED INVESTIGATIONS BY THE STATE, AND IS UNPREDICTABLE. IT IS NOT TO INDICATE THE CONDITIONS OF ACTUAL QUANTITIES OF WORK WHICH WILL BE REQUIRED.

NOT TO SCALE

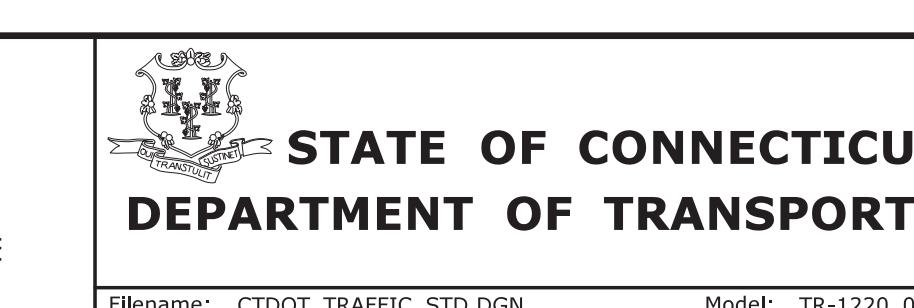

SUBMITTED BY:	NAME/DATE/TIME:
	Mark F. Makuch, P.E. 2015.08.26 07:15:47-04'00'
APPROVED BY:	NAME/DATE/TIME:
	Charles S. Harlow, P.E. 2015.08.28 11:40:57-04'00'

STANDARD SHEET TITLE:
CTDOT
STANDARD SHEET
OFFICE OF ENGINEERING

CONSTRUCTION SIGN SUPPORTS
AND CHANNELIZING DEVICES

STANDARD SHEET NO.:
TR-1220_02